SHEET#	SHEET TITLE	PERMIT 04.13.2022	BID SET 08.15.2022	ENG CHANGE
GENERAL D	PAWINGS			
A0.00	COVER SHEET			
A0.01	EGRESS & FIRE RATING DIAGRAMS			
A0.02	CODE SUMMARY			
A0.03	GENERAL NOTES + SPECS SCAPE DRAWINGS			
C-01	OVERALL SITE PLAN			
ARCHITECT	URAL DRAWINGS			
A0.10	ARCHITECTURAL SITE PLAN			
AD1.00 AD1.01	EXISTING / DEMOLITION PLAN - BASEMENT EXISTING / DEMOLITION PLAN - FIRST FLOOR			
AD1.02	EXISTING / DEMOLITION PLAN - SECOND FLOOR			
AD1.03	EXISTING / DEMOLITION PLAN - THIRD FLOOR			
AD1.04	EXISTING / DEMOLITION PLAN - FOURTH FLOOR			
AD1.05 AD1.06	EXISTING / DEMOLITION PLAN - FIFTH FLOOR EXISTING / DEMOLITION PLAN - ROOF			
AD1.06 AD2.01	EXISTING / DEMOLITION FLAN - ROOF EXISTING / DEMOLITION ELEVATION - SOUTH (FRONT)			
AD2.02	EXISTING / DEMOLITION ELEVATION - WEST (SIDE)			
AD2.03	EXISTING / DEMOLITION ELEVATION - NORTH (REAR)			
AD2.04	EXISTING / DEMOLITION ELEVATION - EAST LIGHTWELL			
AD2.05 A1.10	PROPOSED PLAN - BASEMENT			
AI.II	PROPOSED PLAN - FIRST FLOOR			
A1.12	PROPOSED PLAN - SECOND FLOOR			
A1.13	PROPOSED PLAN - THIRD FLOOR			
A1.14 A1.15	PROPOSED PLAN - FOURTH FLOOR PROPOSED PLAN - FIFTH FLOOR			
A1.16	PROPOSED PLAN - ROOF			
A1.20	REFLECTED CEILING PLAN - BASEMENT			
A1.21	REFLECTED CEILING PLAN - FIRST FLOOR			
A1.22 A1.23	REFLECTED CEILING PLAN - SECOND FLOOR REFLECTED CEILING PLAN - THIRD FLOOR			
A1.23	REFLECTED CEILING PLAN - FOURTH FLOOR			
A1.25	REFLECTED CEILING PLAN - FIFTH FLOOR			
A2.11	PROPOSED ELEVATION - SOUTH (FRONT)			
A2.12 A2.13	PROPOSED ELEVATION - WEST (SIDE) PROPOSED ELEVATION - NORTH (REAR)			
A2.13	PROPOSED ELEVATION - FAST LIGHTWELL			
A2.15	PROPOSED ELEVATION - WEST LIGHTWELL			
A3.01	STAIR DETAILS			
A3.02 A3.03	STAIR DETAILS STAIR DETAILS			
A3.04	STAIR DETAILS			
A4.00	FINISH SCHEDULES			
A4.01	FINISH SCHEDULES			
A4.10 A4.20	ENLGD PLANS + INTERIOR ELEVS - COMMERCIAL ENLGD PLANS + INTERIOR ELEVS - RESIDENTIAL KITCHENS			
A4.21	ENLGD PLANS + INTERIOR ELEVS - RESIDENTIAL KITCHENS			
A4.30	ENLGD PLANS + INTERIOR ELEVS - RESIDENTIAL BATHS			
A4.31	ENLGD PLANS + INTERIOR ELEVS - RESIDENTIAL BATHS			
A5.00	DETAILS FIRE RATING DETAILS			
A5.01 A6.00	PARTITION TYPES			
A6.01	ASSEMBLIES			
A6.10	DOOR SCHEDULE			
A6.11	DOOR TYPES			
A6.20 A6.21	WINDOW TYPES WINDOW DETAILS			
A7.00	LEED SPECIFICATIONS			
A7.01	LEED SPECIFICATIONS			
A7.02	LEED SPECIFICATIONS			
A7.03 A8.10	LEED SPECIFICATIONS COLORED ELEVATION - SOUTH			
A8.11	COLORED ELEVATION - WEST			
A8.12	COLORED ELEVATION - NORTH			
	AL DRAWINGS STRUCTURAL NOTES			
S001 S100	STRUCTURAL NOTES FOUNDATION PLAN			
\$110	FIRST FLOOR FRAMING PLAN			
\$120	SECOND FLOOR FRAMING PLAN			
\$130	THIRD FLOOR FRAMING PLAN			
S140 S150	FOURTH FLOOR FRAMING PLAN ATTIC/LOW ROOF FRAMING PLAN			
\$160	ROOF FRAMING PLAN			
S200	ELEVATIONS			
S201	ELEVATIONS			
S202 S203	ELEVATIONS ELEVATIONS			
S204	ELEVATIONS			
\$310	STRUCTURAL DETAILS			
S203 S204	ELEVATIONS ELEVATIONS			

DRAWING INDEX SHEET# SHEET TITLE PLUMBING DRAWINGS PI00 BASEMENT PLUMBING PLAN FIRST FLOOR PLUMBING PLAN SECOND FLOOR PLUMBING PLAN THIRD FLOOR PLUMBING PLAN FOURTH FLOOR PLUMBING PLAN ATTIC PLUMBING PLAN P105 ROOF PLUMBING PLAN FIRST FLOOR WATER & GAS PLAN SECOND FLOOR WATER & GAS PLAN THIRD FLOOR WATER & GAS PLAN FOURTH FLOOR WATER & GAS PLAN ATTIC WATER & GAS PLAN PIII SANITARY ISOMETRIC P200 PLUMBING DETAILS P201 P300 PLUMBING NOTES MECHANICAL DRAWINGS NORTH LOT -M100 BASEMENT MECHANICAL PLAN FIRST FLOOR MECHANICAL PLAN SECOND FLOOR MECHANICAL PLAN THIRD FLOOR MECHANICAL PLAN FOURTH FLOOR MECHANICAL PLAN ATTIC MECHANICAL PLAN ROOF MECHANICAL PLAN MECHANICAL SCHEDULES MECHANICAL DETAILS M300 MECHANICAL NOTES **ELECTRICAL DRAWINGS** E100 BASEMENT POWER PLAN FIRST FLOOR POWER PLAN SECOND FLOOR POWER PLAN

THIRD FLOOR POWER PLAN

ATTIC POWER PLAN

ROOF POWER PLAN

ATTIC LIGHTING PLAN

PANEL SCHEDULES

SPECIFICATIONS

E105

E106

FOURTH FLOOR POWER PLAN

FIRST FLOOR LIGHTING PLAN

THIRD FLOOR LIGHTING PLAN

FOURTH FLOOR LIGHTING PLAN

ELECTRICAL SCHEDULES & DETAILS

SECOND FLOOR LIGHTING PLAN

I 16 W. ELDER STREET

CINCINNATI, OH 45202

FINDLAY EXCHANGE RENOVATION

CONTRACTOR

MODEL CONSTRUCTION

1826 RACE STREET

CINCINNATI, OH 45202

(513) 559-0048

PROJECT LOCATION —

STRUCTURAL ENGINEER

ADVANTAGE GROUP 1527 MADISON ROAD, FL 2

CINCINNATI, OH 45206

(513) 396-8900

MEP ENGINEER

- FINDLAY MARKET

MARQUE ENGINEERING 2230 PARK AVENUE, SUITE 100 CINCINNATI, OH 45206 (513) 457-7131

CIVIL ENGINEER

GENESIS DESIGN, LLC. 3439 WELLSTON PLACE CINCINNATI, OH 45208 (513) 703-2889

ARCHITECT

House of Hope

The Empanadas Box 😗

leven/Seventy-Nine

PLATTE DESIGN 1810 CAMPBELL ALLEY, STE 300 CINCINNATI, OH 45202 (513) 871-1850

DEVELOPER

MODEL GROUP 1826 RACE STREET CINCINNATI, OH 45202 (513) 559-0048

STREET VIEW

Progress Dates 08.15.2022 - BID SET

05.26.2022 - PERMIT REV I 06.15.2022 - PERMIT REV 2 08.19.2023 - ENG CHANGE I

MR, TB, SO, MR Drawn by: TB, MR

Job No: 22005 02.25.2022


PROJECT DESCRIPTION

EXPANSION JOINT

N.I.S. NOT IN SCOPE

THIS PROJECT IS THE REHABILITATION/RENOVATION OF AN EXISTING HISTORIC COMMERCIAL / RESIDENTIAL BUILDING. THE BUILDINGS WERE ORIGINALLY TWO SEPARATE STRUCTURES (112-114 W. ELDER & 116 W. ELDER), BUT THEY ARE NOW CONNECTED AND CURRENTLY OPERATE AS ONE BUILDING. THE PARCELS WERE PREVIOUSLY CONSOLIDATED. THE BUILDING IS 4-5 STORIES WITH A FULL BASEMENT. THE BASEMENT WILL REMAIN UNOCCUPIED. THE FIRST FLOOR WILL REMAIN OCCUPIED AND WILL MAINTAIN B & A-2 USES. THE UPPER FLOORS WILL BE USE R-2 APARTMENTS. THE 5TH FLOOR WILL REMAIN AN UNOCCUPIED ATTIC.

TYPICAL ABBREVIATIONS							TYPICAL SYMBOLS		
ADJ	ADJACENT	EQ	EQUAL	N.T.S.	NOT TO SCALE	^			
A.F.F.	ABOVE FINISH FLOOR	EXG	EXISTING	OBC	OHIO BUILDING CODE	$\langle \mathbf{q} \rangle$	NORTH ARROW		
LT.	ALTERNATE	EXT	EXTERIOR	O.C.	ON CENTER	_	ECDECC VA/INIDOVA/		
ALUM	ALUMINUM	FDC	FIRE DEPARTMENT	OPNG	OPENING		EGRESS WINDOW		
	APPROXIMATELY		CONNECTION	OPP	OPPOSITE		KEWNOTE		
\PT	APARTMENT	FDN	FOUNDATION	0/	OVER	01	KEYNOTE		
D	BOARD	F.E.	FIRE EXTINGUISHER	PLWD	PLYWOOD	_	CENTER IN IE TA C		
BLDG	BUILDING	F.F.E.	FINISH FLOOR ELEVATION		PLUMBING	— – —	CENTERLINE TAG		
C.L.	CENTER LINE	FLR	FLOOR	PT.	PRESSURE TREATED	X'-X"	51 0 0 D 51 51 (4 510) 1 5 4 0		
C.J.	CONTROL JOINT	FTG	FOOTING	RCP	REFLECTED CEILING PLAN	<u> </u>	FLOOR ELEVATION TAG		
CĹG	CEILING	G.C.	GENERAL CONTRACTOR	REQ	REQUIRED		PEN ((8) ON 1 ON		
CLR	CLEAR DIMENSION	GYP	GYPSUM	REV	REVISED/REVISION	(,,,,) ;	REVISION CLOUD TAG		
C.M.U.	CONCRETE MASONRY	H.M.	HOLLOW METAL	R.O.	ROUGH OPENING		,		
	UNIT	HR	HOUR	R.O.W.	RIGHT OF WAY		dwg #		
COL.	COLUMN	HORIZ	HORIZONTAL	SECT	SECTION		sheet #		
CONC	CONCRETE	HVAC	HEATING, VENTILATION,	&SIM	SIMILAR		A2.01 ELEVATION TAG		
CONT	CONTINUOUS/		AIR CONDITIONING	SF	SQUARE FEET				
	CONTINUED	INCL	INCLUDED/ INCLUDING	SPEC	SPECIFICATION	X	dwg#		
CONTR	CONTRACTOR	INFO	INFORMATION	STRUCT	STRUCTURAL		sheet #		
DIAG	DIAGONAL	INSUL	INSULATED/ INSULATING	T.O. or T/	TOP OF				
DIA or Ø	DIAMETER	INT	INTERIOR	T&G	TONGUE & GROOVE	X A4.01 X	INTERIOR ELEVATION TAG		
OIM(S)	DIMENSION(S)	L.L.	LIVE LOAD	TYP	TYPICAL		— dwg #		
D.O.T.E.	DEPARTMENT OF	MATL	MATERIAL	U.N.O.	UNLESS NOTED		dwg # sheet #		
	TRANSPORTATION &	MECH	MECHANICAL		OTHERWISE	^	/ 1/ \/		
	ENGINEERING	MEP	MECHCANICAL,	V.B.	VAPOR BARRIER		A3.01 SECTION CUT TAG		
D.L.	DEAD LOAD		ELECTRICAL, AND	VERT	VERTICAL				
D.S.	DOWNSPOUT		PLUMBING		VERIFY IN FIELD		dwg#		
OTL(S)	DETAIL(S)	MIN	MINIMUM	W/	WITH	//	sheet #		
DWG(S)	DRAWING(S)	MAX	MAXIMUM	W/O	WITHOUT		DETAIL CALLOUT		
Α (υ)	EACH	MANUF	MANUFACTURER	WD	WOOD	\A5.00 ∕ ▲			
LEC	ELECTRICAL	N/A	NOT APPLICABLE						
LEV(S)	ELEVATION(S)	N.I.C.	NOT IN CONTRACT						
·(-)	=== · · · · · · · · · · · · · · · · · ·					—	<u>~~</u> ~		

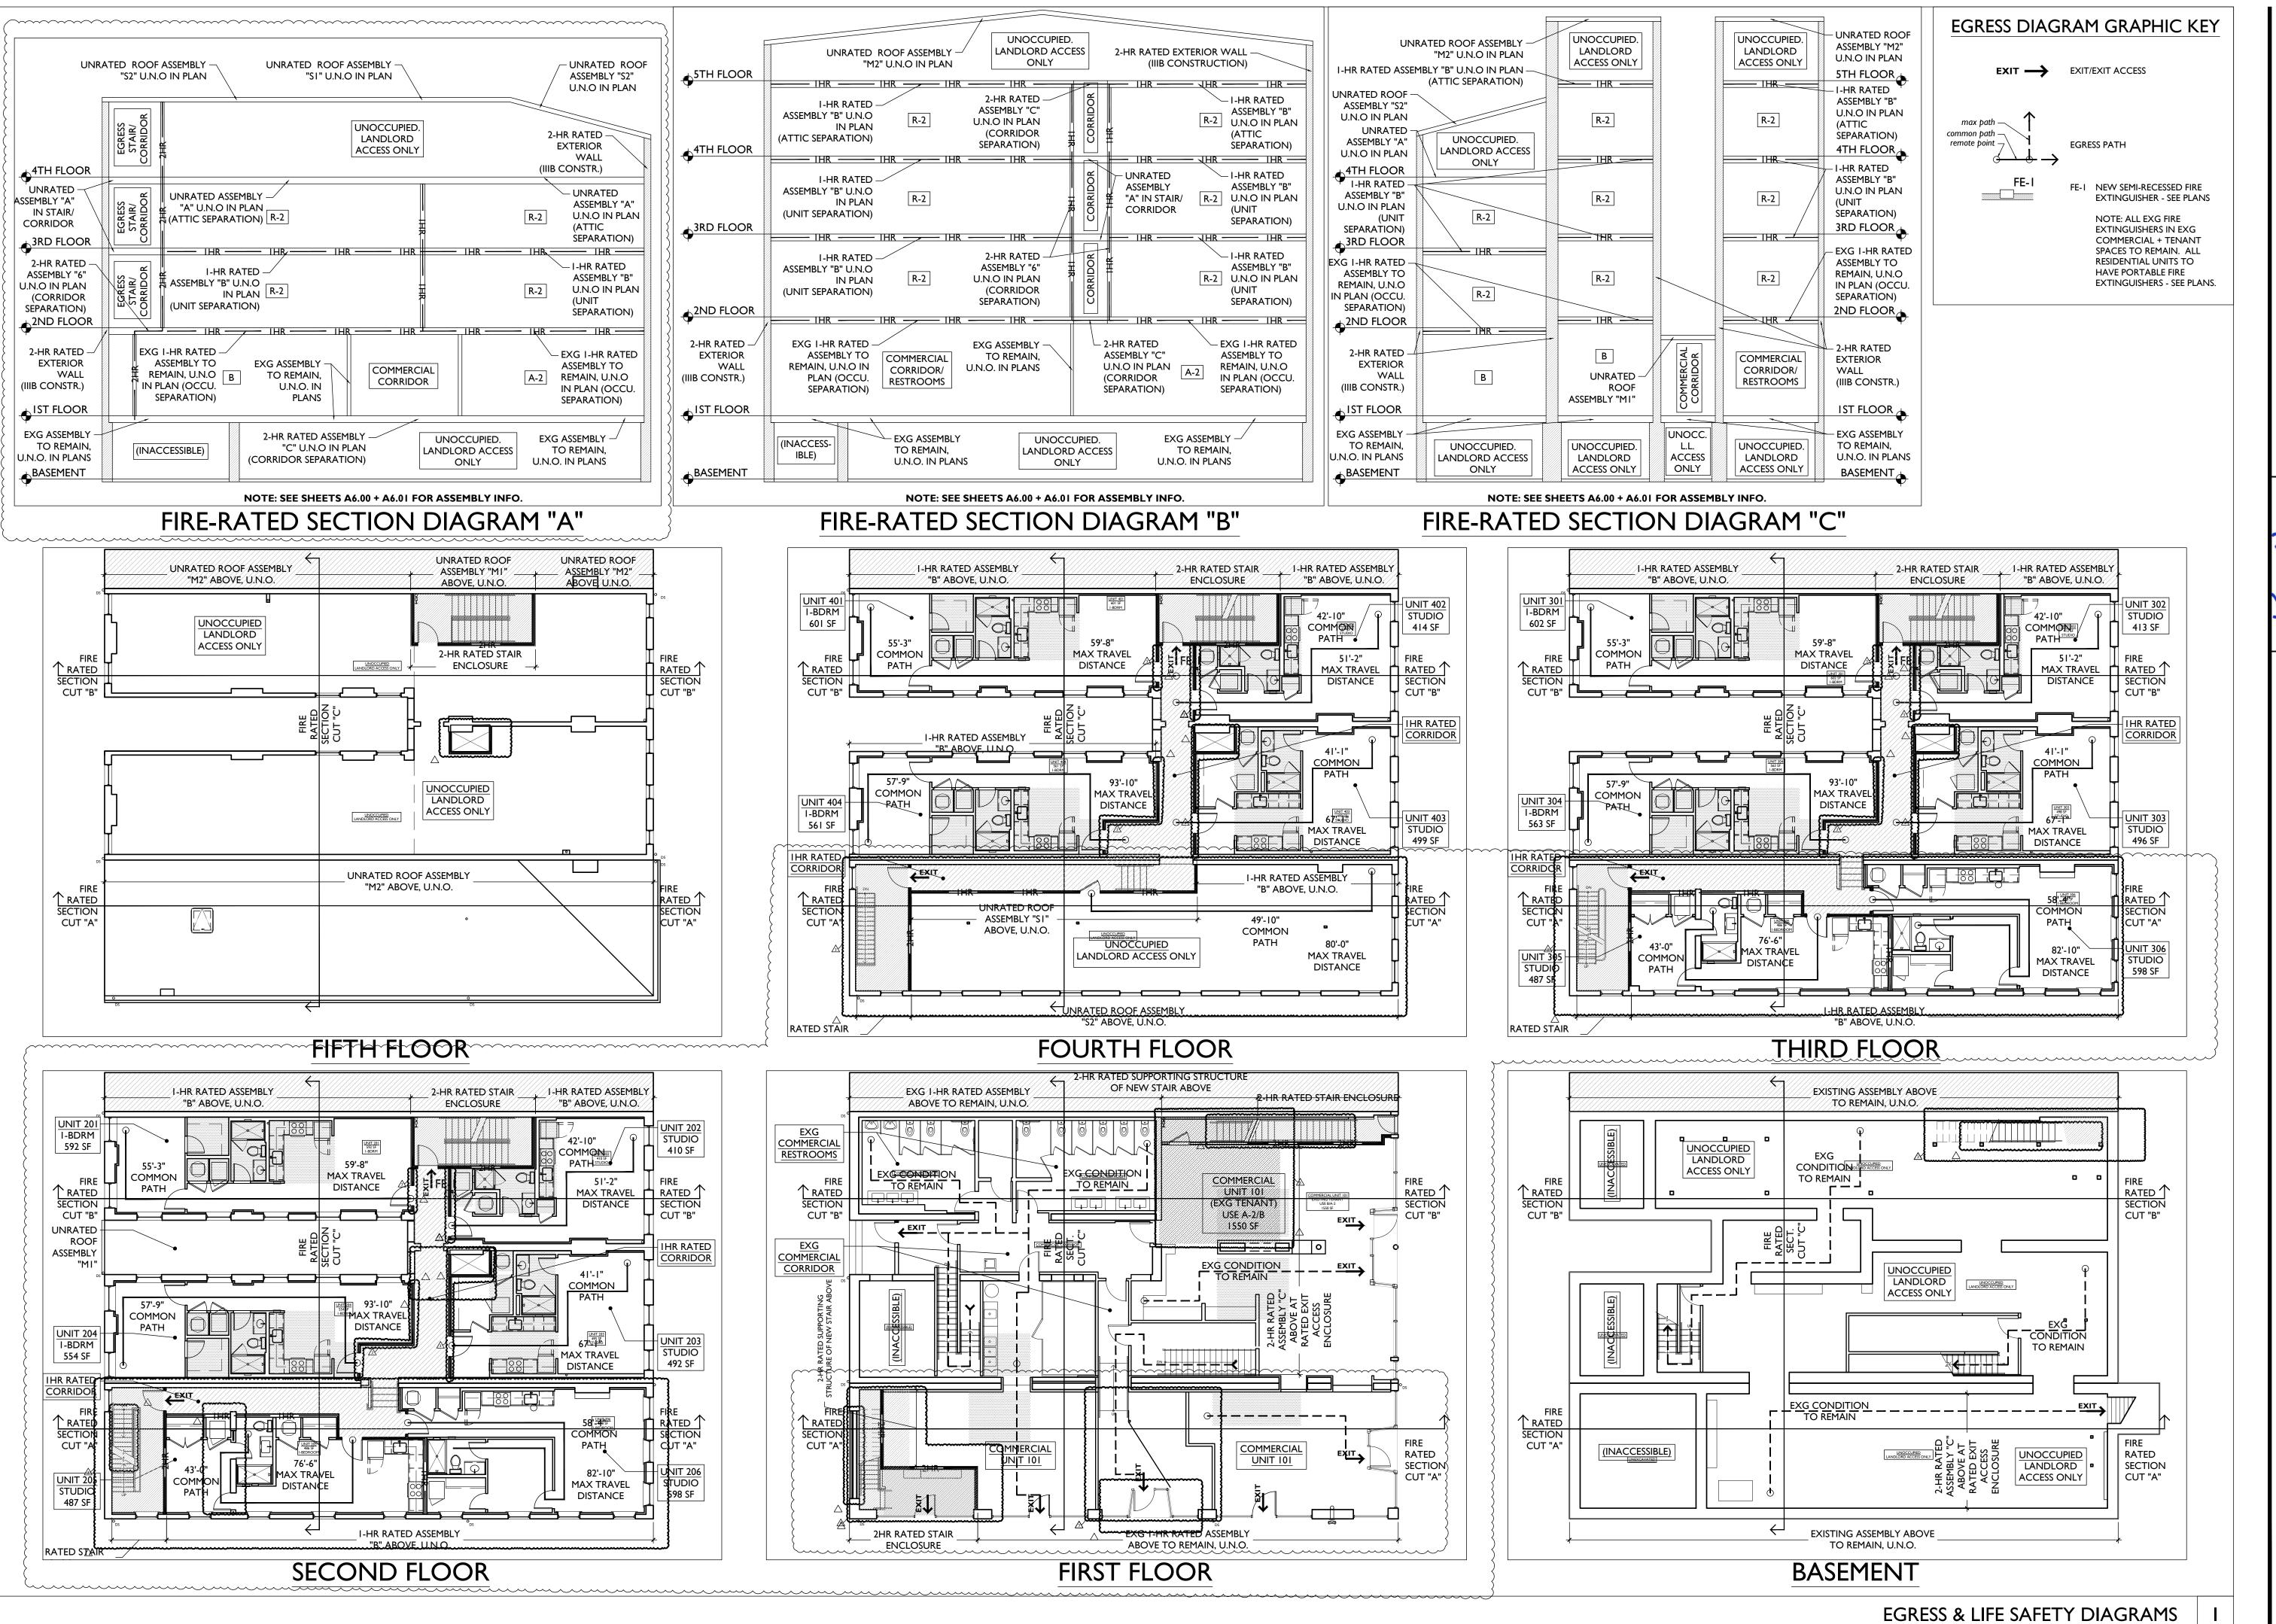

PLATTE architecture + design

KURT KURT 10833 10833 WWW

Progress Dates
08.15.2022 - BID SET

Revisions

05.26.2022 - PERMIT REV I 06.15.2022 - PERMIT REV 2 08.19.2023 - ENG CHANGE I

Design Team: MR, TB, SO, MR Drawn by: TB, MR

V. ELDER STREET

RENOVATION FOR:

RENOVATION FOR:

RENOVATION FOR:

RENOVATION FOR:

FINDLAY EXCHANGE

A0.01



8.5. REMOVE NON-HISTORIC DOOR AND

9.2. REMOVE EXG TILE FLOORING. NON-HISTORIC SHEATHING/ FLOORING ABOVE. SEE NEW WORK PLANS AND FINISH SCHEDULE FOR

23.1. EXG CONDENSING UNITS FOR EXG


— – EXISTING STRUCTURAL MEMBER.

STATE ELEVATION TAG.

Progress Dates 08.15.2022 - BID SET

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MR, TB, SO, MR Drawn by: TB, MR

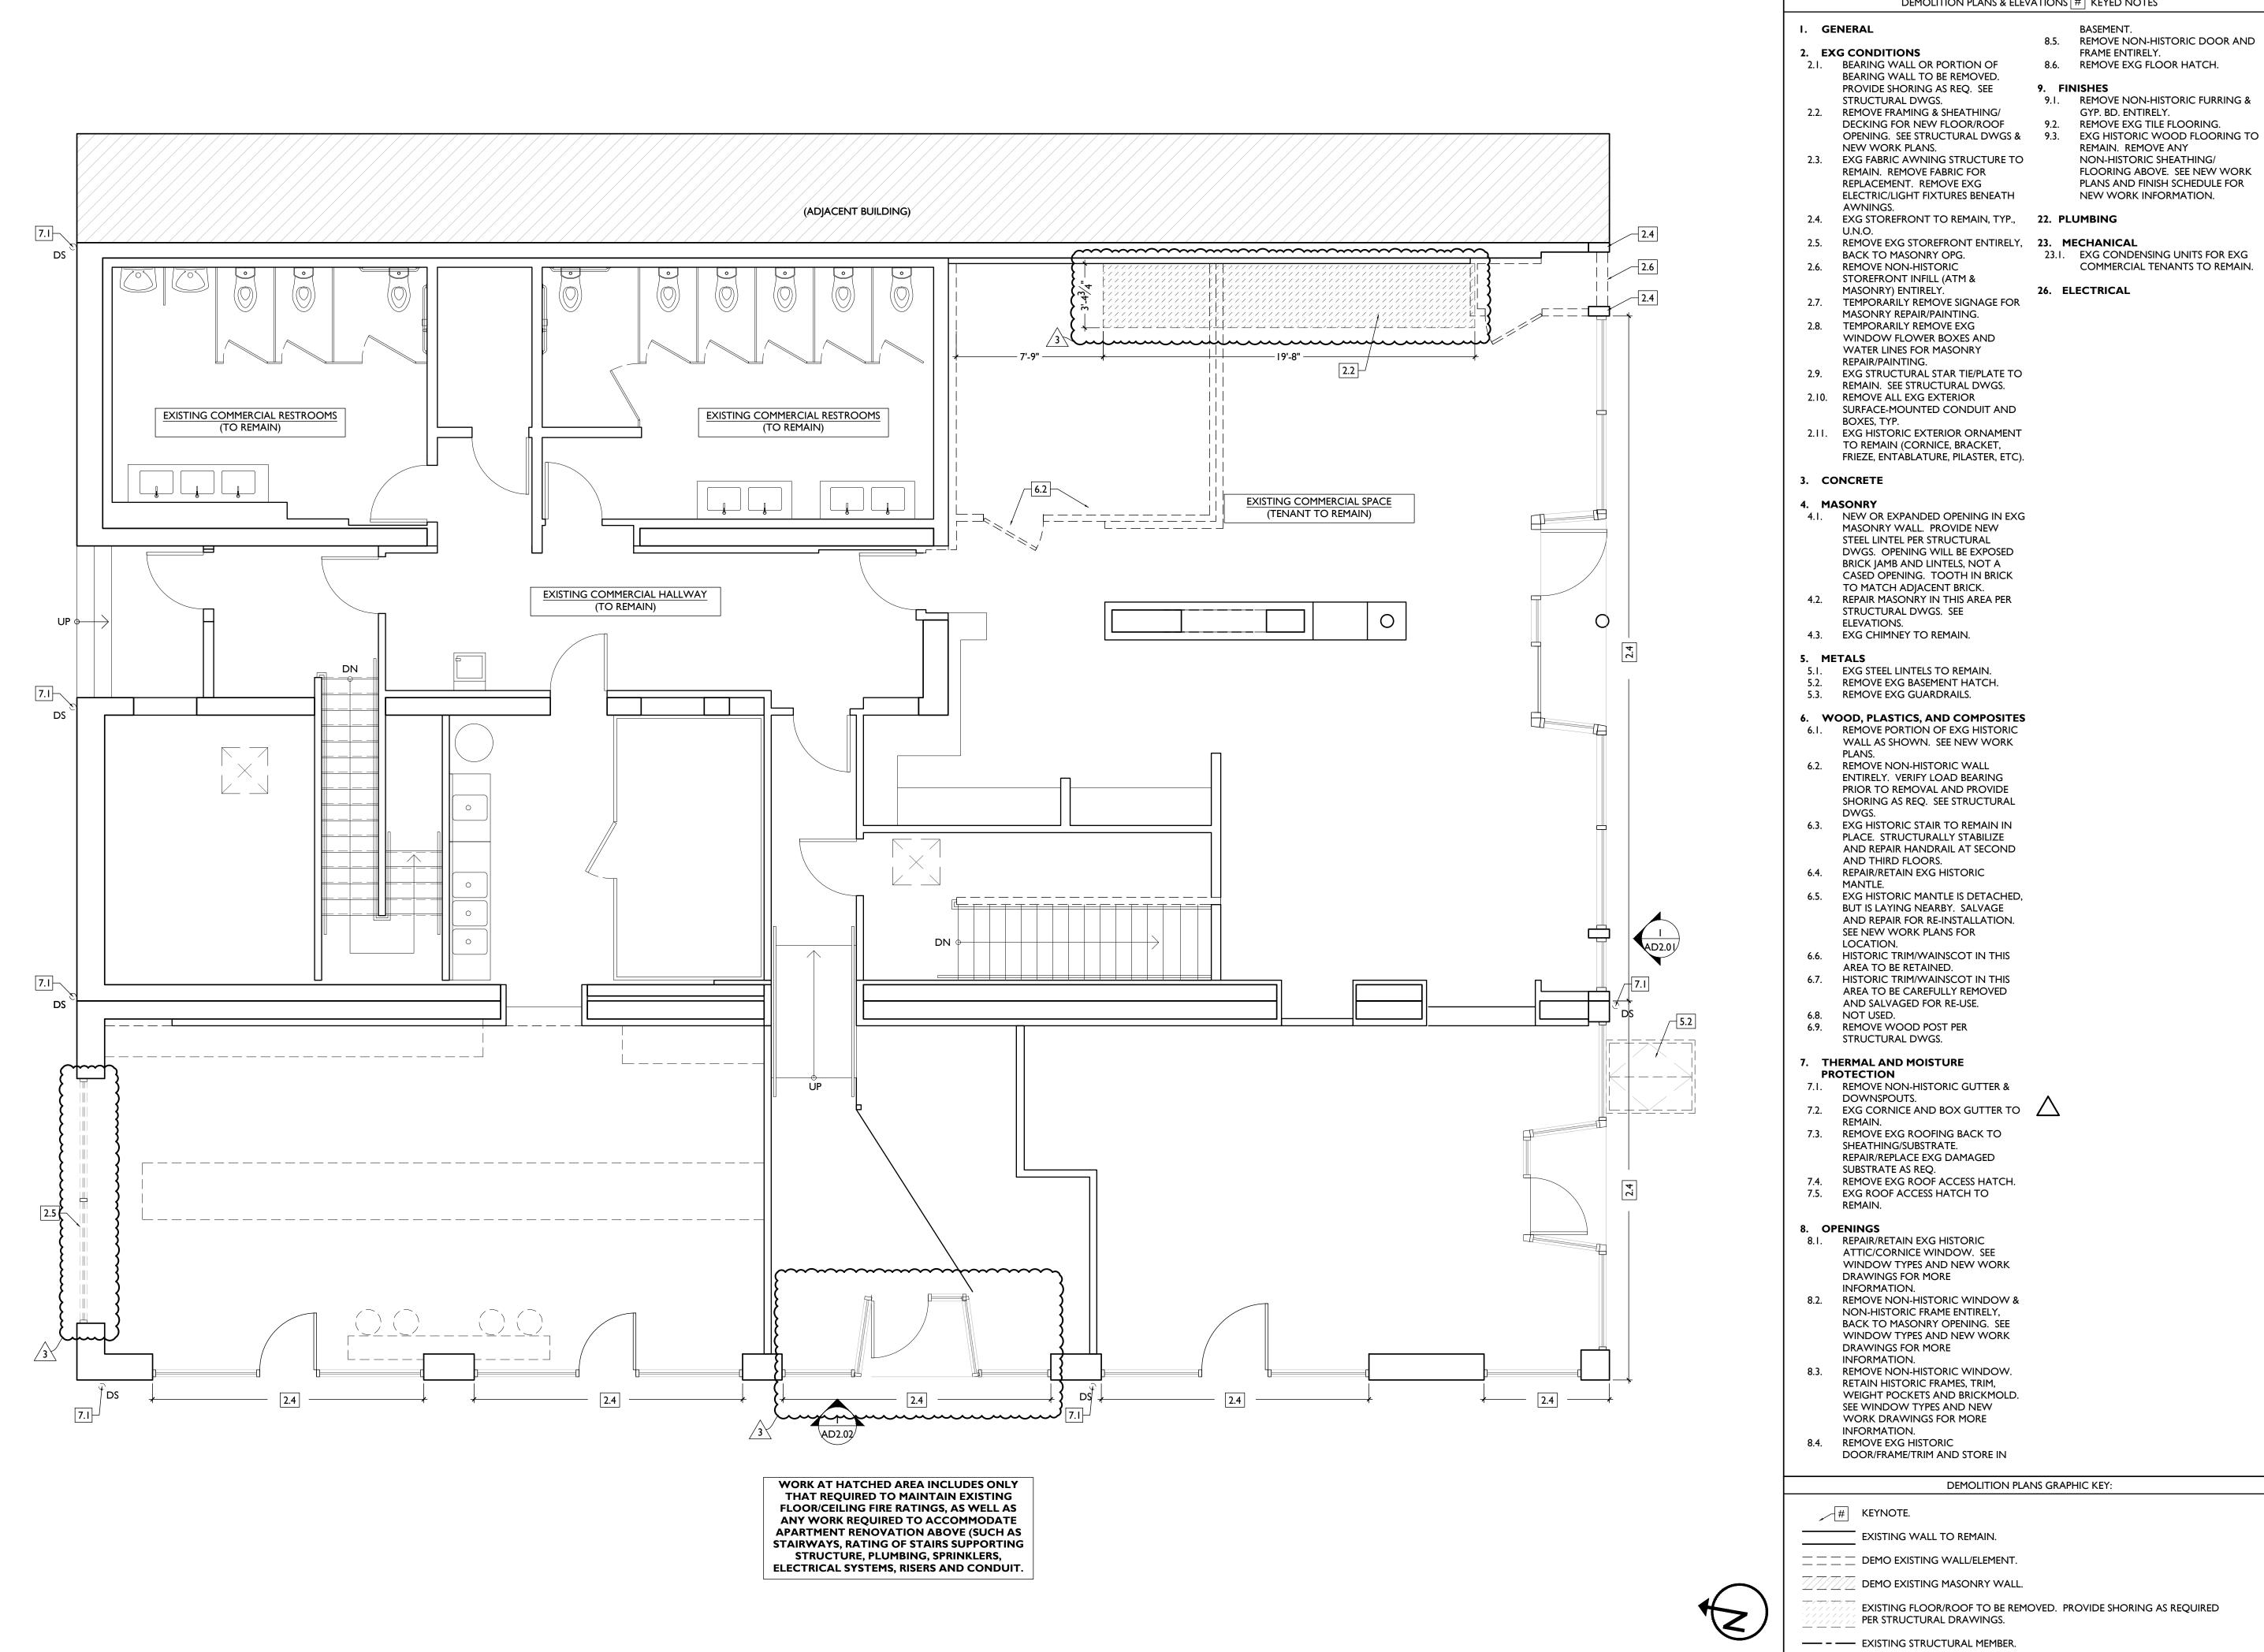


◆X'-X" ELEVATION TAG.

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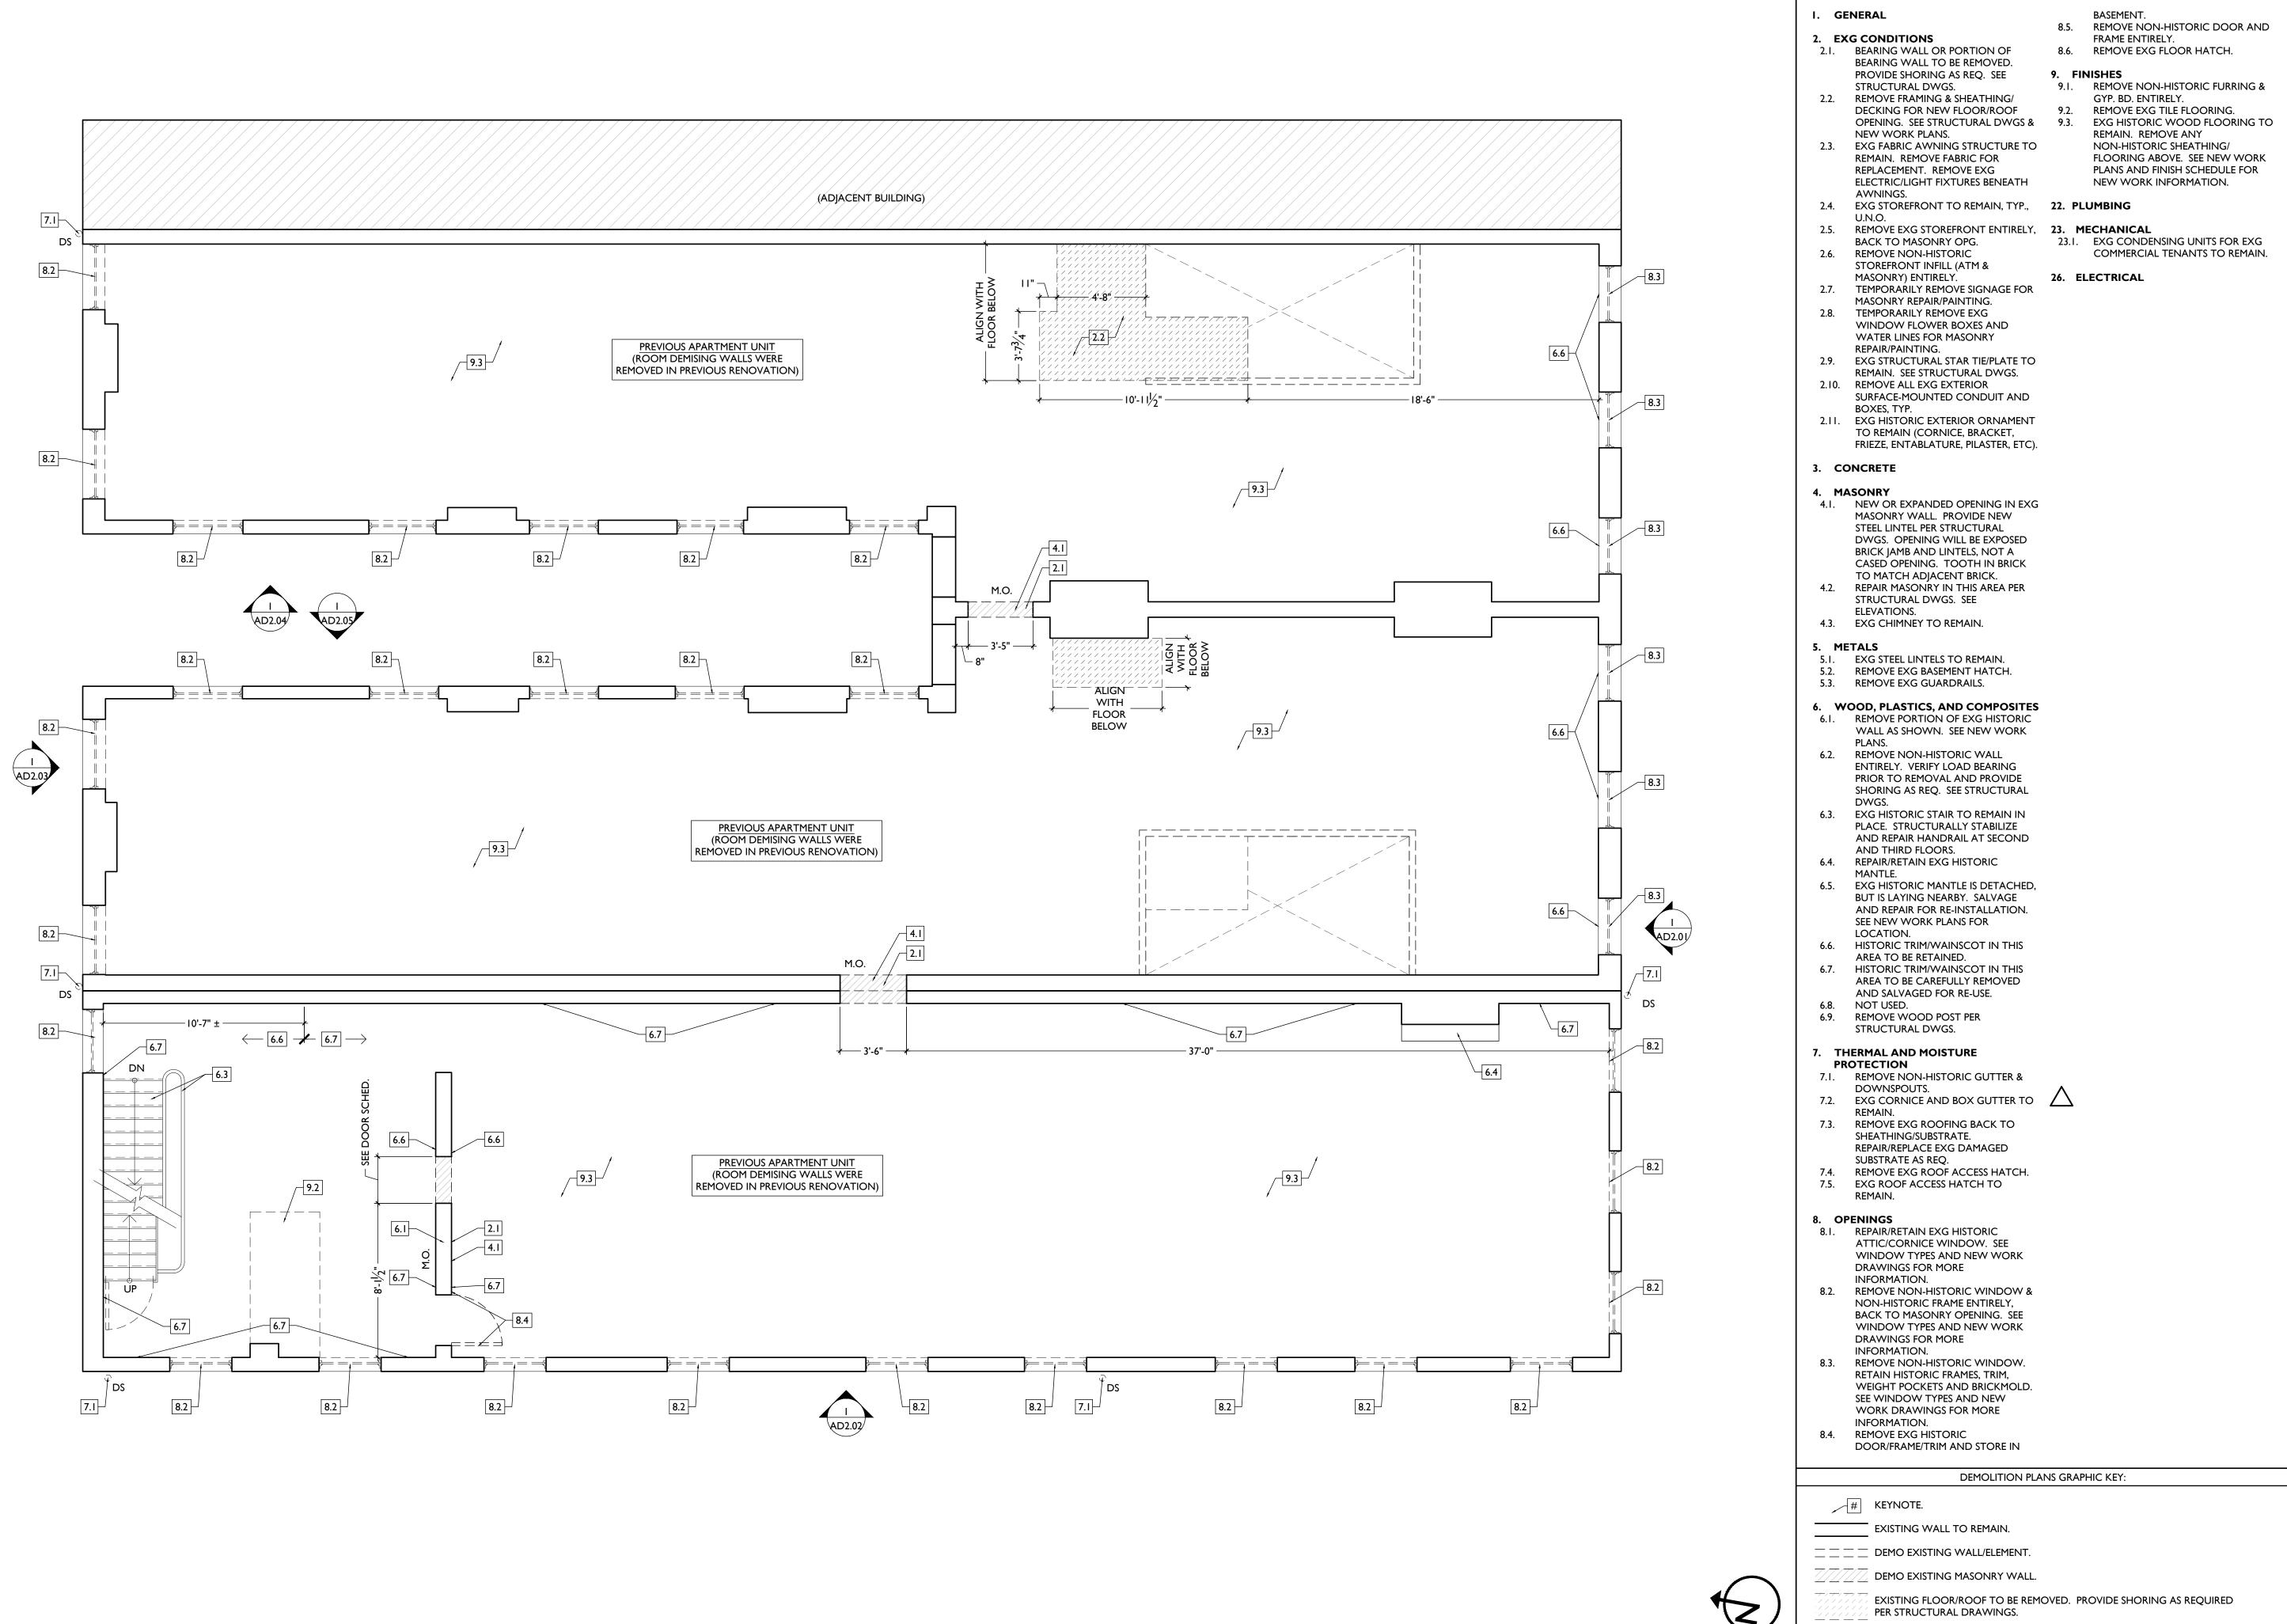
— – EXISTING STRUCTURAL MEMBER.

 $\bullet^{X'-X''}$ ELEVATION TAG.

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Design Team: MR, TB, SO, MR Drawn by: TB, MR

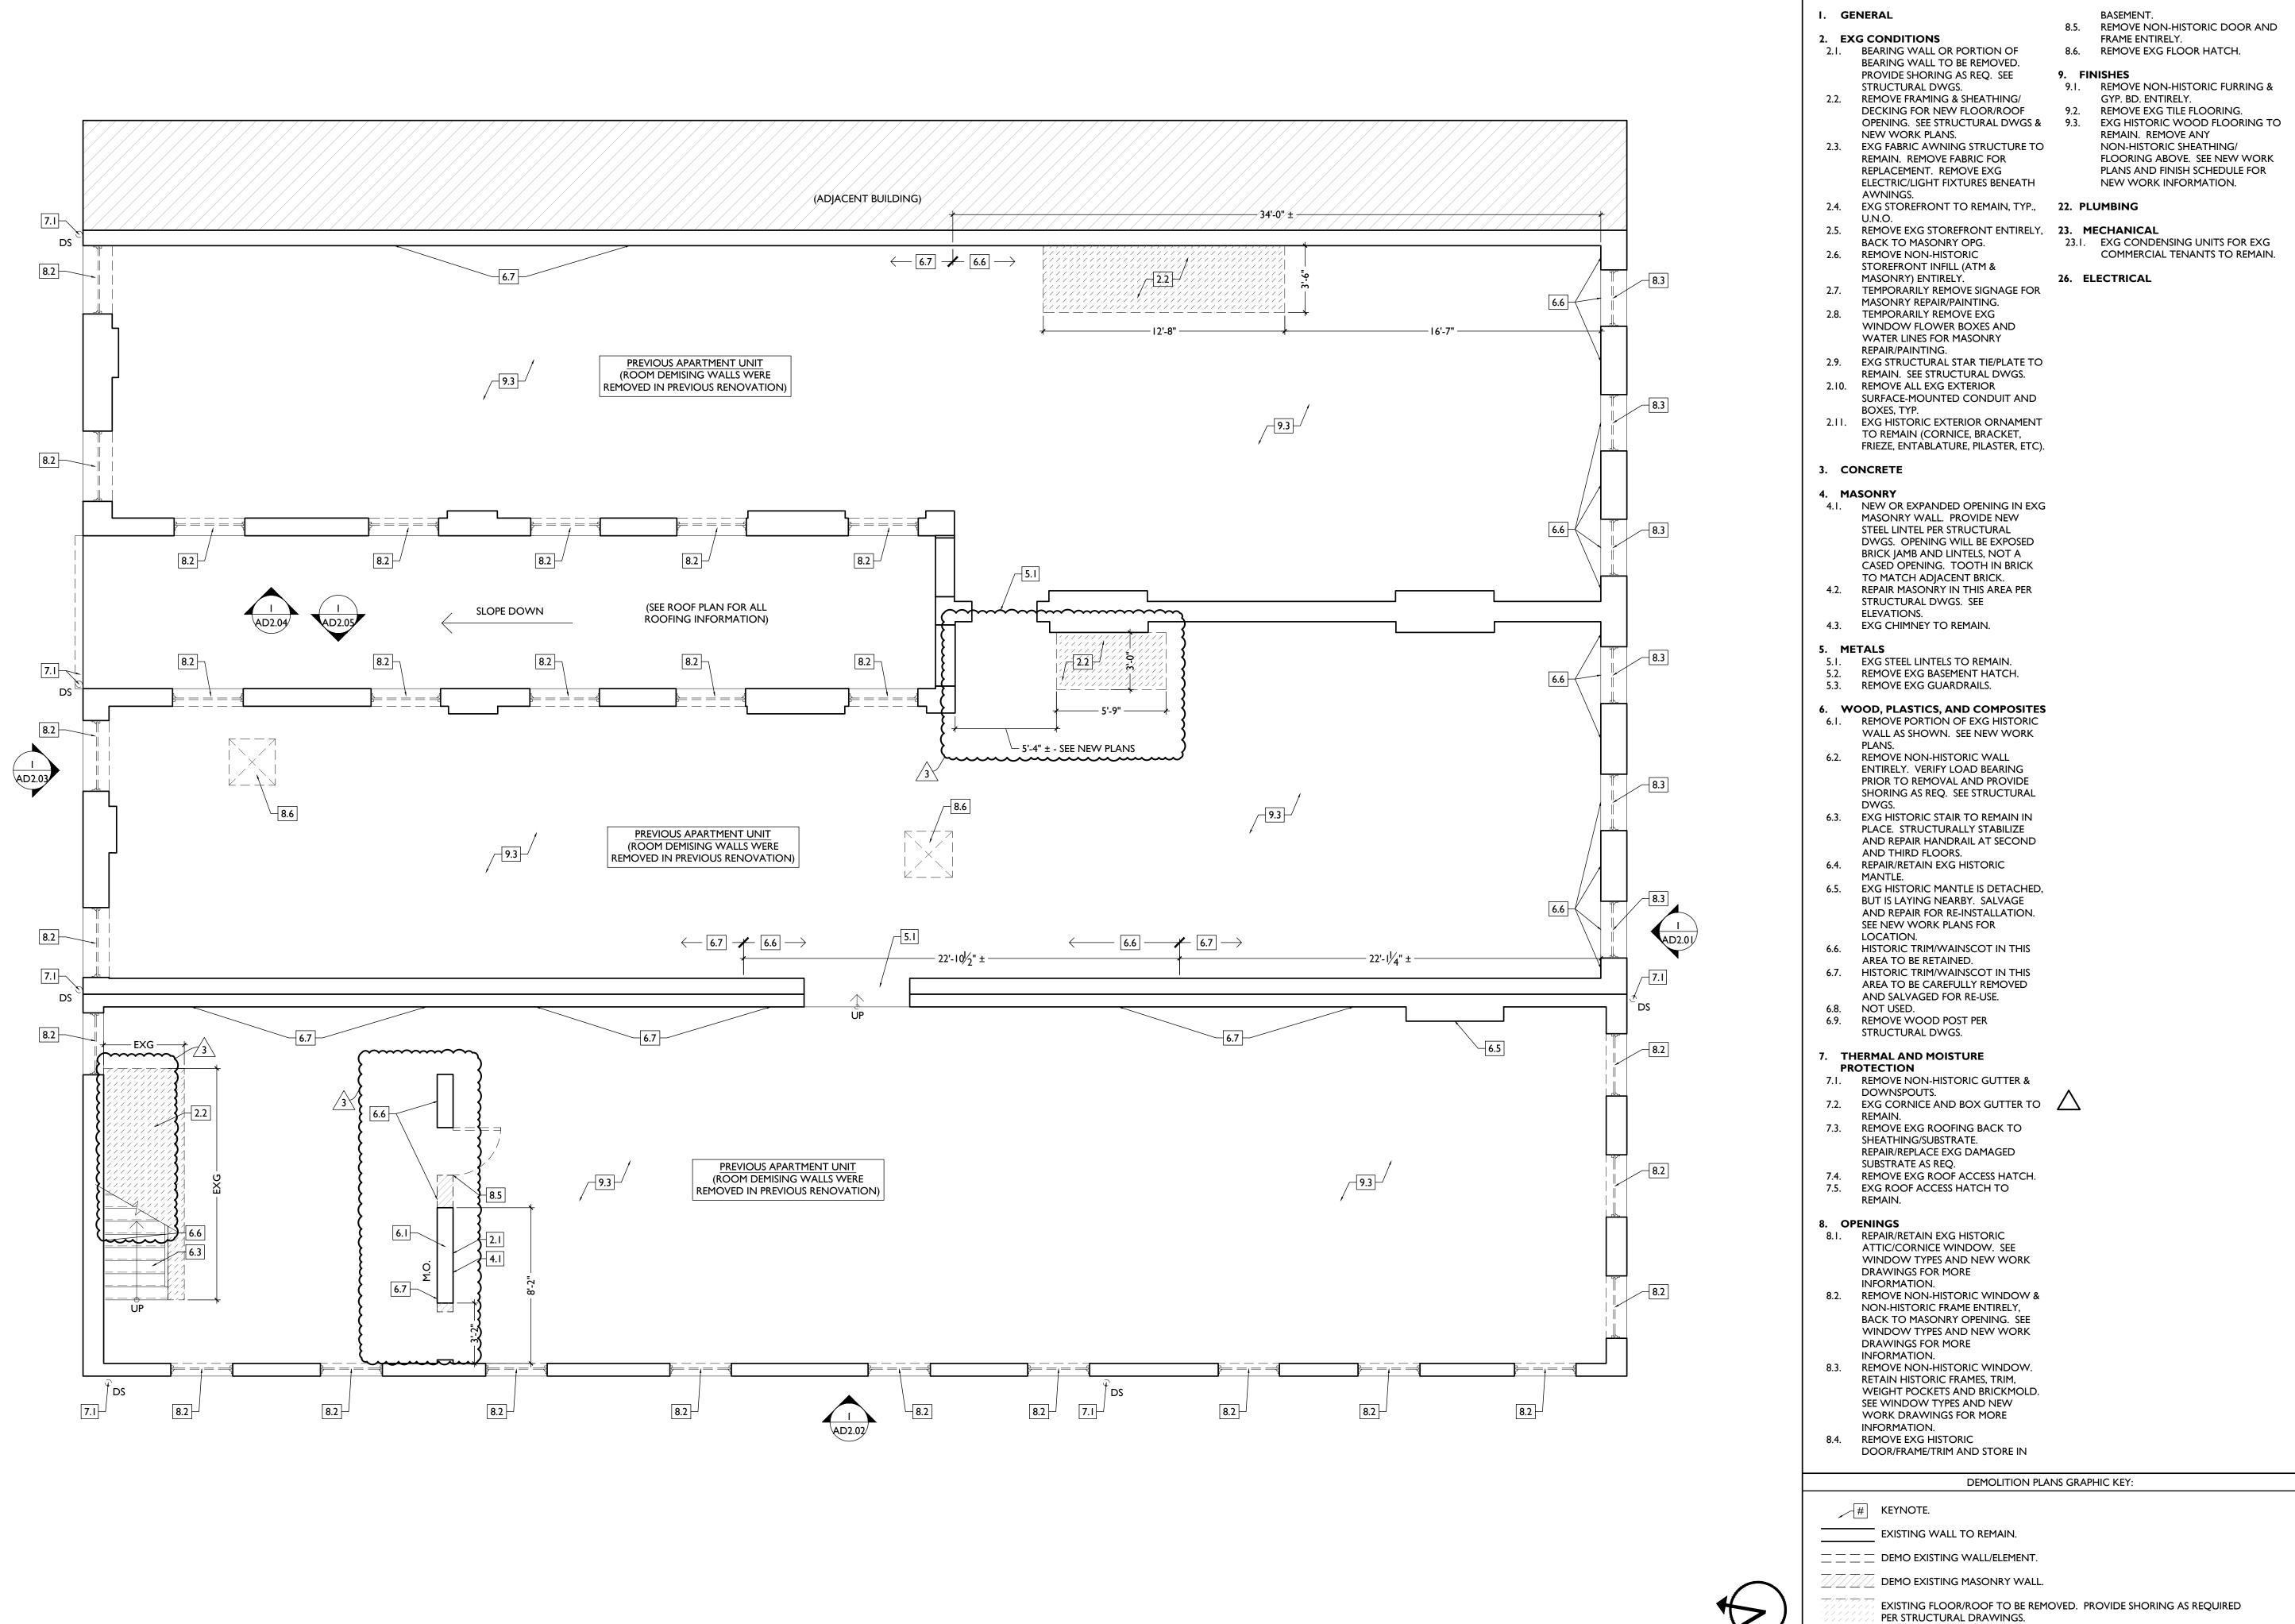


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MR, TB, SO, MR Drawn by: TB, MR



— – EXISTING STRUCTURAL MEMBER.

 $\bullet^{X'-X''}$ ELEVATION TAG.


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05.26.2022 - PERMIT REV I 06.15.2022 - PERMIT REV 2 08.19.2023 - ENG CHANGE I

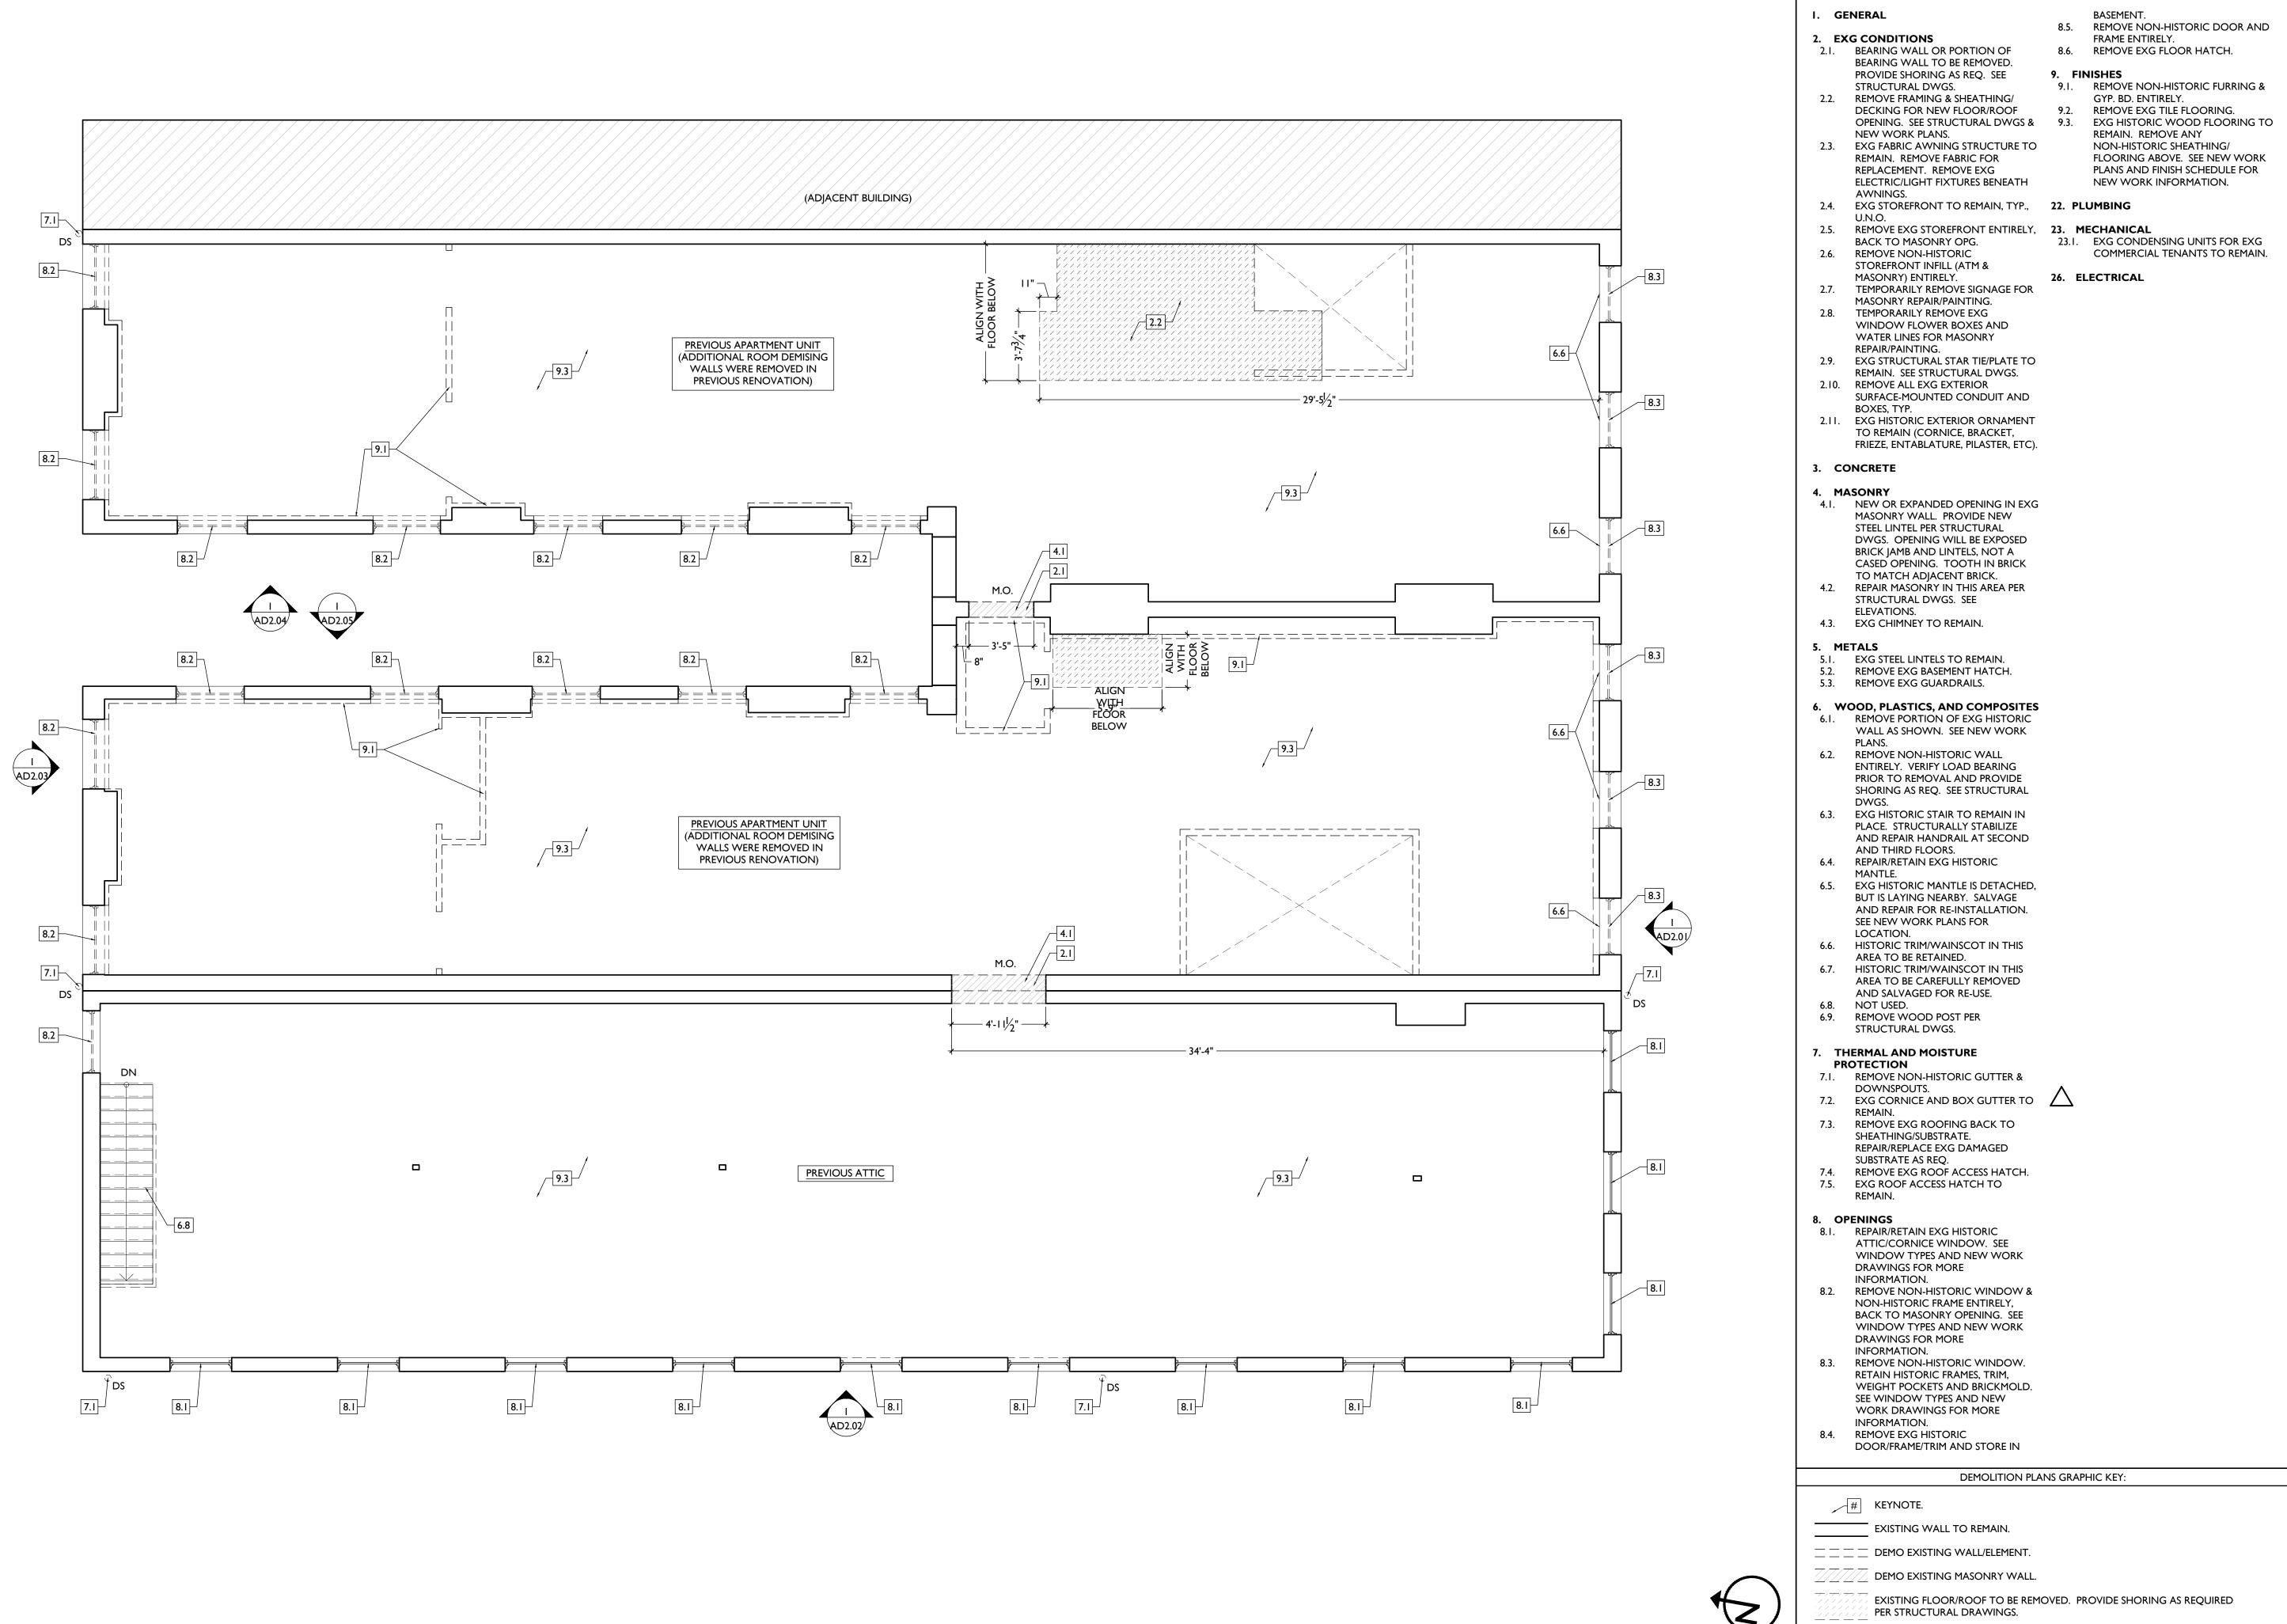MR, TB, SO, MR Drawn by: TB, MR

Job No: 22005 02.25.2022

SCALE: 1/4" = 1'-0"

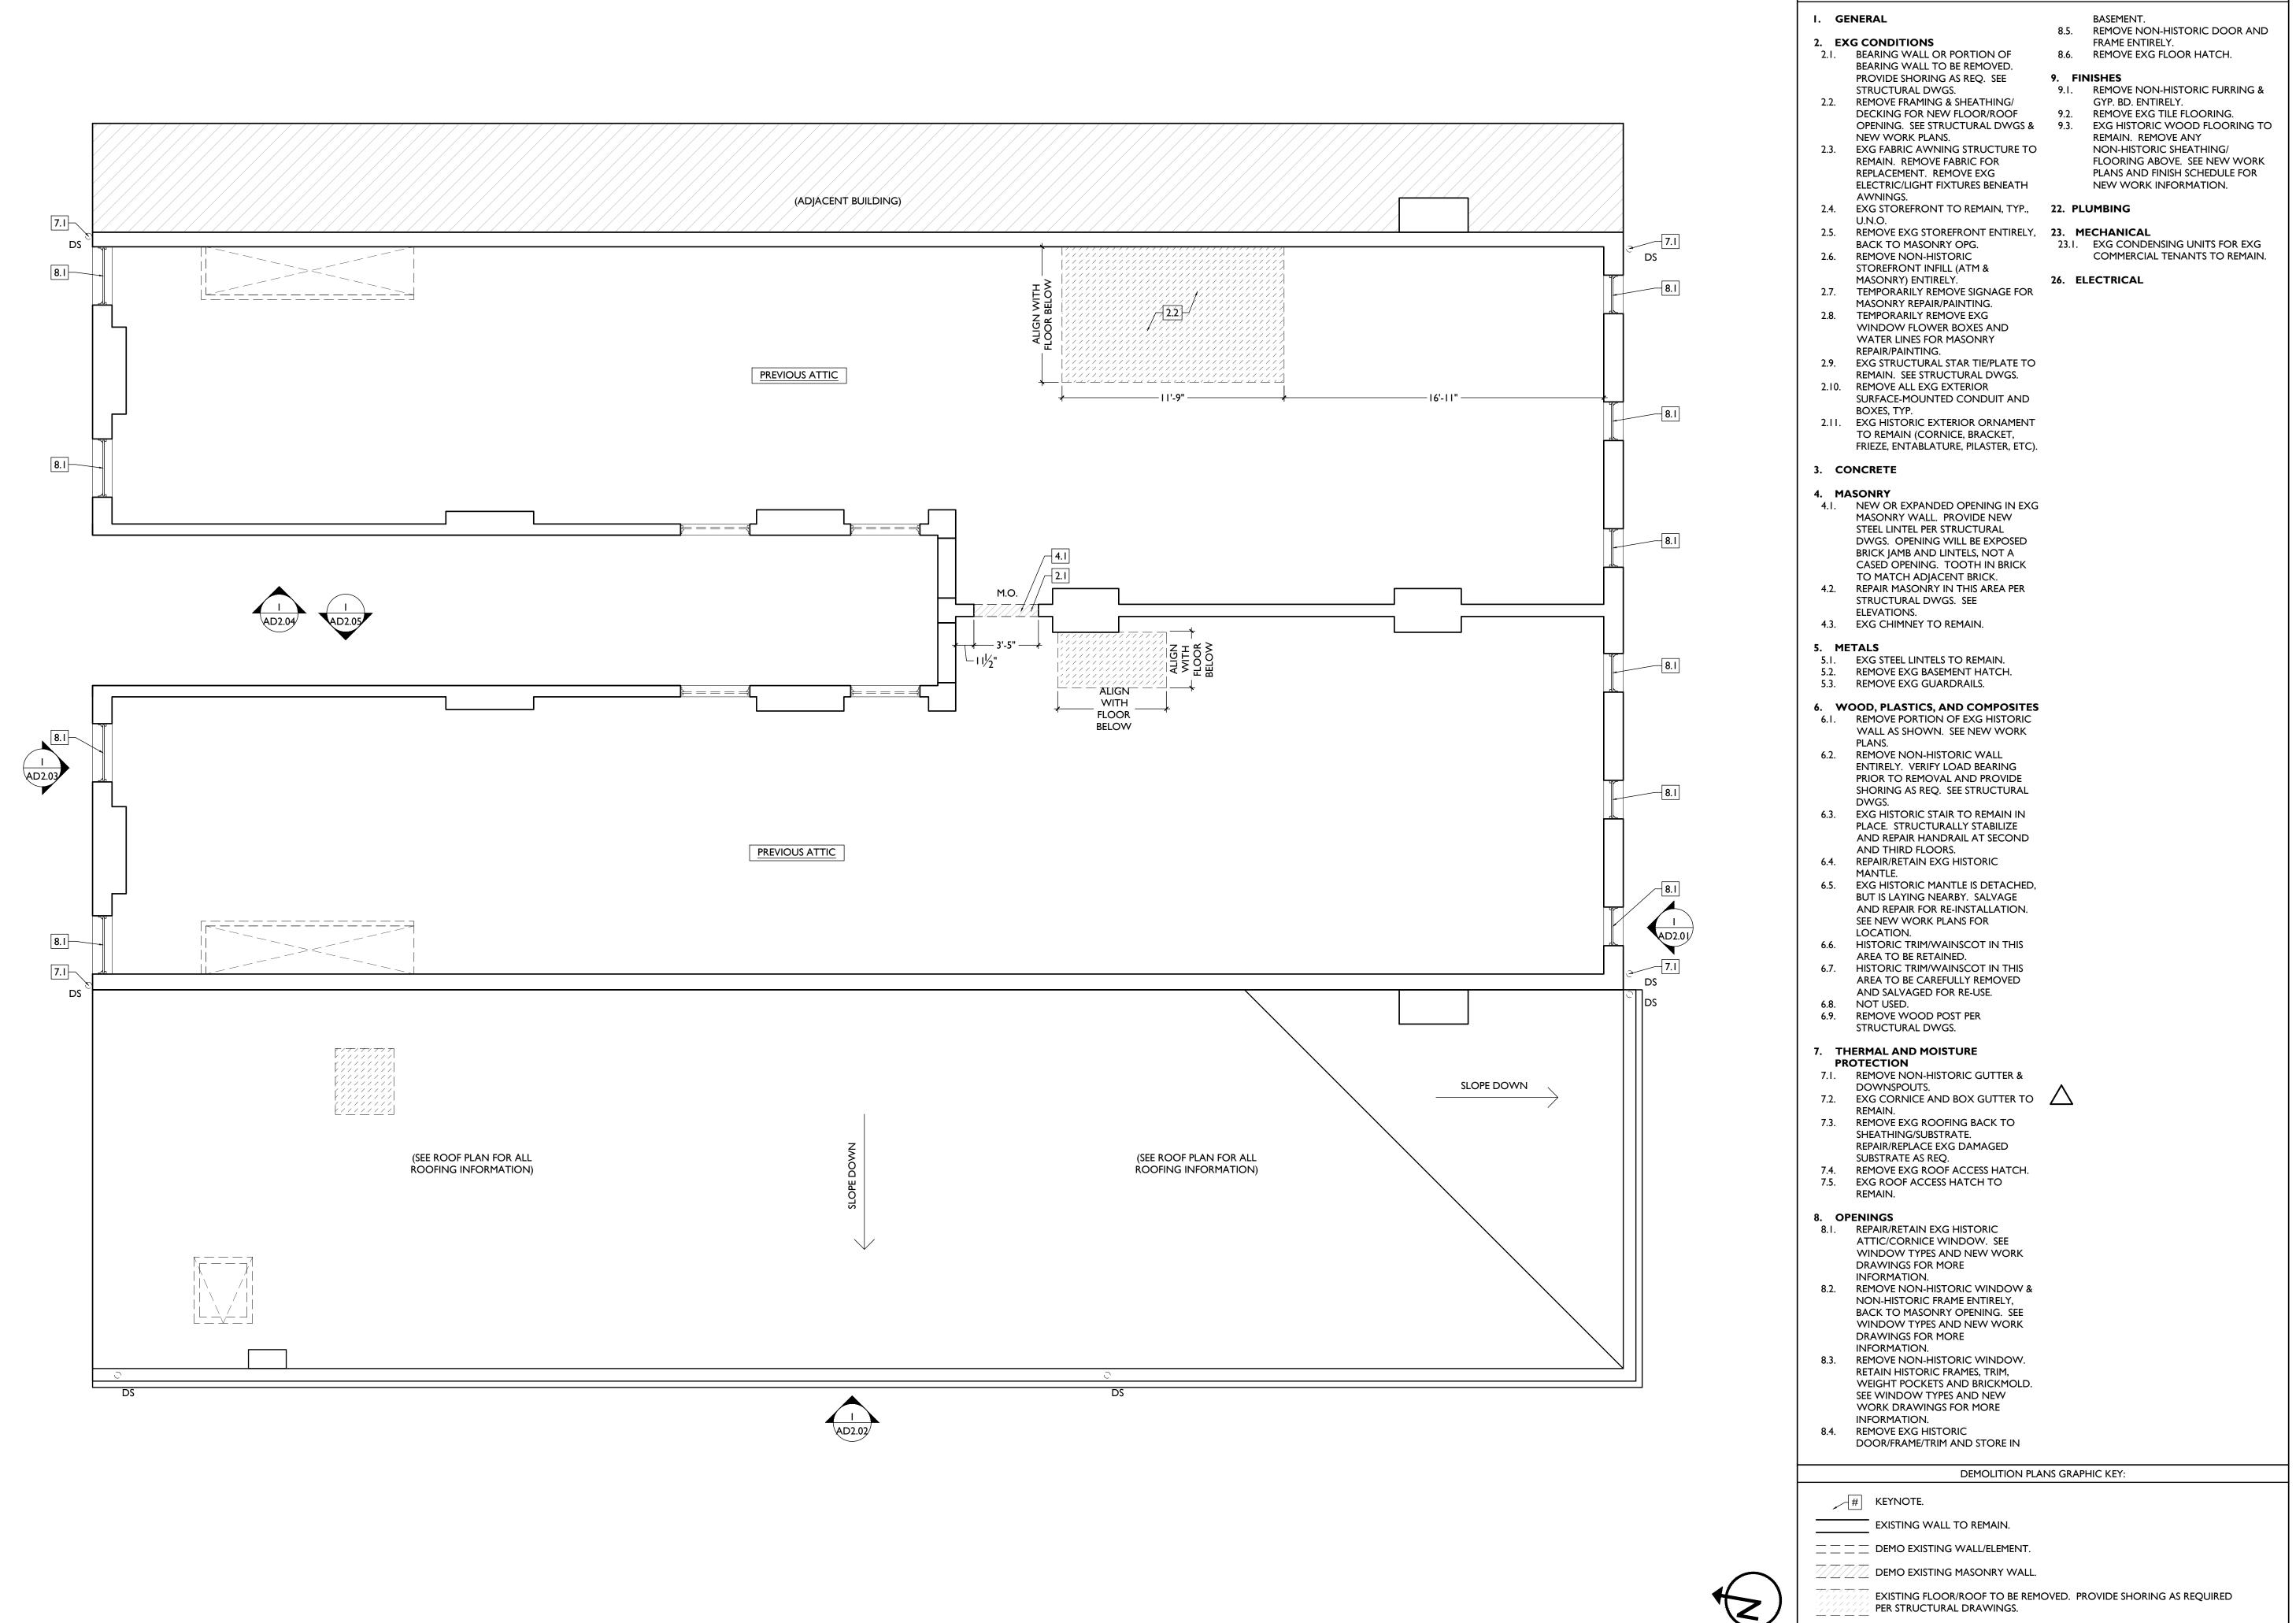

 $\bullet^{X'-X''}$ ELEVATION TAG.

— – EXISTING STRUCTURAL MEMBER.

Job No: 22005 02.25.2022

Progress Dates

08.15.2022 - BID SET

05.26.2022 - PERMIT REV I


06.15.2022 - PERMIT REV 2

MR, TB, SO, MR

Drawn by:

TB, MR

08.19.2023 - ENG CHANGE I

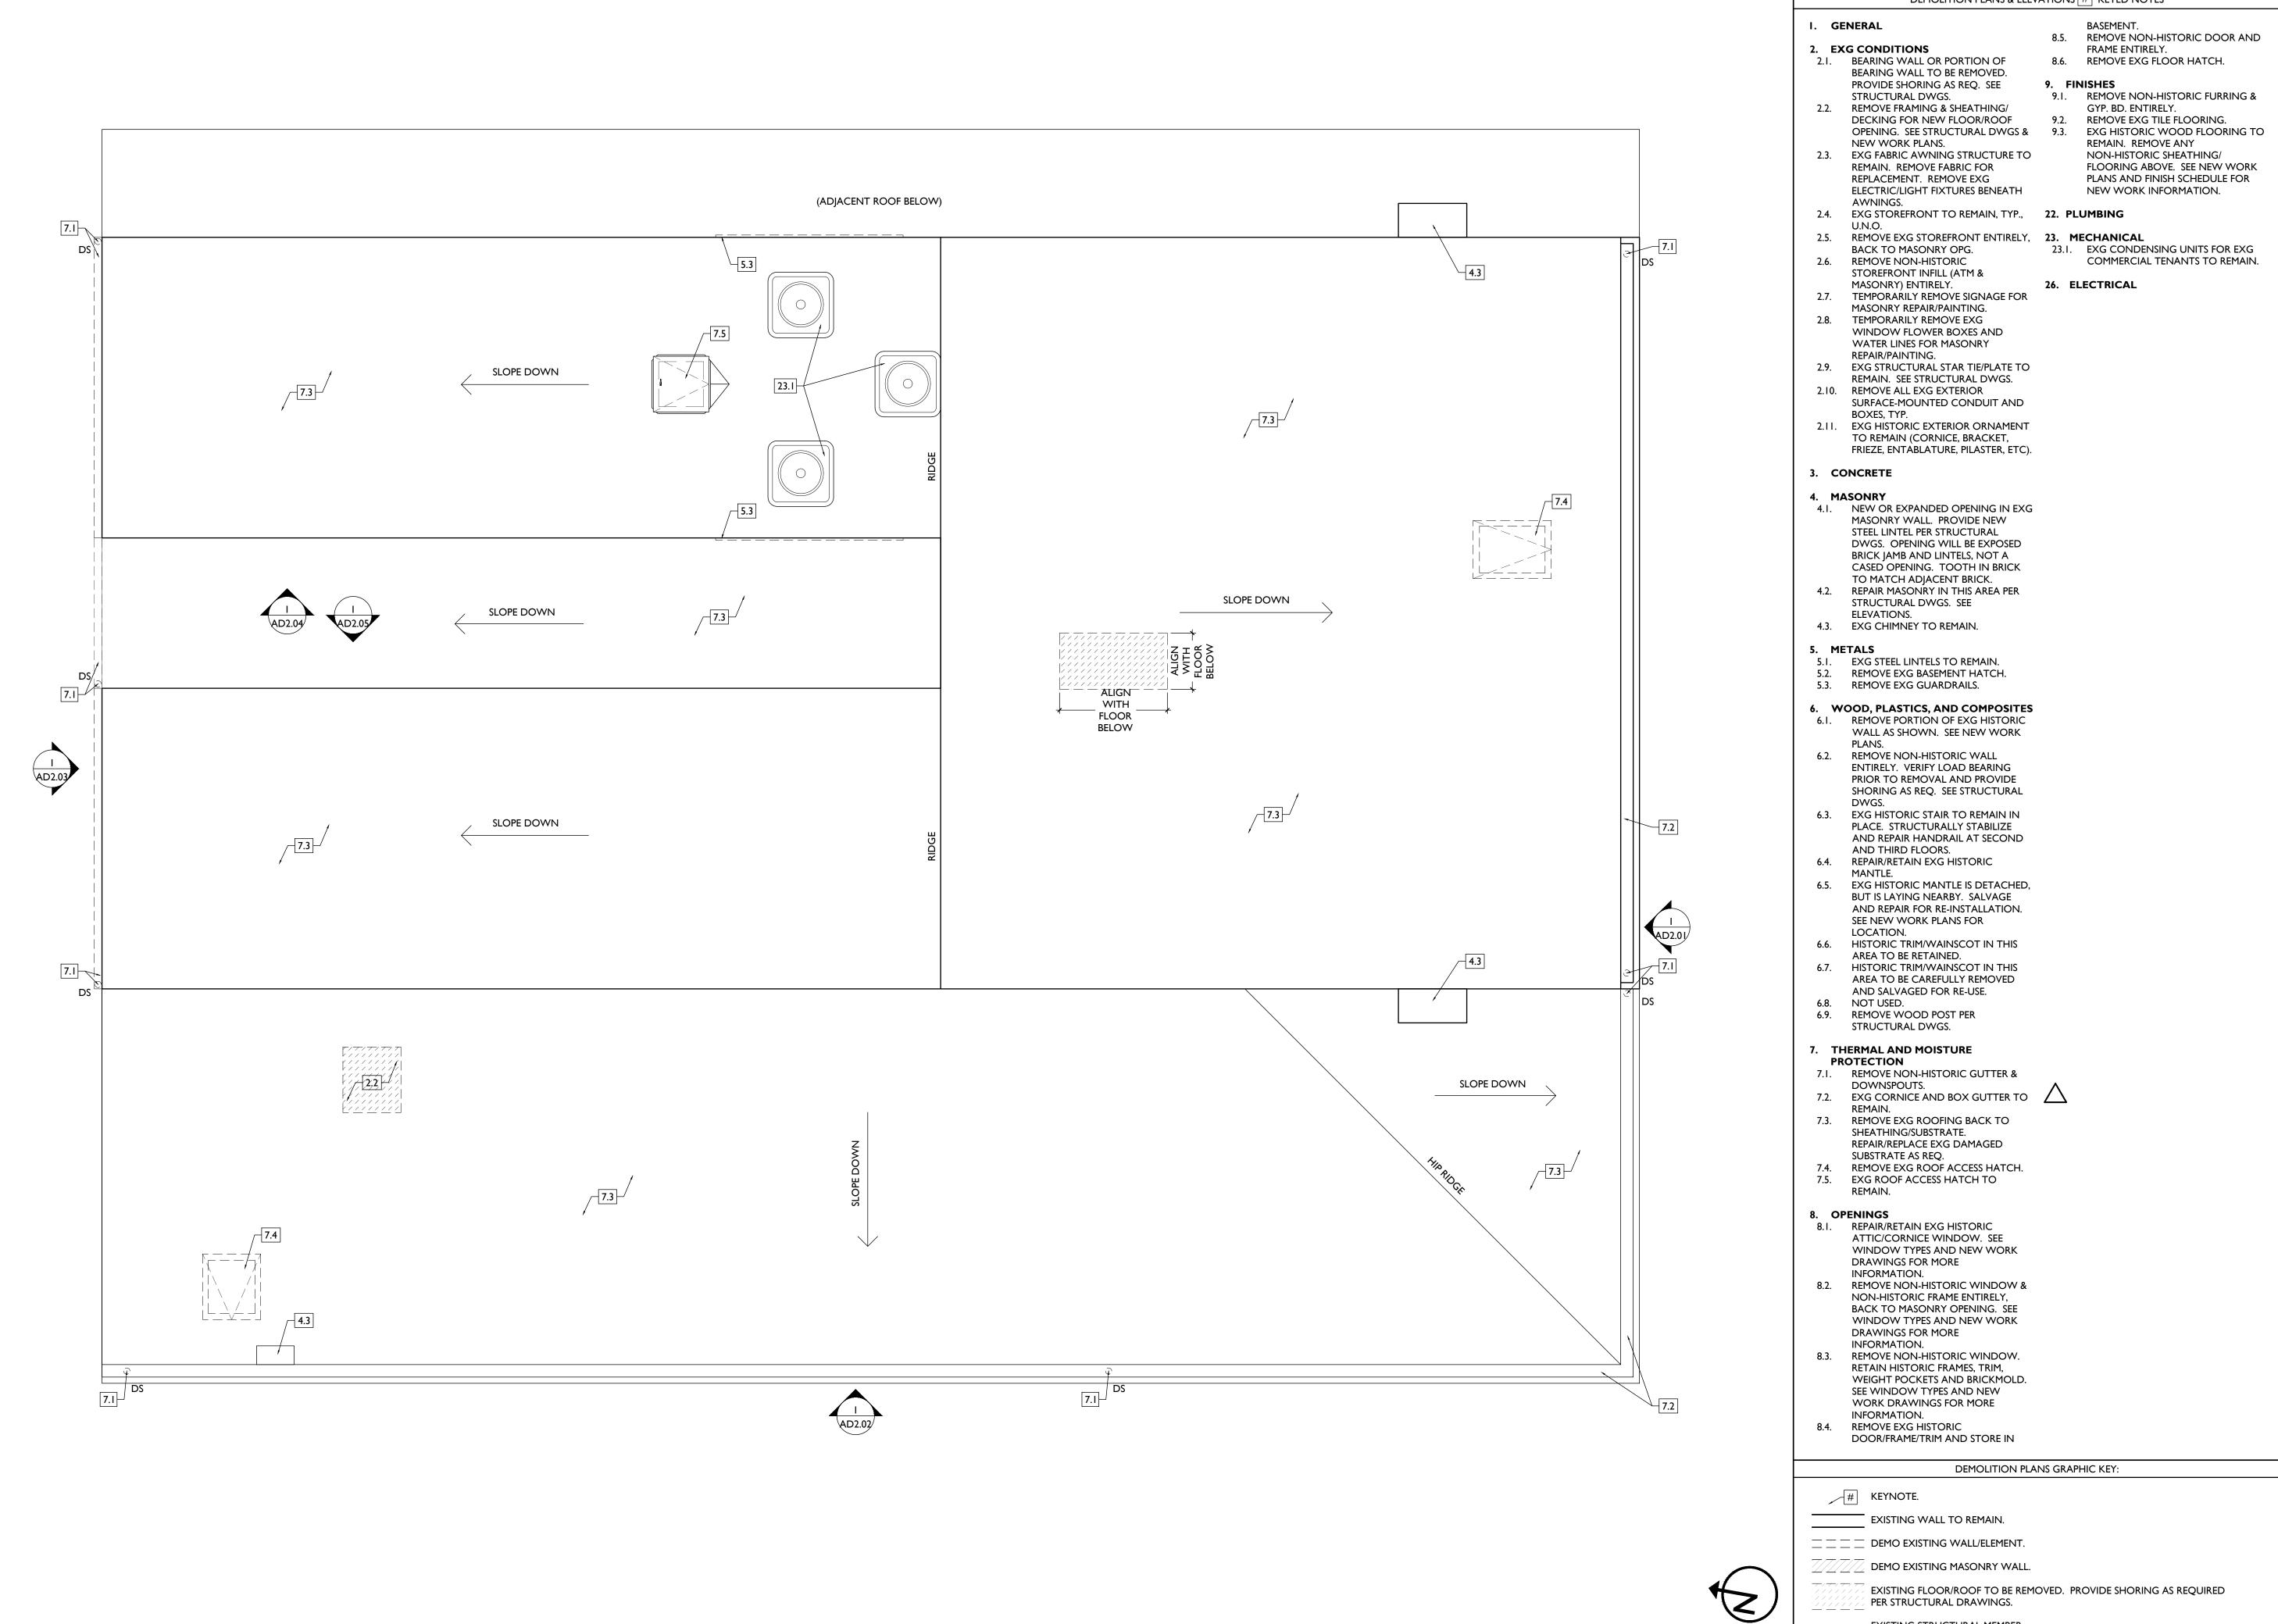

— – EXISTING STRUCTURAL MEMBER.

•X'-X" ELEVATION TAG.

Progress Dates 08.15.2022 - BID SET


05.26.2022 - PERMIT REV I 06.15.2022 - PERMIT REV 2 08.19.2023 - ENG CHANGE I

Design Team: MR, TB, SO, MR Drawn by: TB, MR




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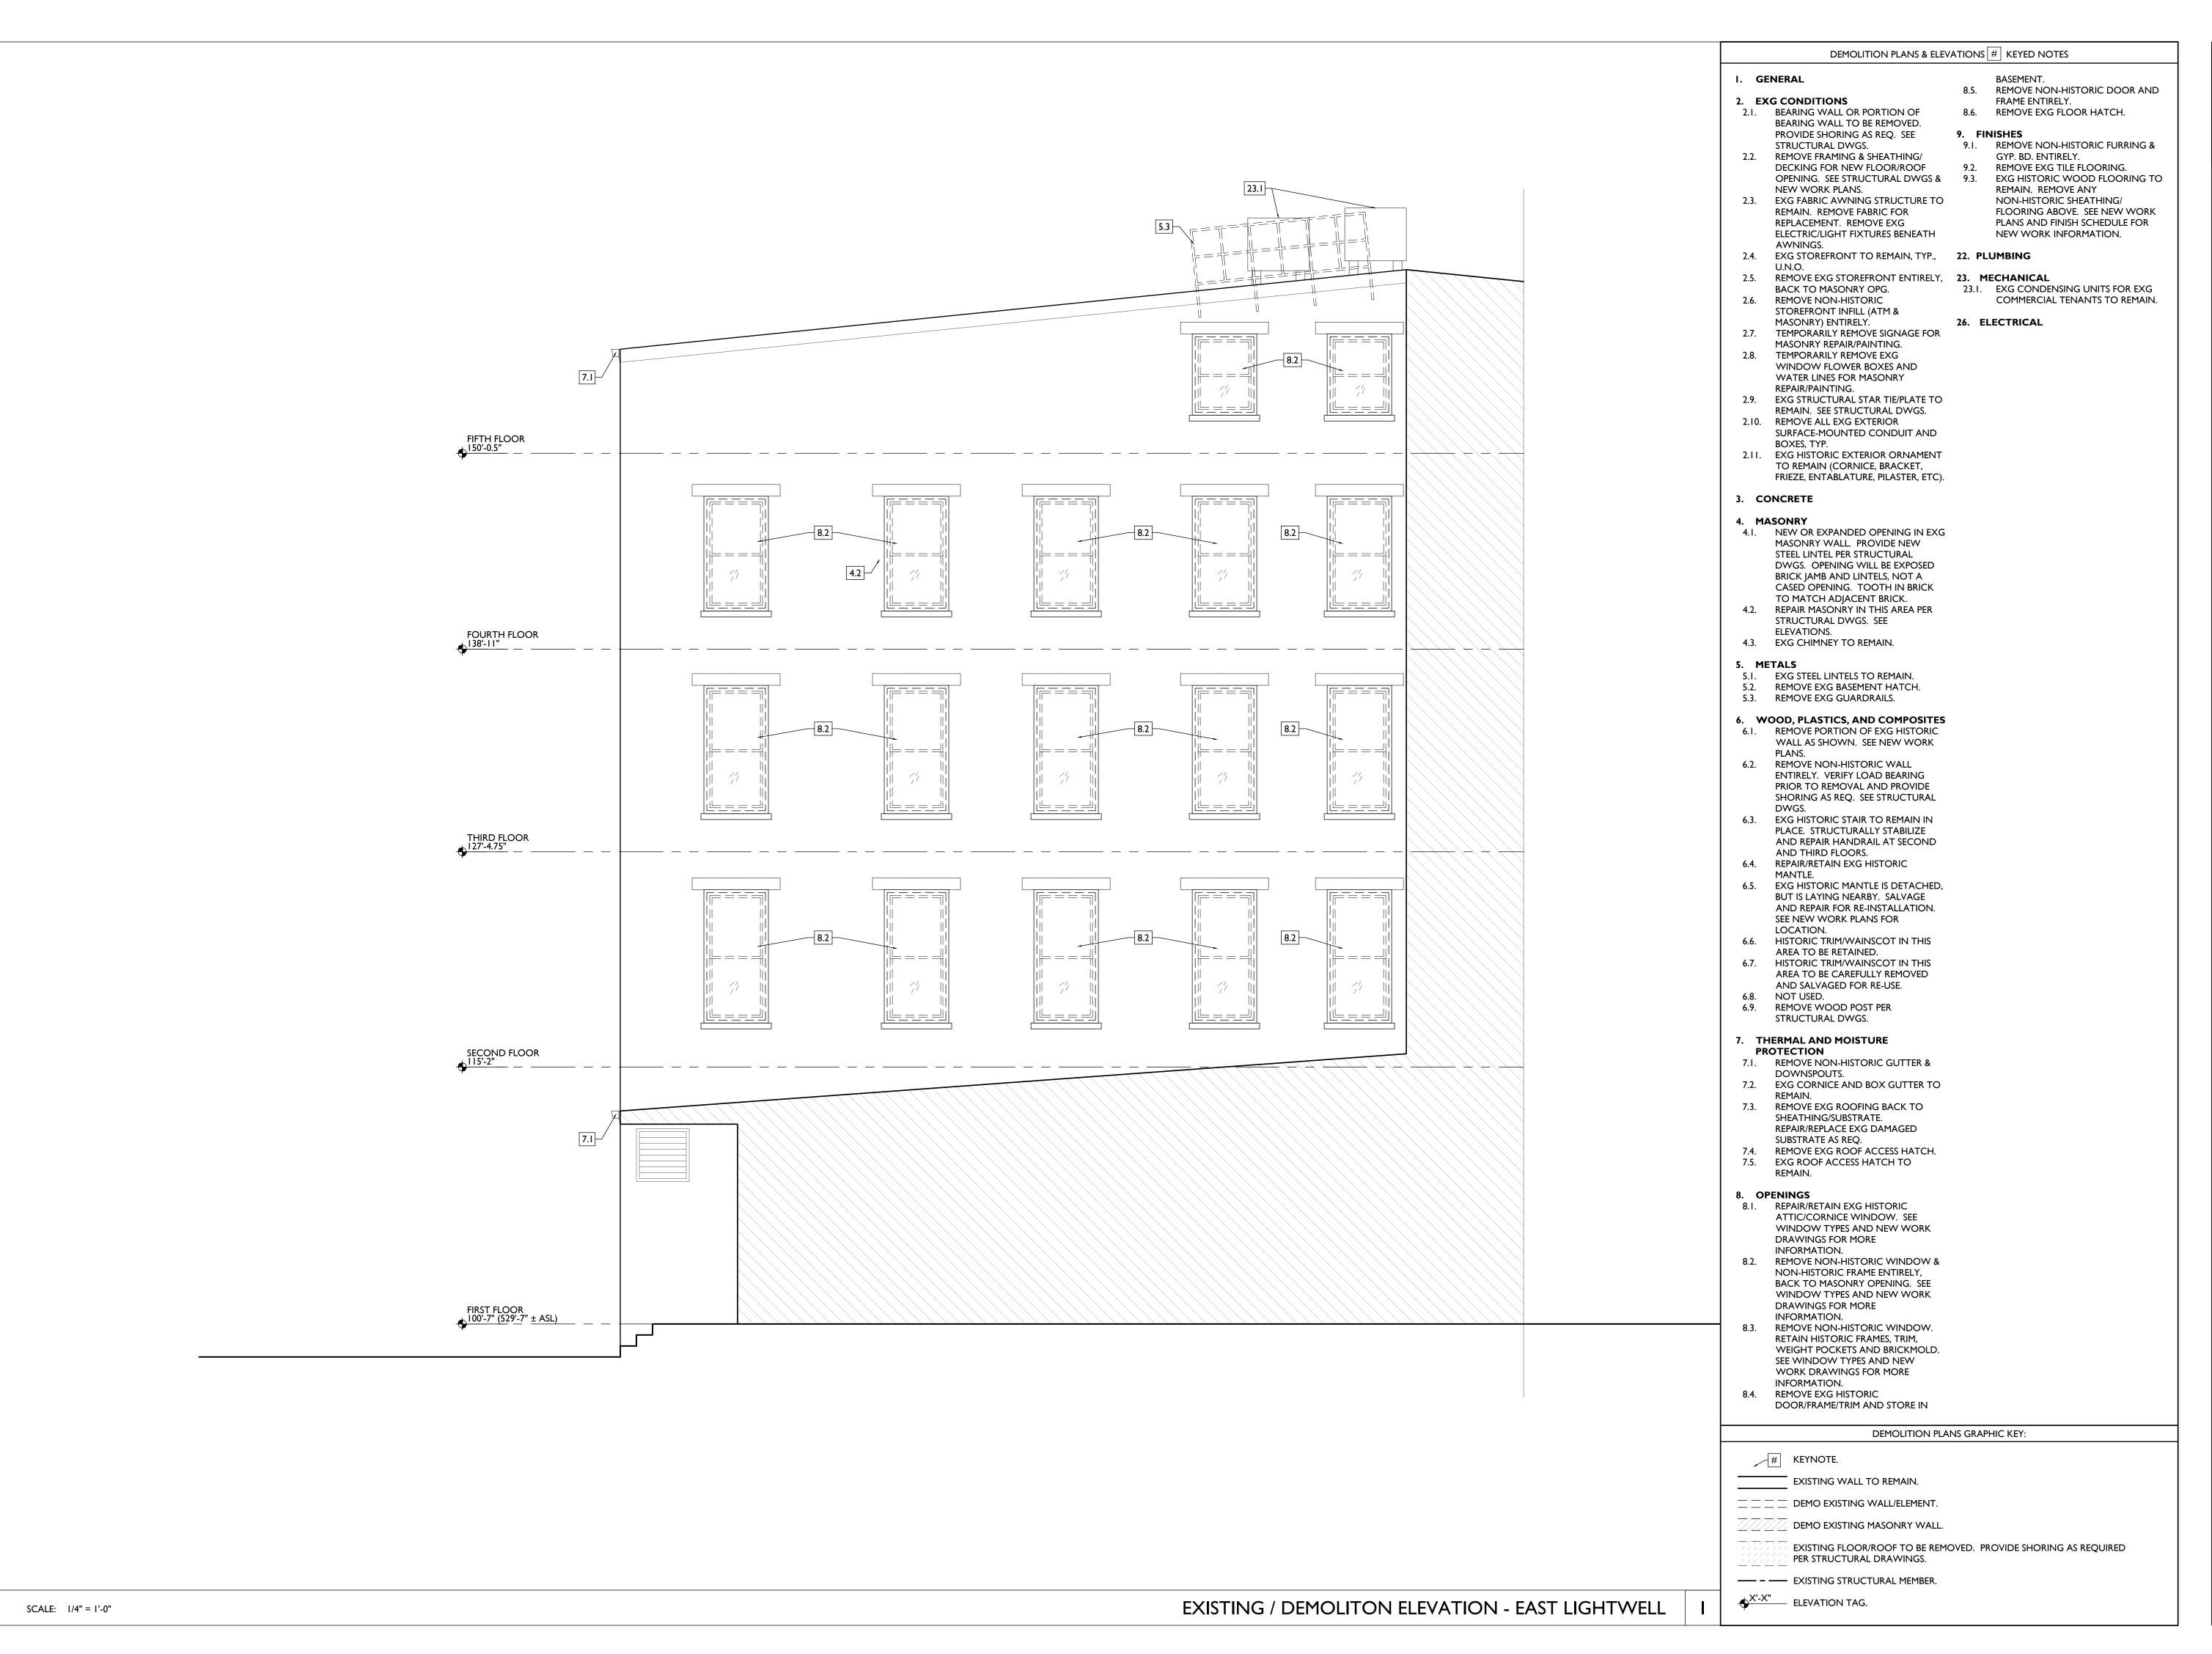
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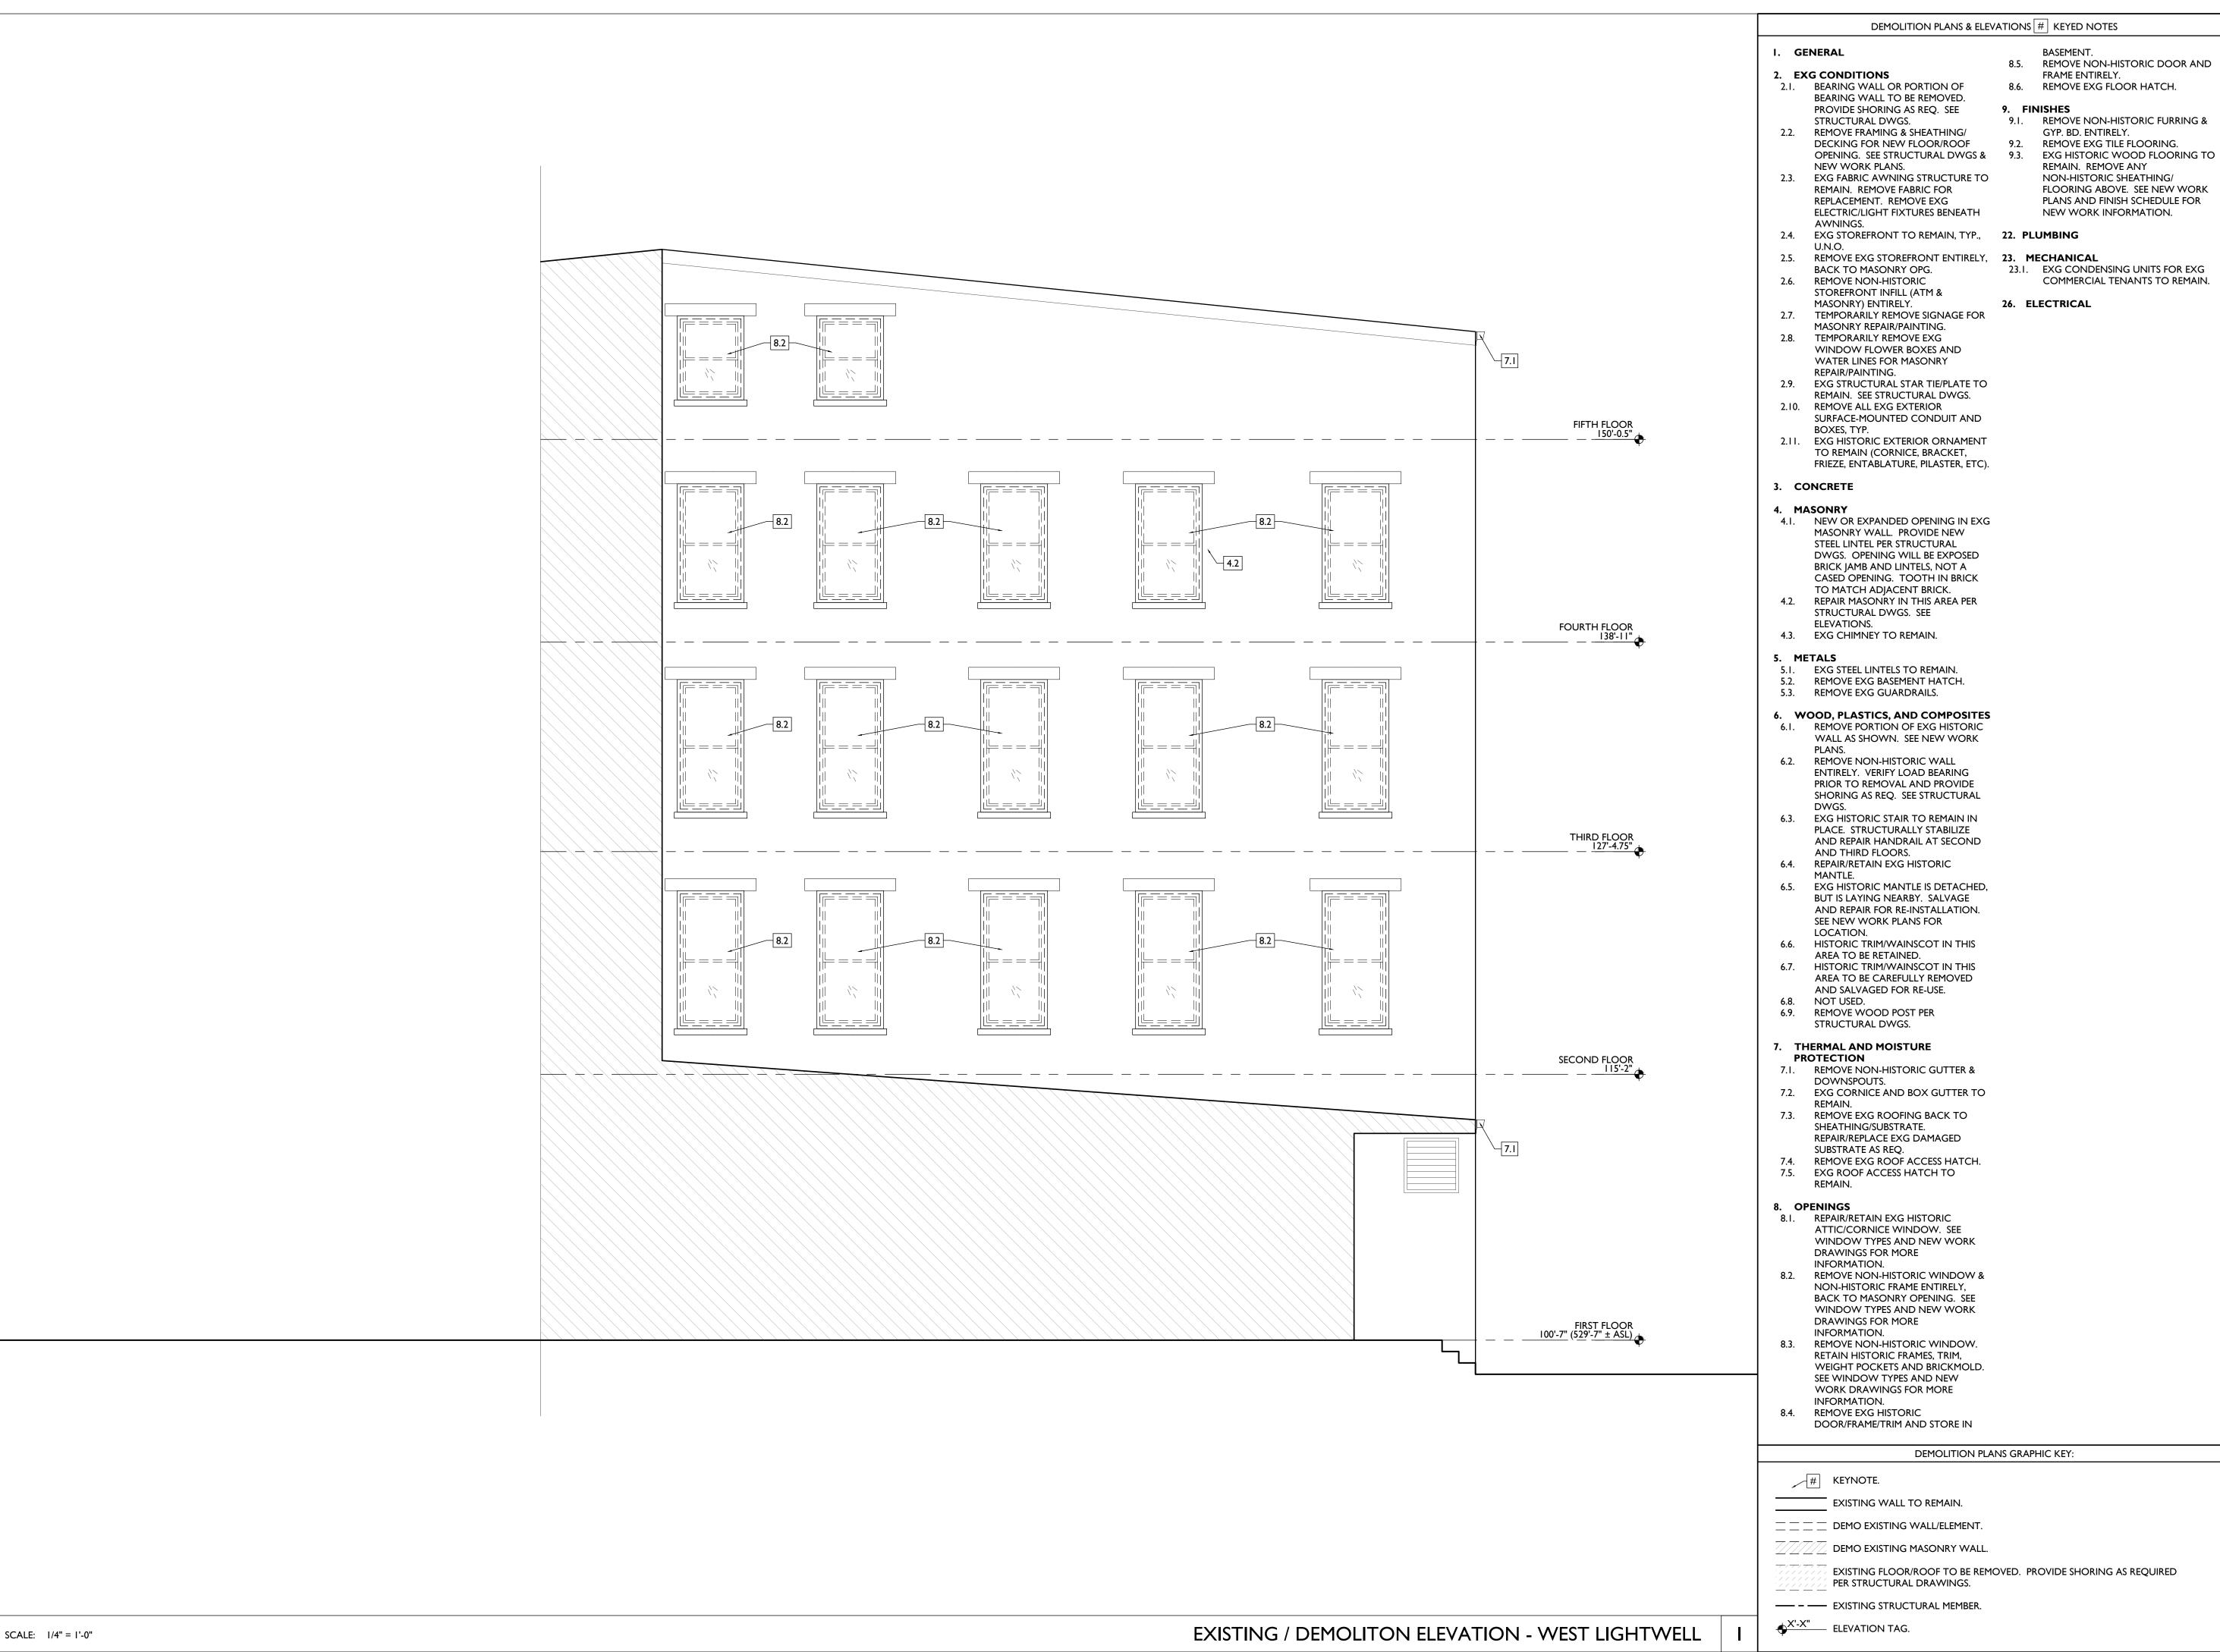
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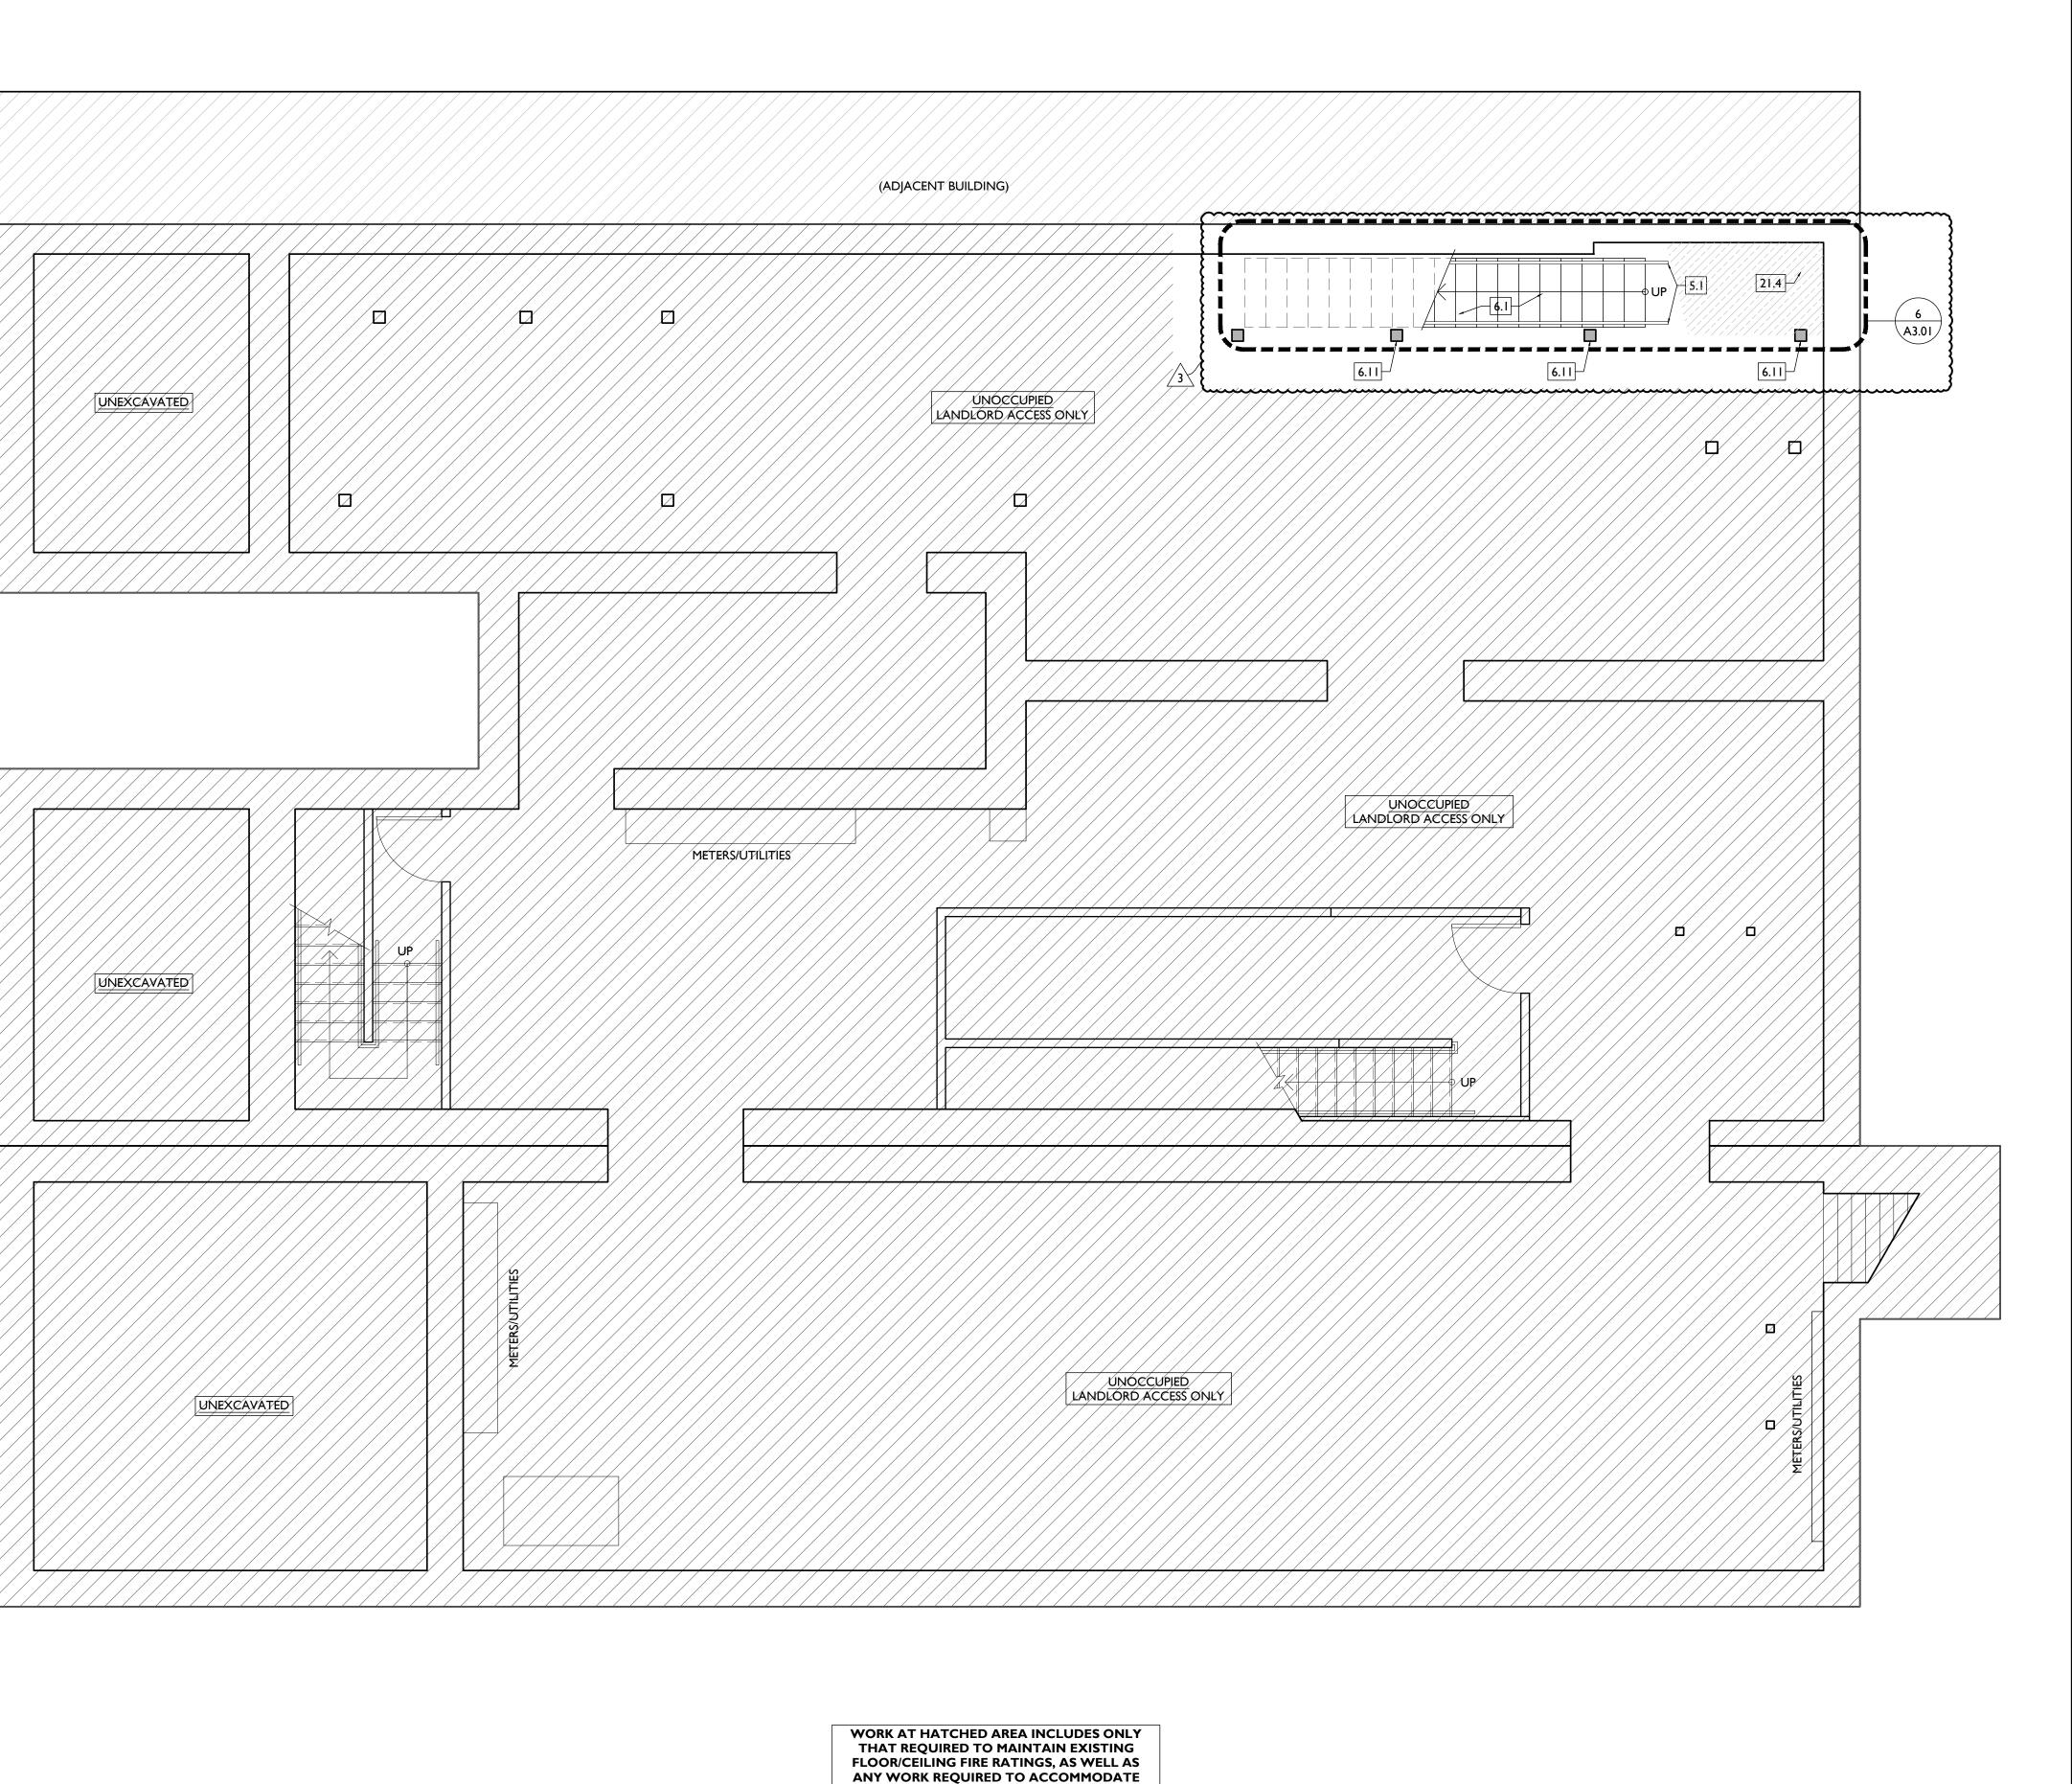
MR, TB, SO, MR Drawn by: TB, MR

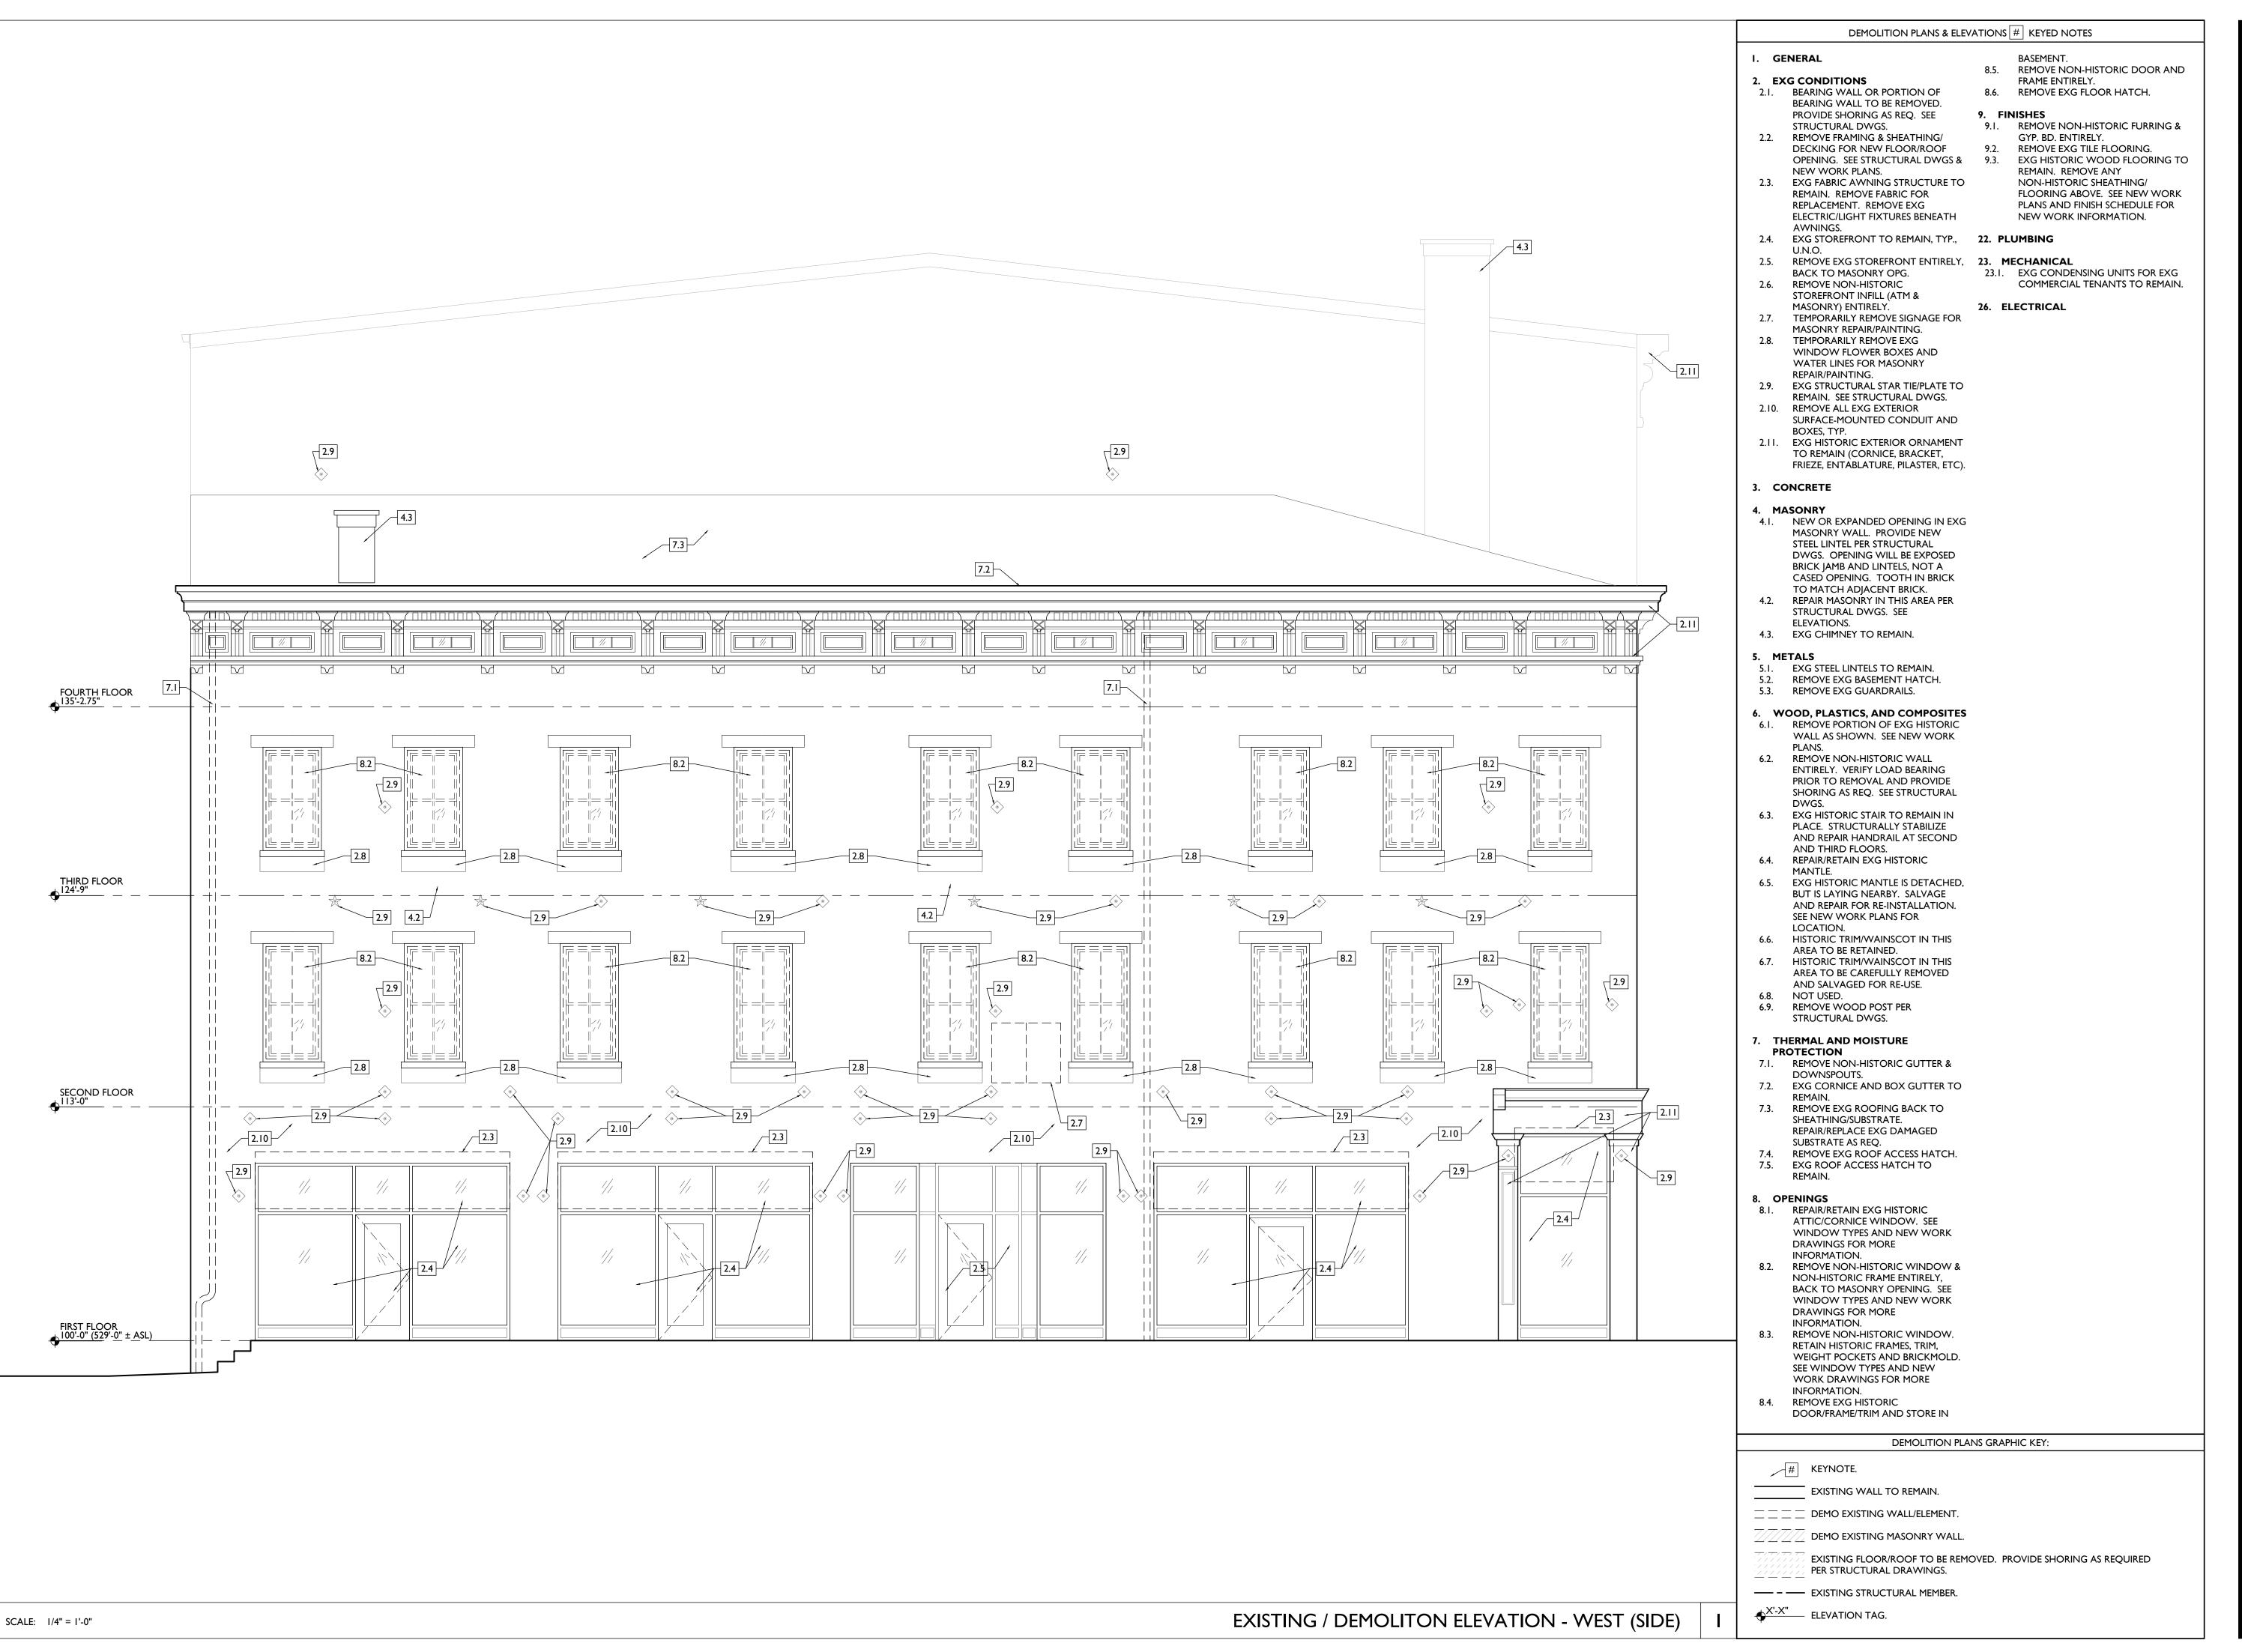

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MR, TB, SO, MR

Drawn by: TB, MR

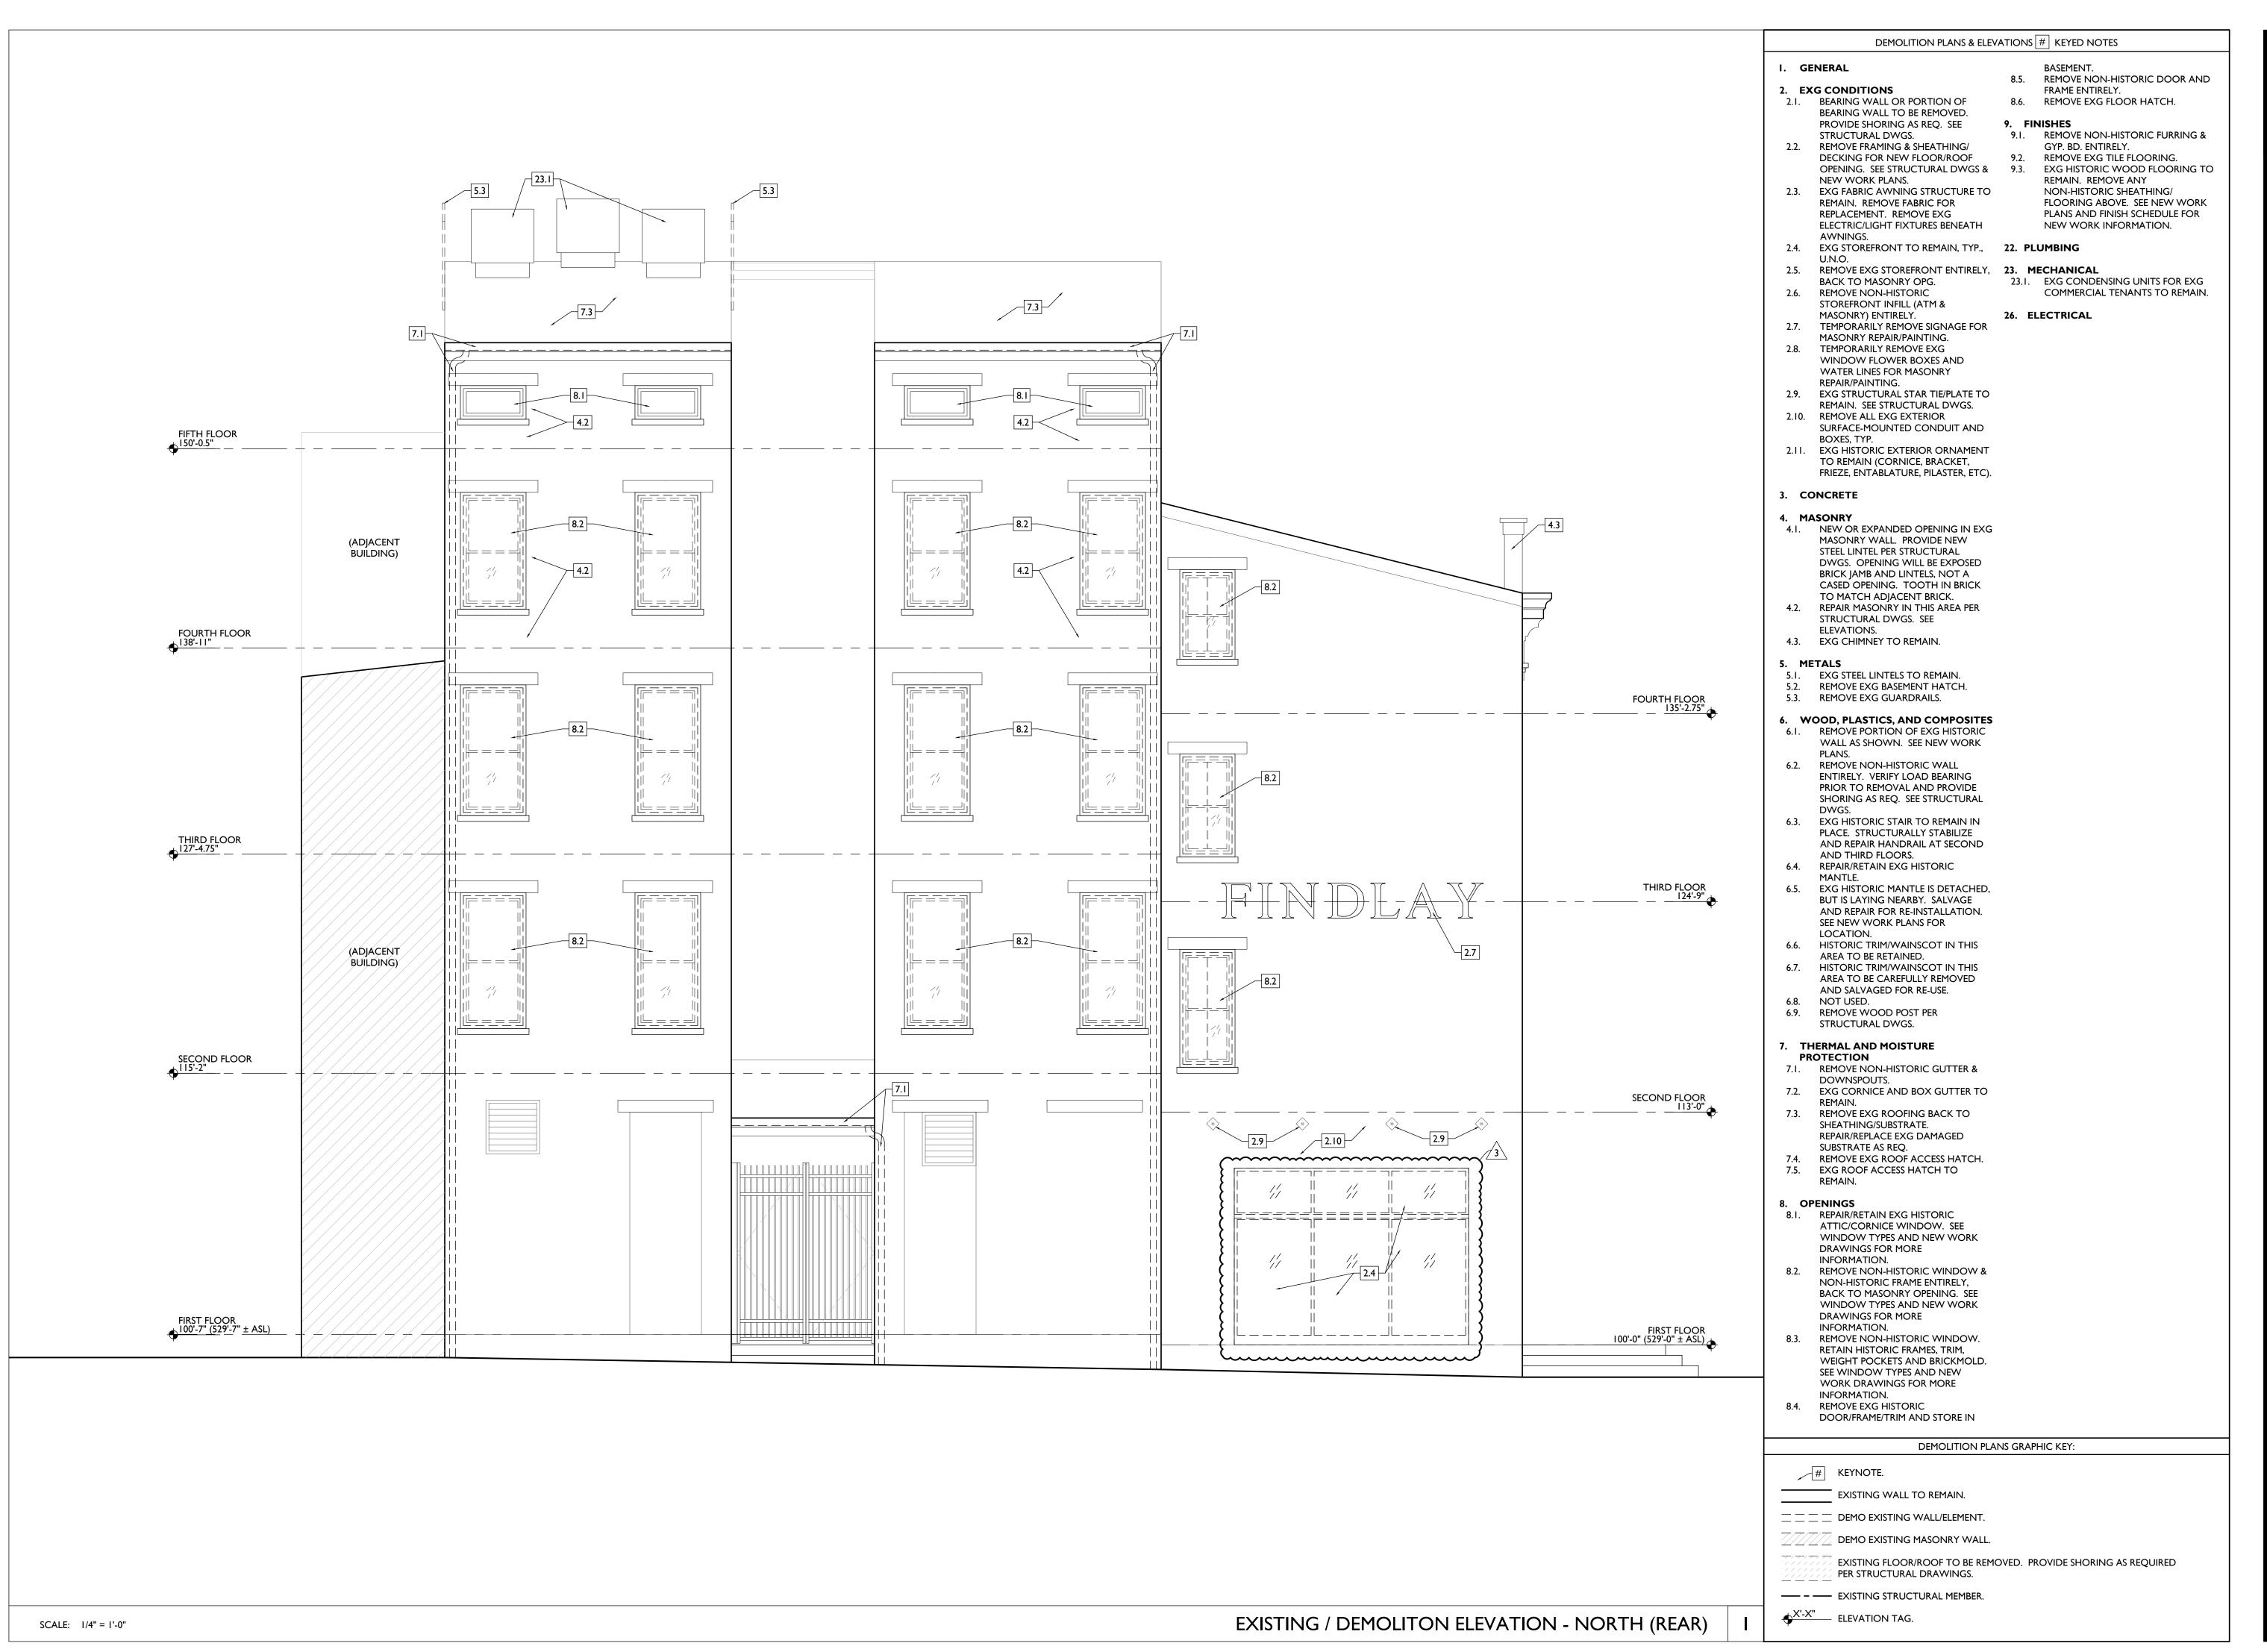

APARTMENT RENOVATION ABOVE (SUCH AS

STAIRWAYS, RATING OF STAIRS SUPPORTING

STRUCTURE, PLUMBING, SPRINKLERS,

ELECTRICAL SYSTEMS, RISERS AND CONDUIT.

NEW WORK PLANS & ELEVATIONS # KEYED NOTES I. GENERAL **ELEVATIONS AND STOREFRONT TYPES.** 8.3. GYP. BD. RETURN AT JAMB. 2. EXG CONDITIONS 2.1. EXG OPENING IN MASONRY WALL. 9. FINISHES OPENING WILL REMAIN EXPOSED 9.1. FIRE-RATING TO BE CONTINUOUS

BRICK JAMB AND LINTELS, IT WILL NOT

BE A CASED OPENING. TOOTH IN BRICK AS REQ TO MATCH ADJACENT 2.2. EXG LOOSE HISTORIC MANTLE TO BE 9.2.

RE-INSTALLED IN THIS LOCATION.

3. CONCRETE

4. MASONRY 4.1. NEW OR EXPANDED OPENING IN EXG MASONRY WALL (SEE STRUCTURAL DWGS). PROVIDE NEW STEEL LINTEL. WAY THAT IT IS CLEAR IT IS BETWEEN TWO SEPARATE BUILDINGS. OPENING WILL BE EXPOSED BRICK JAMB AND 10. SPECIALTIES LINTELS, NOT A CASED OPENING. TOOTH IN BRICK TO MATCH

ADJACENT BRICK. 4.2. EXPOSED BRICK JAMB. TOOTH IN BRICK TO MATCH ADJACENT BRICK. 4.3. INFILL NON-HISTORIC STOREFRONT OPENING. RECESS I" FROM FACE OF

ADJACENT WALL. SEE DETAILS.

5.5. NOT USED

DETAILS.

5. METALS 5.1. NEW $1\frac{1}{2}$ " DIA. CONTINUOUS STEEL PIPE 10.3. HANDRAIL, PAINTED. SEE DETAILS. 5.2. NEW STEEL GUARDRAIL. SEE DETAILS. 5.3. NEW STEEL LINTEL/STRUCTURAL

MEMBER PER STRUCTURAL DWGS. 5.4. NEW STOREFRONT ELEMENTS TO MATCH EXG ADJACENT STOREFRONT BAYS. SEE EXTERIOR ELEVATIONS AND STOREFRONT TYPES.

NEW GUARDRAIL AT ROOFTOP CONDENSING UNITS TO MATCH EXG. SEE STRUCTURAL DWGS. 5.7. NEW STRUCTURAL STAR TIE, PAINTED

STRUCTURAL DWGS. 6. WOOD, PLASTICS, AND COMPOSITES 6.1. NEW INTERIOR WOOD STAIR. SEE

6.2. NEW FLOOR OR ROOF FRAMING (SEE STRUCT DWGS). 6.3. NEW STRUCTURAL REINFORCING PER 22. PLUMBING

TO MATCH EXG ADJ MASONRY. SEE

STRUCTURAL DWGS. 6.4. REPAIR/REFINISH EXG HISTORIC WOOD STAIR AND HANDRAIL. SEE DETAILS

AND STRUCTURAL DWGS. 6.5. WALL TO BE WALL TYPE "I", BUT FLAT FRAMED.

6.6. INFILL EXG OPG IN MASONRY WALL 22.2. PLUMBING CHASE (OR WALL) - VERIFY WITH FRAMING AND GYP. BD. EXG HISTORIC MANTLE TO BE

RETAINED AND REPAINTED. 6.8. NOT USED. 6.9. EXG HISTORIC TRIM/WAINSCOT TO BE **CONDITIONING** RE-INSTALLED IN THIS LOCATION OVER NEW FURRING. SEE FINISH SCHEDULE FOR FINISH INFORMATION.

6.10. NOT USED. RATING DETAILS A5.01

7. THERMAL AND MOISTURE

PROTECTION 7.1. NEW PRE-FINISHED GUTTER & DOWNSPOUT. SEE EXTERIOR **ELEVATIONS. TIE INTO EXISTING**

SEWER SYSTEM. 7.2. RE-LINE EXG HISTORIC BOX GUTTER. NEW PVC AT LOWER 6' OF DOWNSPOUT. PAINT TO MATCH

DOWNSPOUT. 7.4. NEW FULLY ADHERED MEMBRANE ROOF W/ CRICKETS WHERE REQUIRED FOR POSITIVE DRAINAGE AND W/TERMINATION BARS & METAL

COUNTERFLASHING - SEE ROOF DETAILS. INSULATION PER SCHEDULE. 26.2. NEW ROOF ACCESS HATCH. BILCO BASIS OF DESIGN. INSTALL PER MANUF'S

INSTRUCTS. 7.6. NEW ATTIC/ROOF BOX VENT. COORDINATE LOCATION WITH OTHER ROOF PENETRATIONS.

7.7. NEW ALUM CAP @ EXG CHIMNEY, TYP. @ ALL EXG CHIMNEYS, U.N.O. 7.8. NEW SHINGLE ROOF W/ STEP &

KICKOUT FLASHING. PROVIDE CONTINUOUS ICE & WATER SHIELD AT LOWER 4 FT, ADJ. TO BOX GUTTER. 7.9. NEW ROOF TO WALL FLASHING. 7.10. NEW EDGE FLASHING/RAKE BD. TO

MATCH EXG. SEE ELEVATIONS. 7.11. DOWNSPOUT TO BE ROUTED THROUGH BUILDING PER PLUMBING DRAWINGS.

8. OPENINGS

8.1. NEW ALUMINUM CLAD WINDOW INSTALLED IN EXG OPENING. SEE WINDOW TYPES FOR MORE INFORMATION. 8.2. NEW ALUMINUM STOREFRONT IN BEHIND PLUMBING/CHASE/FURRING WALL. FIRE RATING TO BE CONTINUOUS AT INTERSECTION W/ NON-RATED WALL.

REPAIR & REFINISH EXISTING HARDWOOD FLOORING/SUBFLOOR. SEE FINISH SCHEDULE FOR MORE

INFORMATION. 9.3. NEW HARDWOOD FLOORING ON EXG SUBFLOOR. SEE FINISH SCHEDULE FOR

MORE INFORMATION. 9.4. PAINT EXTERIOR WALL. SEE SHEET A8.00 FOR MORE INFORMATION. OPENING IS TO BE MADE IN SUCH A 9.5. LINE OF DRYWALL SOFFIT/BULKHEAD ABOVE. SEE RCPS.

10.1. LOCKABLE & RECESSED MAILBOXES. BOXES TO MEET USPS-4C STANDARDS & REQUIREMENTS. PROVIDE CONT FIRE-RATING BEHIND MAILBOXES, WHEN REQ.

10.2. FIRE EXTINGUISHER/CABINET. SEE LIFE SAFETY PLANS A0.01. SEMI-RECESSED WITH WHITE FINISH. WHERE LOCATED IN FIRE-RATED WALLS, PROVIDE FIRE-RATED CABINET.

CLOSETS W/ BLOCKING AT RODS & BRACKETS: TYP. A. ENCLOSED CLOSET: 12" DEEP

MELAMINE SHELF & CLOTHES ROD AT 66" AFF.; TYP U.N.O. B. ADJUSTABLE SHELVES ON STÁNDARD MOUNT.

21. FIRE SUPPRESSION 21.1. APPROXIMATE LOCATION OF FDC

CONNECTION - COORDINATE W/ FIRE

21.2. APPROXIMATE LOCATION OF SPRINKLER RISER/STANDPIPE -COORDINATE W/ FIRE DEPT AND SPRINKLER CONTRACTOR. 21.3. PORTABLE FIRE EXTINGUISHER BELOW

SINK IN RESIDENTIAL UNIT. ĬPŘŎVIĎĚ Ž-HŘ ŘATÍŇĞ ŎĔ SUPPORTING STRUCTURE ABOVE. SEE F/C ASSEMBLY "C"/A6.01

22.1. PROVIDE 3 $\frac{1}{2}$ "Ø PIPE IN WALL FRAMING FOR RADON RISER. RISER TO EXTEND FROM BASEMENT TO ATTIC. PROVIDE POWER AND ACCESS PANEL IN ATTIC/UPPER FLOOR FOR FUTURE RADON FAN.

Progress Dates

08.15.2022 - BID SET

05.26.2022 - PERMIT REV I

06.15.2022 - PERMIT REV 2

MR, TB, SO, MR

Drawn by:

TB, MR

08.19.2023 - ENG CHANGE I

LOCATIONS IN FIELD TO ALIGN CONCEALMENT BETWEEN FLOORS.

23. HEATING, VENTILATING, AND AIR

23.1. NEW MECHANICAL UNIT(S) - WALKING PADS TO & AROUND EQUIPMENT. **GUARDRAIL REQUIRED IF EQUIPMENT** <10' FROM ROOF EDGE. SEE HVAC & STRUCTURAL DWGS. ROOF <3:12,

INSTALL C.U. ON SOUND ISOLATING 23.2. WALL CAVITY FOR FUTURE EXHAUST DUCT - COORDINATE W/

MECHANICAL DWGS. 23.3. TRANSFER GRILLE ABOVE/ADJACENT TO DOOR. SEE MECHANICAL DWGS

FOR MORE INFORMATION AND SIZING. 23.4. SHAFT BELOW SHOWN DASHED. PROVIDE TEMP. ROOFING.

26. ELECTRICAL

26.1. ELECTRIC PANEL RECESSED IN WALL W/ 30"W X 36"D CLEAR IN FRONT. PAINT TO MATCH ADJACENT WALL W/ APPROPRIATE PAINT TYPE FOR PANEL. SEE ELECTRICAL DWGS.

INSTALL A RECESSED BOX WITH **COVER PLATE FOR FUTURE EXTERIOR** LIGHTING IN THIS LOCATION. PAINT TO MATCH ADJACENT MASONRY. 26.3. ENTRY SECURITY SYSTEM FOB READER. 26.4. RECESSED ENTRY SECURITY SYSTEM

32. EXTERIOR IMPROVEMENTS

INTERCOM/CALL BOX.

32.1. NEW FABRIC ON EXG AWNINGS. COORDINATE COLOR WITH OWNER/ARCHITECT.

32.2. RE-INSTALL/RE-MOUNT EXG WINDOW FLOWER BOXES & WINDOW BOX WATER LINES. PAINT WATER LINES TO MATCH EXG ADJ EXTERIOR MASONRY.

HISTORIC OPENING - SEE EXTERIOR

KEYNOTE EXISTING EXTERIOR/BEARING WALL EXISTING INTERIOR WALL NEW PARTITION WALL

NEW FLOOR & FRAMING TO MATCH ADJACENT- SEE STRUCT DWGS

EMERGENCY EGRESS EXIT

X'-X" ELEVATION TAG

NEW WORK PLANS GRAPHIC KEY: #/ PARTITION TYPE: SEE SHEET A6.00 NEW GYP BD SOFFIT/ DROPPED CLG: SEE DETAILS ON A6.01

AREA OF ATYPICAL FIRE-RATED ASSEMBLY ABOVE. SEE KEYNOTES + A6.00

DOOR TAG. SEE SCHEDULE: A6.20

WINDOW DESIGNATION. SEE A6.30 STOREFRONT DESIGNATION. SEE A6.10

SG OPENING CONTAINS SAFETY GLAZING


Job No: 22005 02.25.2022

PROPOSED PLAN - BASEMENT

NEW MASONRY WALL OBJECT OVERHEAD I-HR FIRE RATING: SEE SHEET A6.00 2-HR FIRE RATING: SEE SHEET A6.00

FR NEW STRUCTURAL MEMBERS - SEE STRUCT DWGS (FR=FIRE RATING)

SCALE: 1/4" = 1'-0"

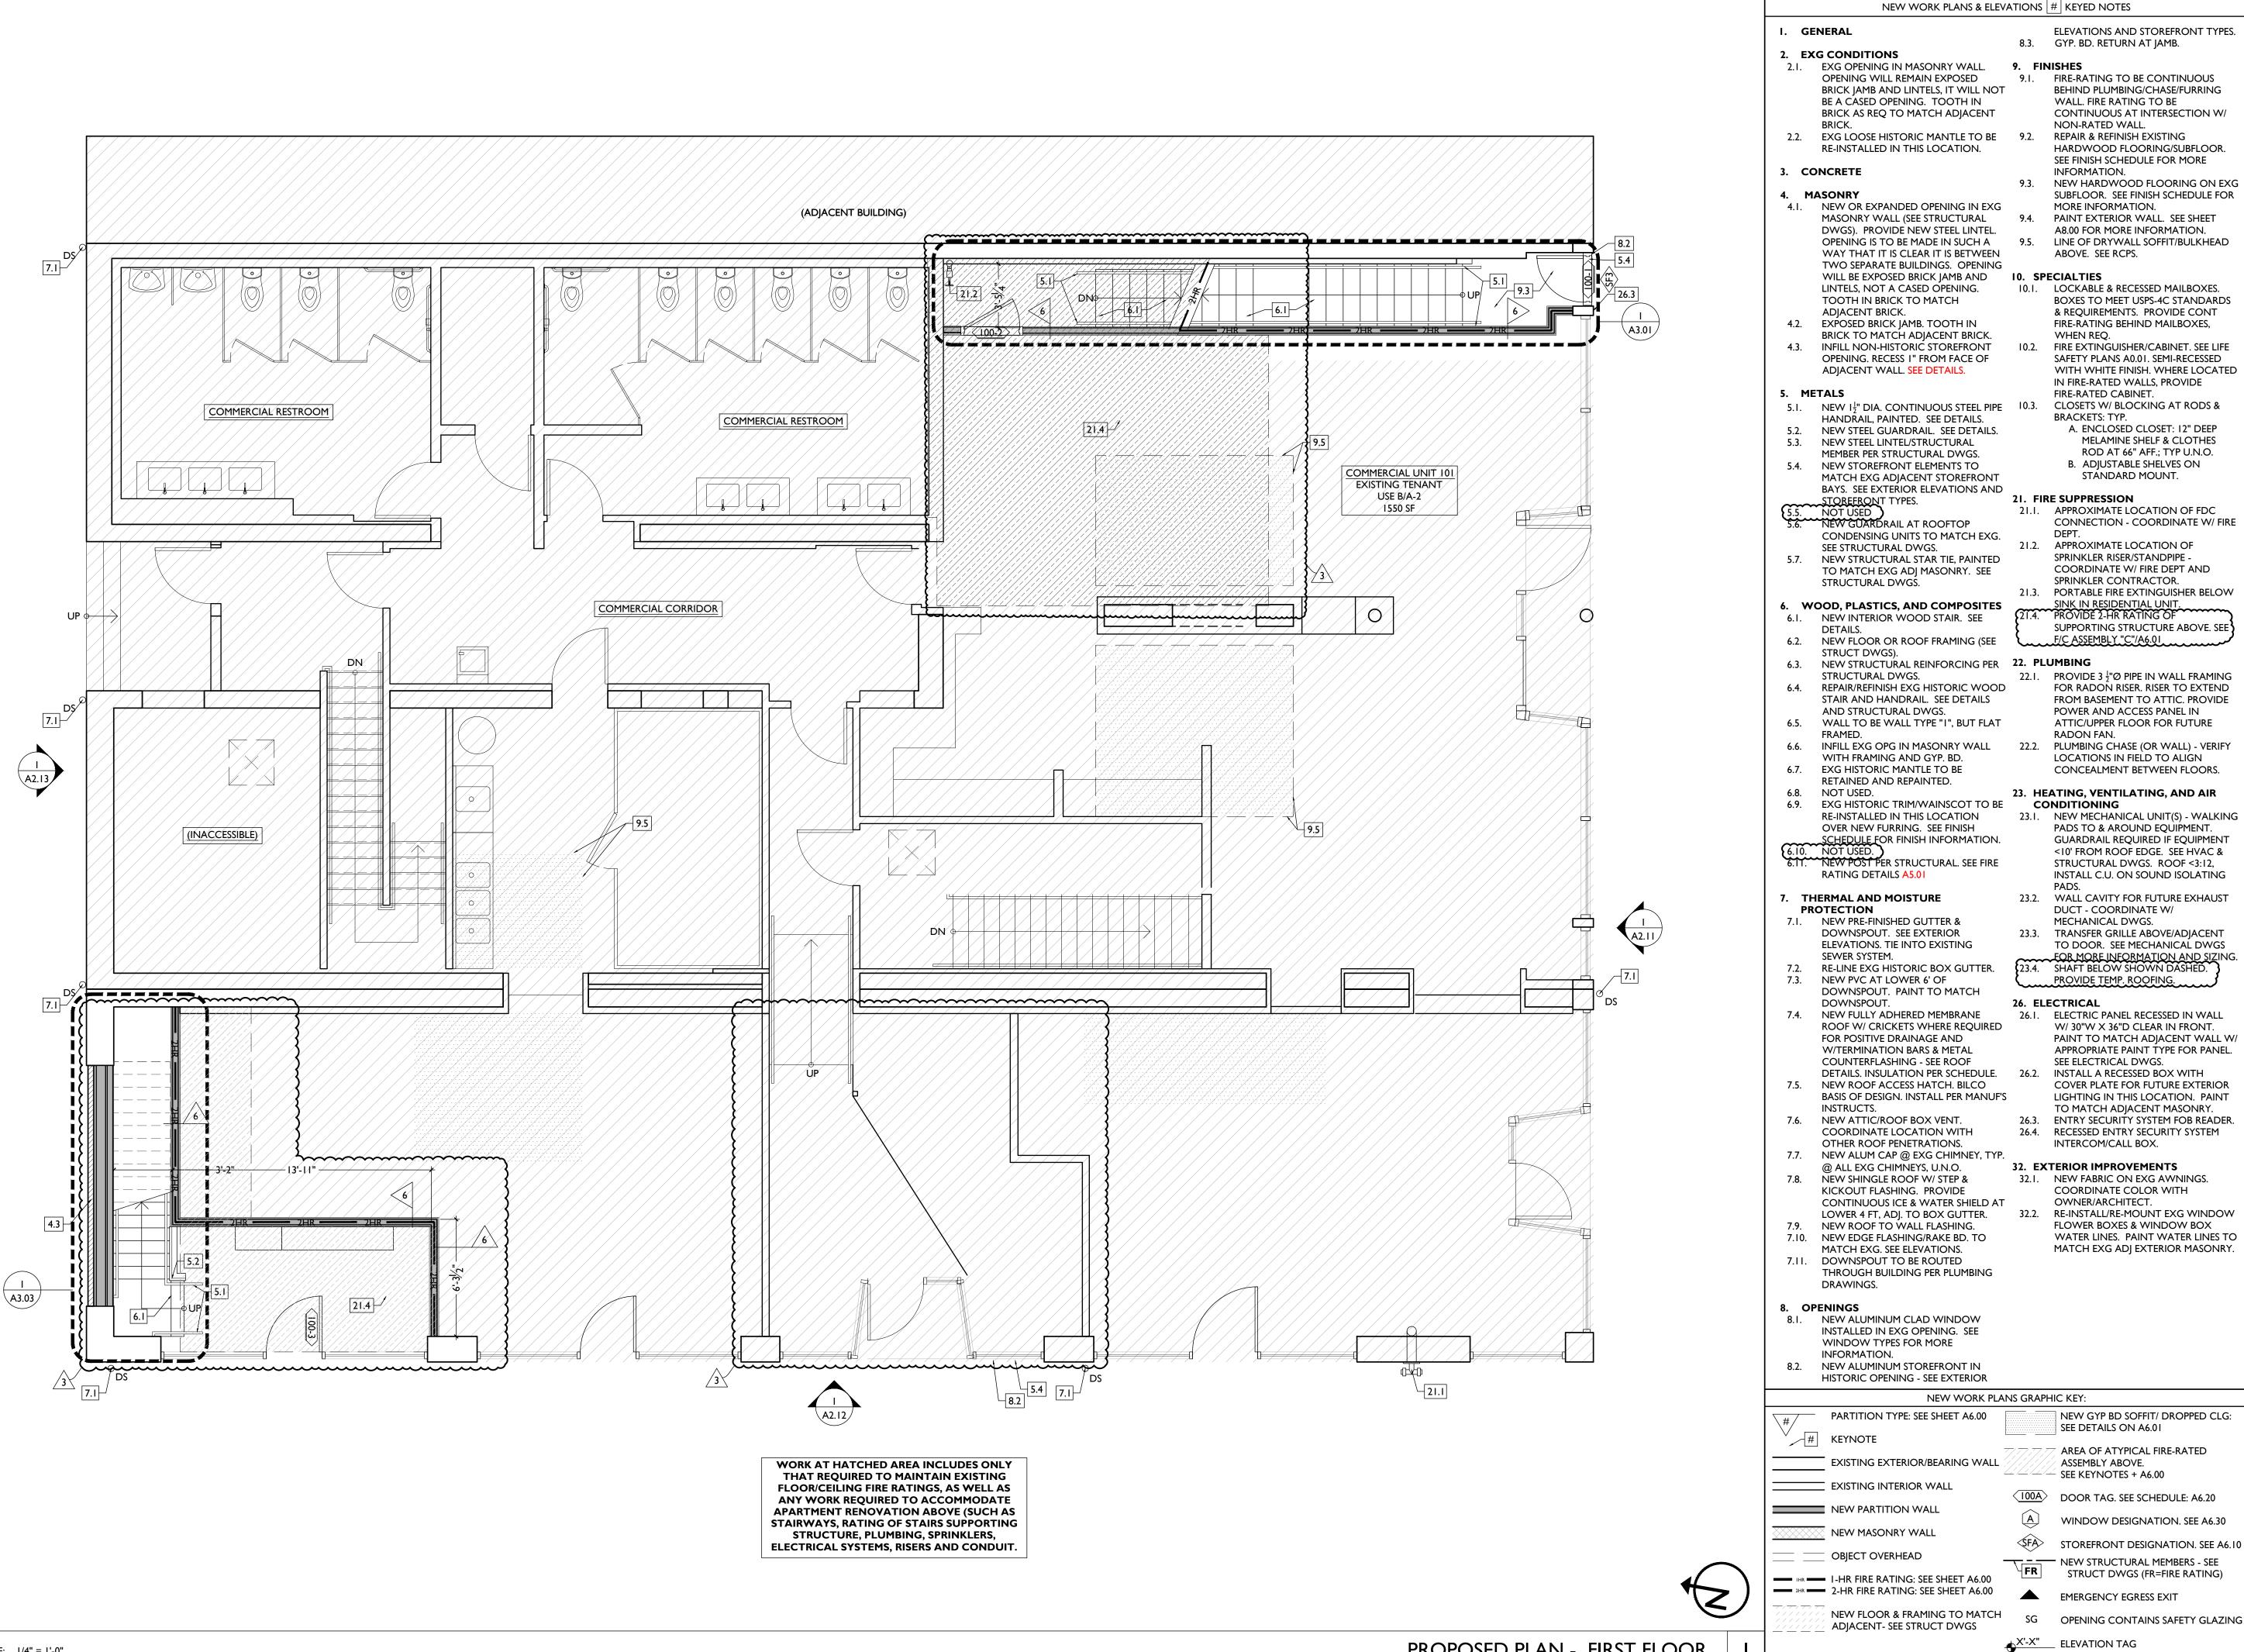

SCALE: 1/4" = 1'-0"

Progress Dates 08.15.2022 - BID SET

05.26.2022 - PERMIT REV I 06.15.2022 - PERMIT REV 2 08.19.2023 - ENG CHANGE I

TB, MR

MR, TB, SO, MR Drawn by:


TO DOOR. SEE MECHANICAL DWGS

W/ 30"W X 36"D CLEAR IN FRONT. PAINT TO MATCH ADJACENT WALL W/ APPROPRIATE PAINT TYPE FOR PANEL.

COVER PLATE FOR FUTURE EXTERIOR LIGHTING IN THIS LOCATION. PAINT TO MATCH ADJACENT MASONRY.

FLOWER BOXES & WINDOW BOX WATER LINES. PAINT WATER LINES TO

WINDOW DESIGNATION. SEE A6.30

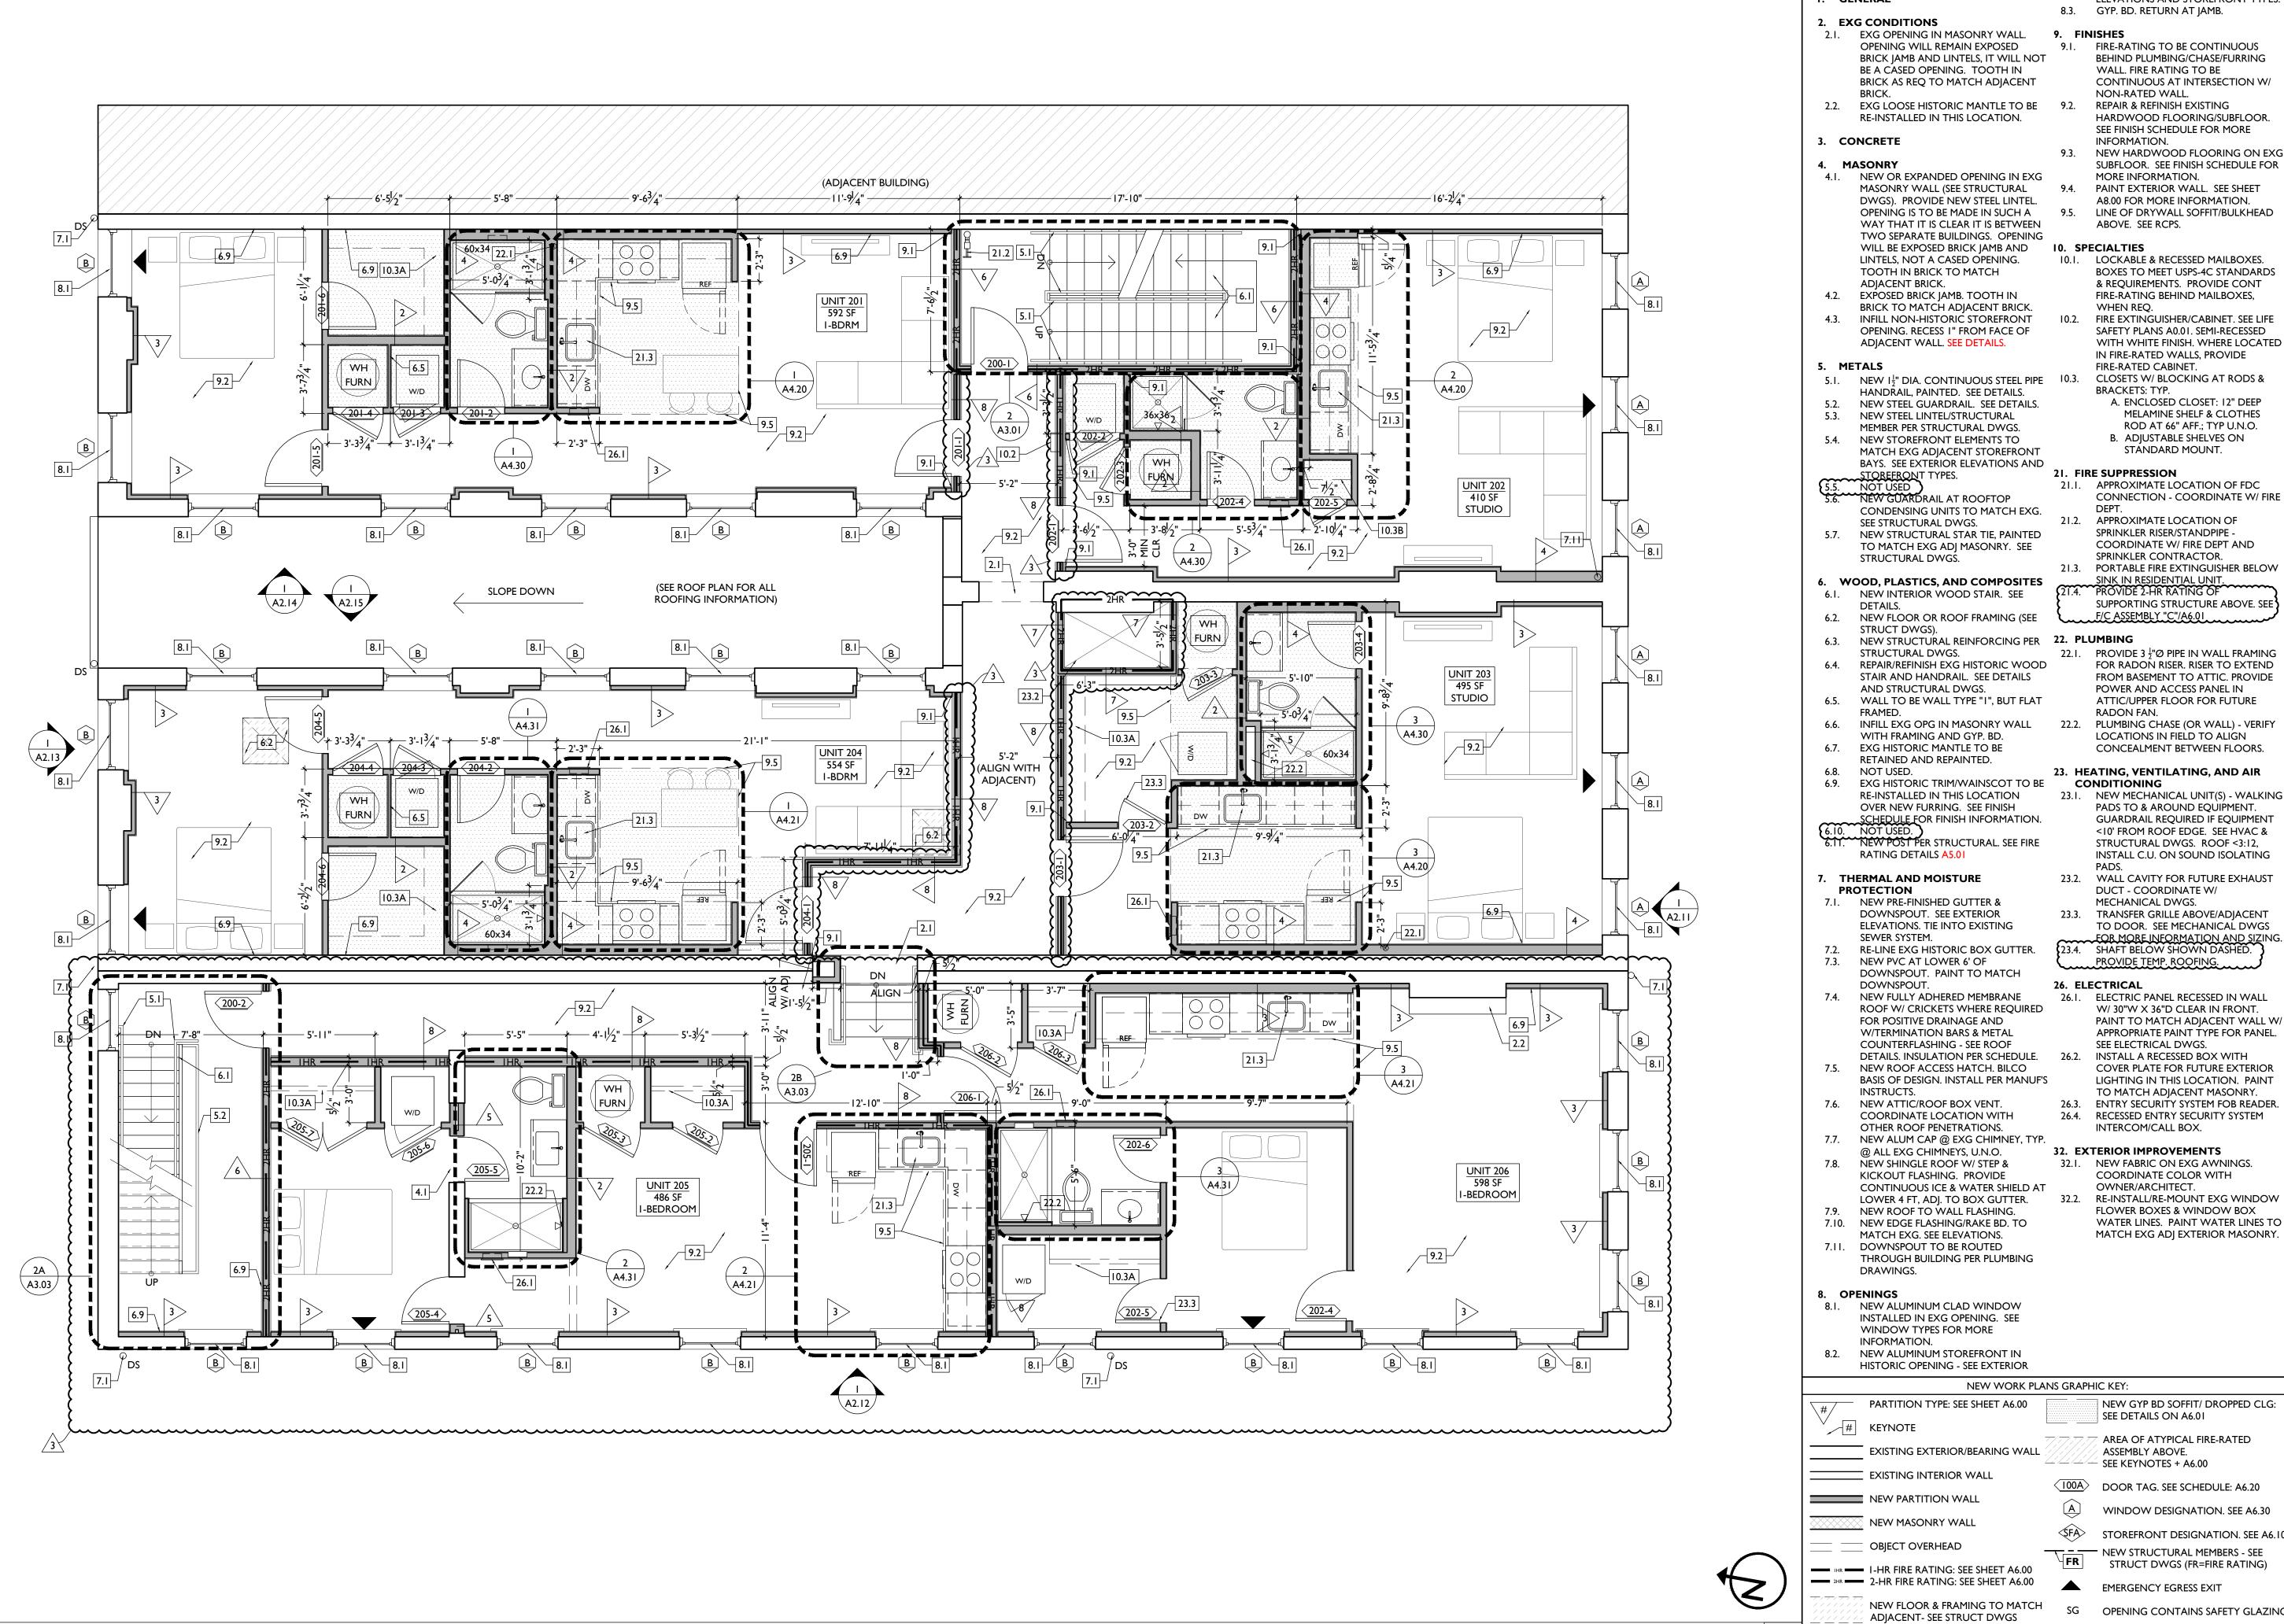

SCALE: 1/4" = 1'-0"

ELEVATIONS AND STOREFRONT TYPES.

I. GENERAL

NEW WORK PLANS & ELEVATIONS # KEYED NOTES

9.1. FIRE-RATING TO BE CONTINUOUS BEHIND PLUMBING/CHASE/FURRING WALL. FIRE RATING TO BE CONTINUOUS AT INTERSECTION W/

NON-RATED WALL. REPAIR & REFINISH EXISTING HARDWOOD FLOORING/SUBFLOOR. SEE FINISH SCHEDULE FOR MORE

9.3. NEW HARDWOOD FLOORING ON EXG

9.4. PAINT EXTERIOR WALL. SEE SHEET A8.00 FOR MORE INFORMATION.

10.1. LOCKABLE & RECESSED MAILBOXES. BOXES TO MEET USPS-4C STANDARDS & REQUIREMENTS. PROVIDE CONT FIRE-RATING BEHIND MAILBOXES,

10.2. FIRE EXTINGUISHER/CABINET. SEE LIFE SAFETY PLANS A0.01. SEMI-RECESSED WITH WHITE FINISH. WHERE LOCATED IN FIRE-RATED WALLS, PROVIDE FIRE-RATED CABINET.

CLOSETS W/ BLOCKING AT RODS & A. ENCLOSED CLOSET: 12" DEEP

MELAMINE SHELF & CLOTHES ROD AT 66" AFF.; TYP U.N.O. B. ADJUSTABLE SHELVES ON

21.1. APPROXIMATE LOCATION OF FDC

CONNECTION - COORDINATE W/ FIRE

21.2. APPROXIMATE LOCATION OF SPRINKLER RISER/STANDPIPE -COORDINATE W/ FIRE DEPT AND SPRINKLER CONTRACTOR.

SINK IN RESIDENTIAL UNIT. PROVIDE 2-HR RATING OF SUPPORTING STRUCTURE ABOVE. SEE

22.1. PROVIDE 3 $\frac{1}{2}$ "Ø PIPE IN WALL FRAMING FOR RADON RISER. RISER TO EXTEND FROM BASEMENT TO ATTIC. PROVIDE POWER AND ACCESS PANEL IN ATTIC/UPPER FLOOR FOR FUTURE

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PLUMBING CHASE (OR WALL) - VERIFY LOCATIONS IN FIELD TO ALIGN CONCEALMENT BETWEEN FLOORS.

23.1. NEW MECHANICAL UNIT(S) - WALKING PADS TO & AROUND EQUIPMENT. **GUARDRAIL REQUIRED IF EQUIPMENT** <10' FROM ROOF EDGE. SEE HVAC & STRUCTURAL DWGS. ROOF <3:12,

23.2. WALL CAVITY FOR FUTURE EXHAUST DUCT - COORDINATE W/

23.3. TRANSFER GRILLE ABOVE/ADJACENT TO DOOR. SEE MECHANICAL DWGS

FOR MORE INFORMATION AND SIZING. 23.4. SHAFT BELOW SHOWN DASHED. PROVIDE TEMP. ROOFING.

W/ 30"W X 36"D CLEAR IN FRONT. PAINT TO MATCH ADJACENT WALL W/ APPROPRIATE PAINT TYPE FOR PANEL. SEE ELECTRICAL DWGS.

INSTALL A RECESSED BOX WITH **COVER PLATE FOR FUTURE EXTERIOR** LIGHTING IN THIS LOCATION. PAINT TO MATCH ADJACENT MASONRY. 26.3. ENTRY SECURITY SYSTEM FOB READER.

32. EXTERIOR IMPROVEMENTS

OWNER/ARCHITECT.

COORDINATE COLOR WITH

32.2. RE-INSTALL/RE-MOUNT EXG WINDOW FLOWER BOXES & WINDOW BOX WATER LINES. PAINT WATER LINES TO MATCH EXG ADJ EXTERIOR MASONRY.


OOR TAG. SEE SCHEDULE: A6.20

WINDOW DESIGNATION. SEE A6.30 STOREFRONT DESIGNATION, SEE A6.1

OPENING CONTAINS SAFETY GLAZING X'-X" ELEVATION TAG

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PROPOSED PLAN - SECOND FLOOR

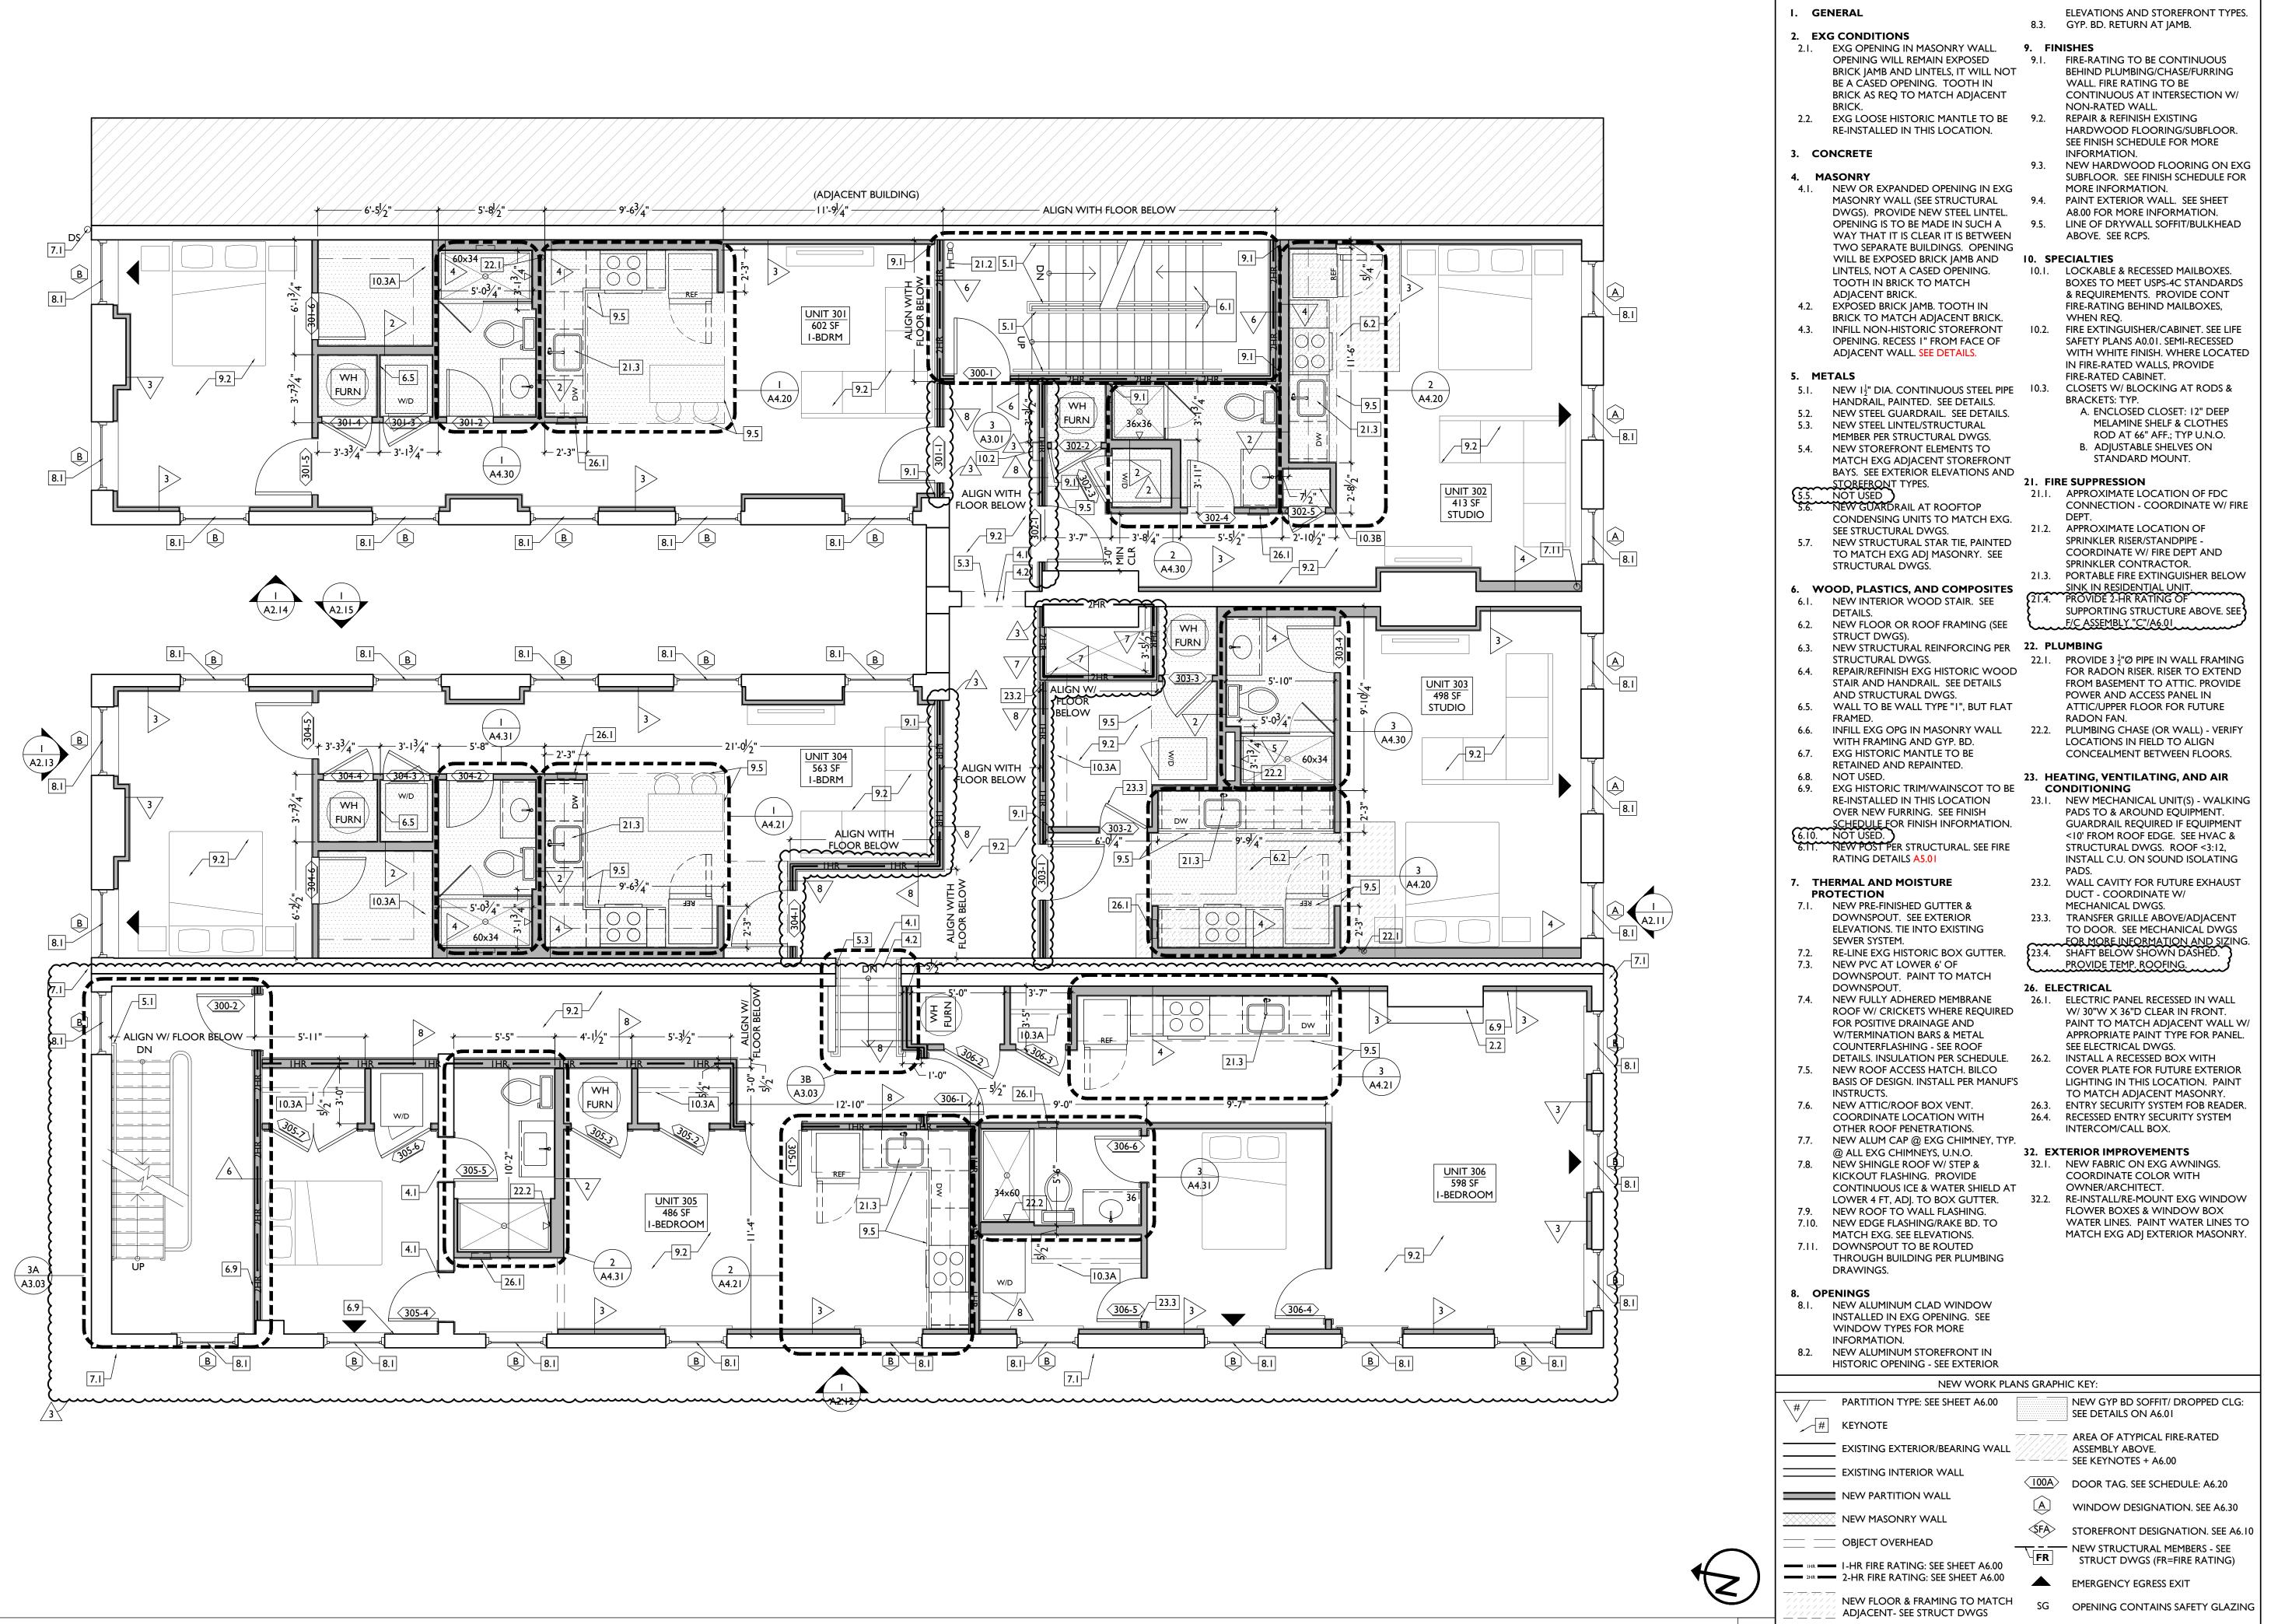

SCALE: 1/4" = 1'-0"

PROPOSED PLAN - THIRD FLOOR

NEW WORK PLANS & ELEVATIONS # KEYED NOTES

X'-X" ELEVATION TAG

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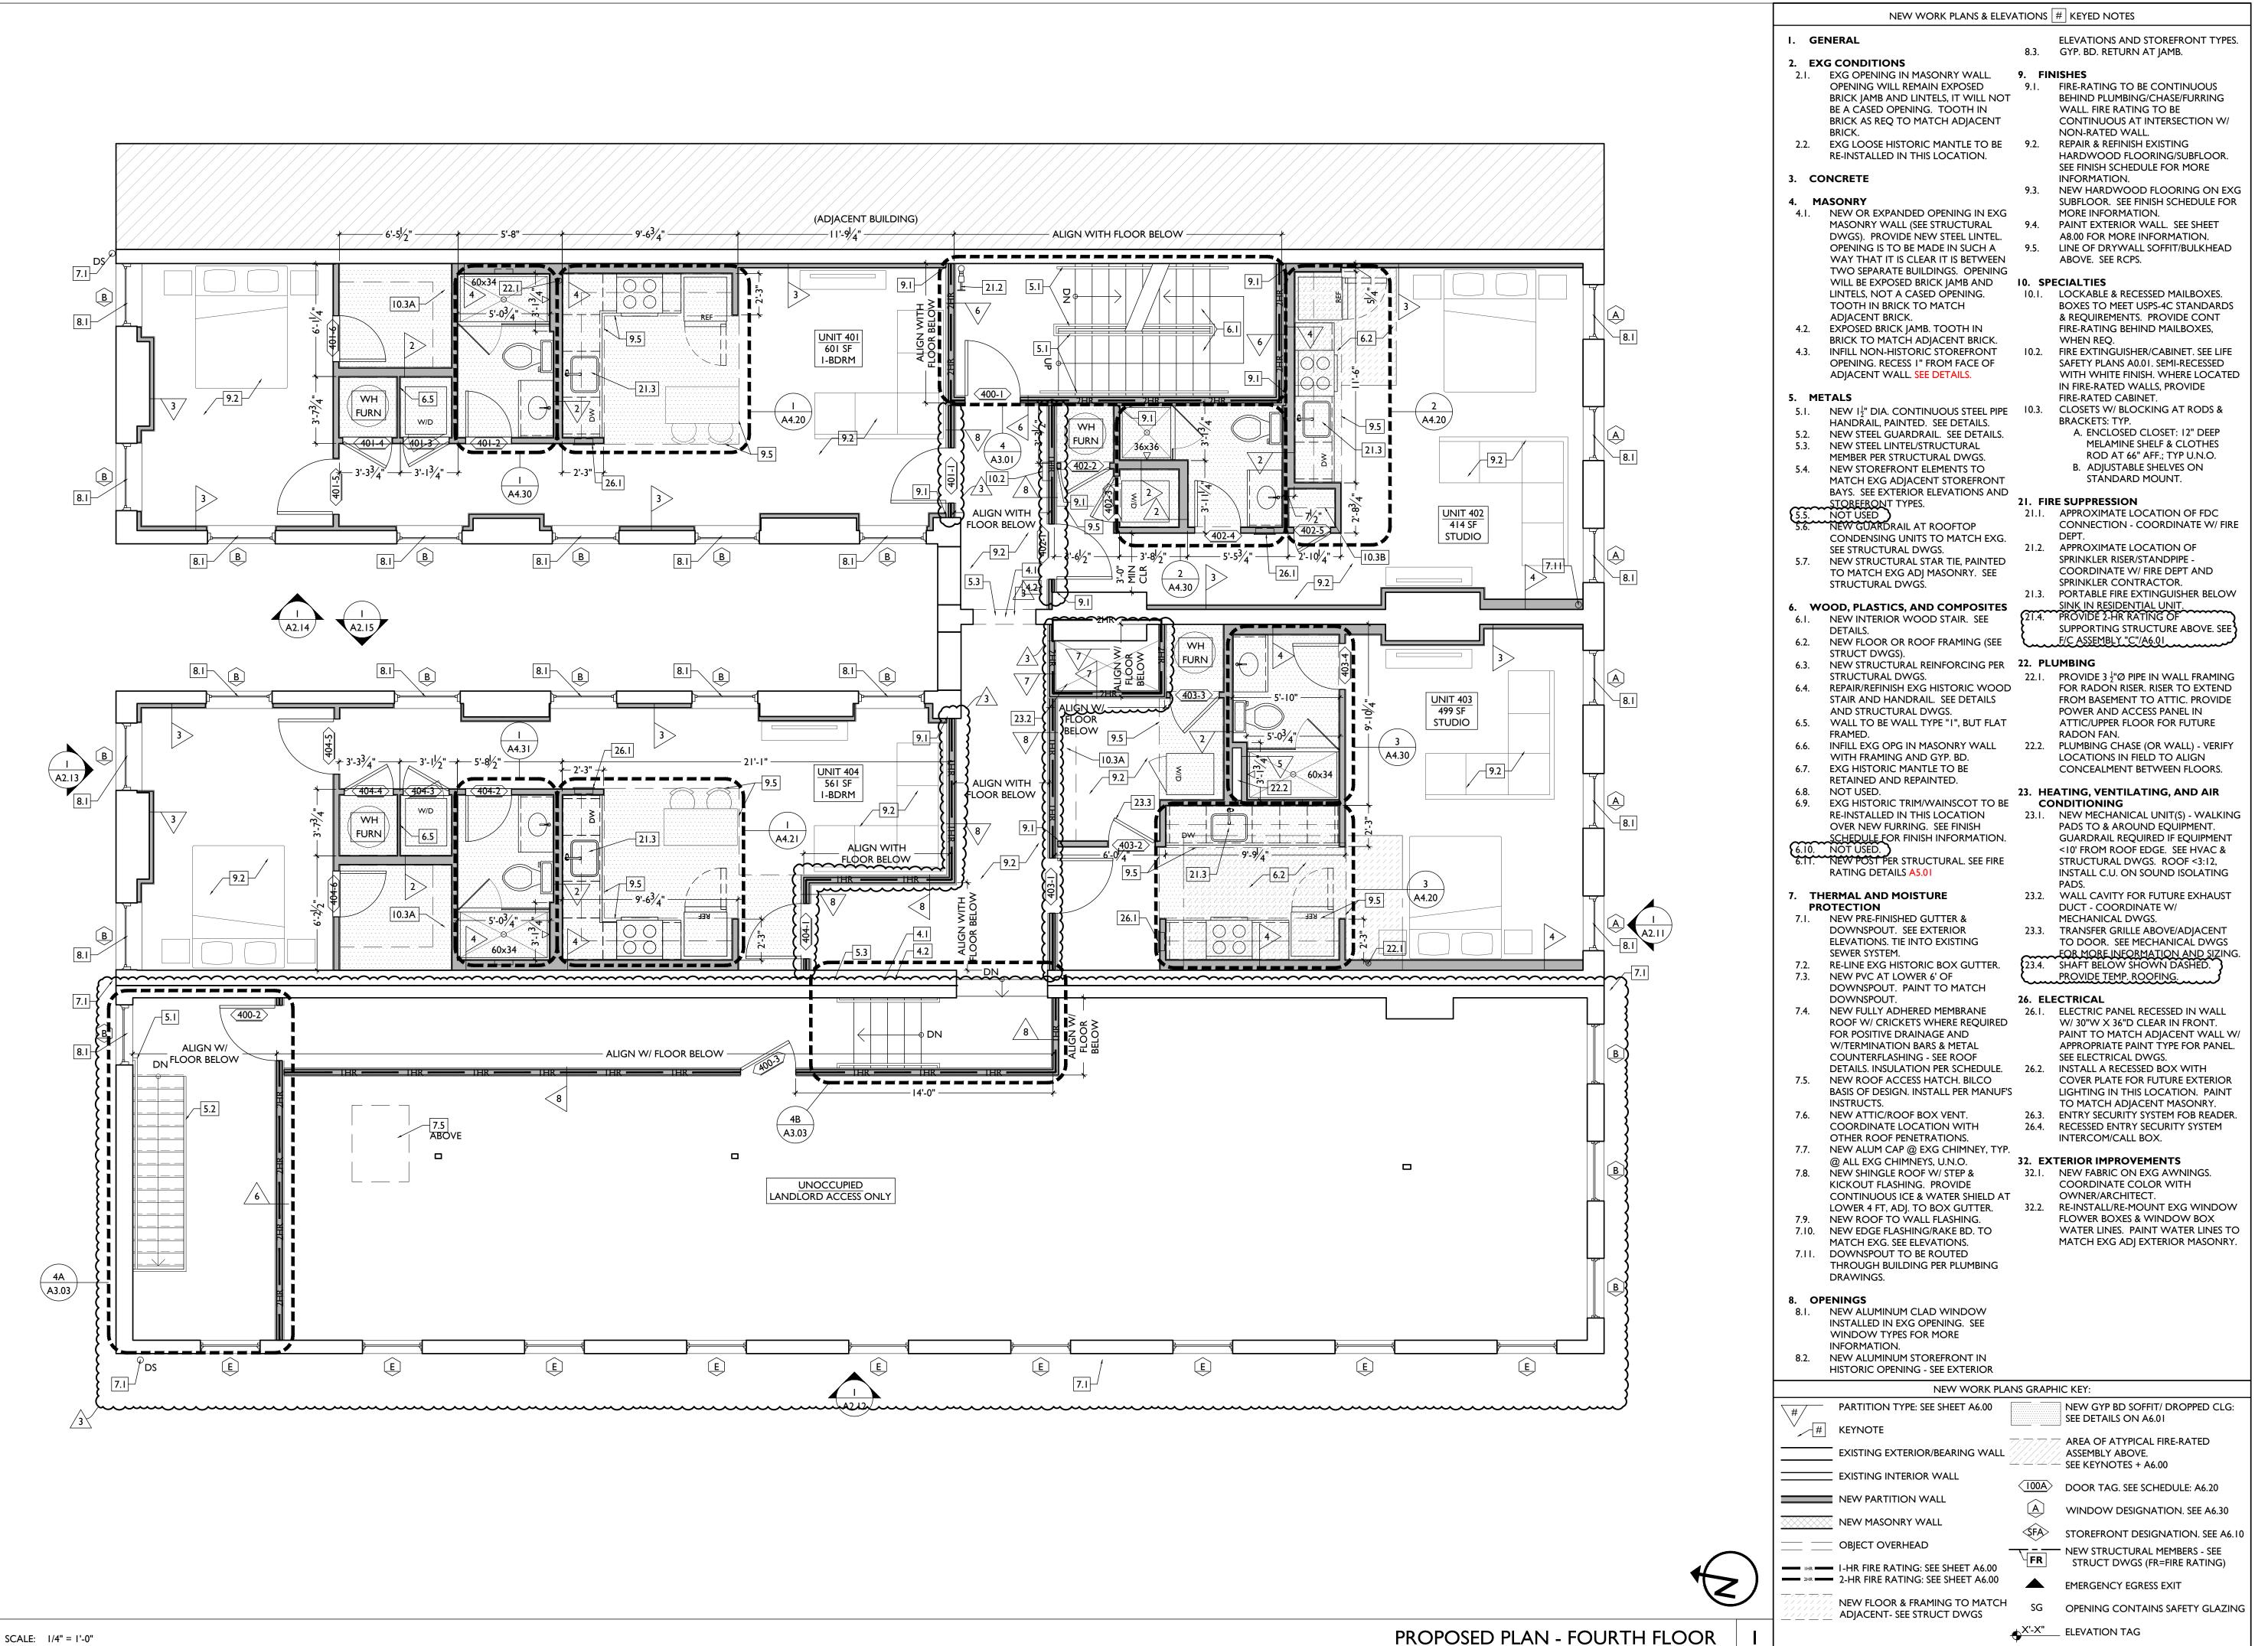
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Progress Dates

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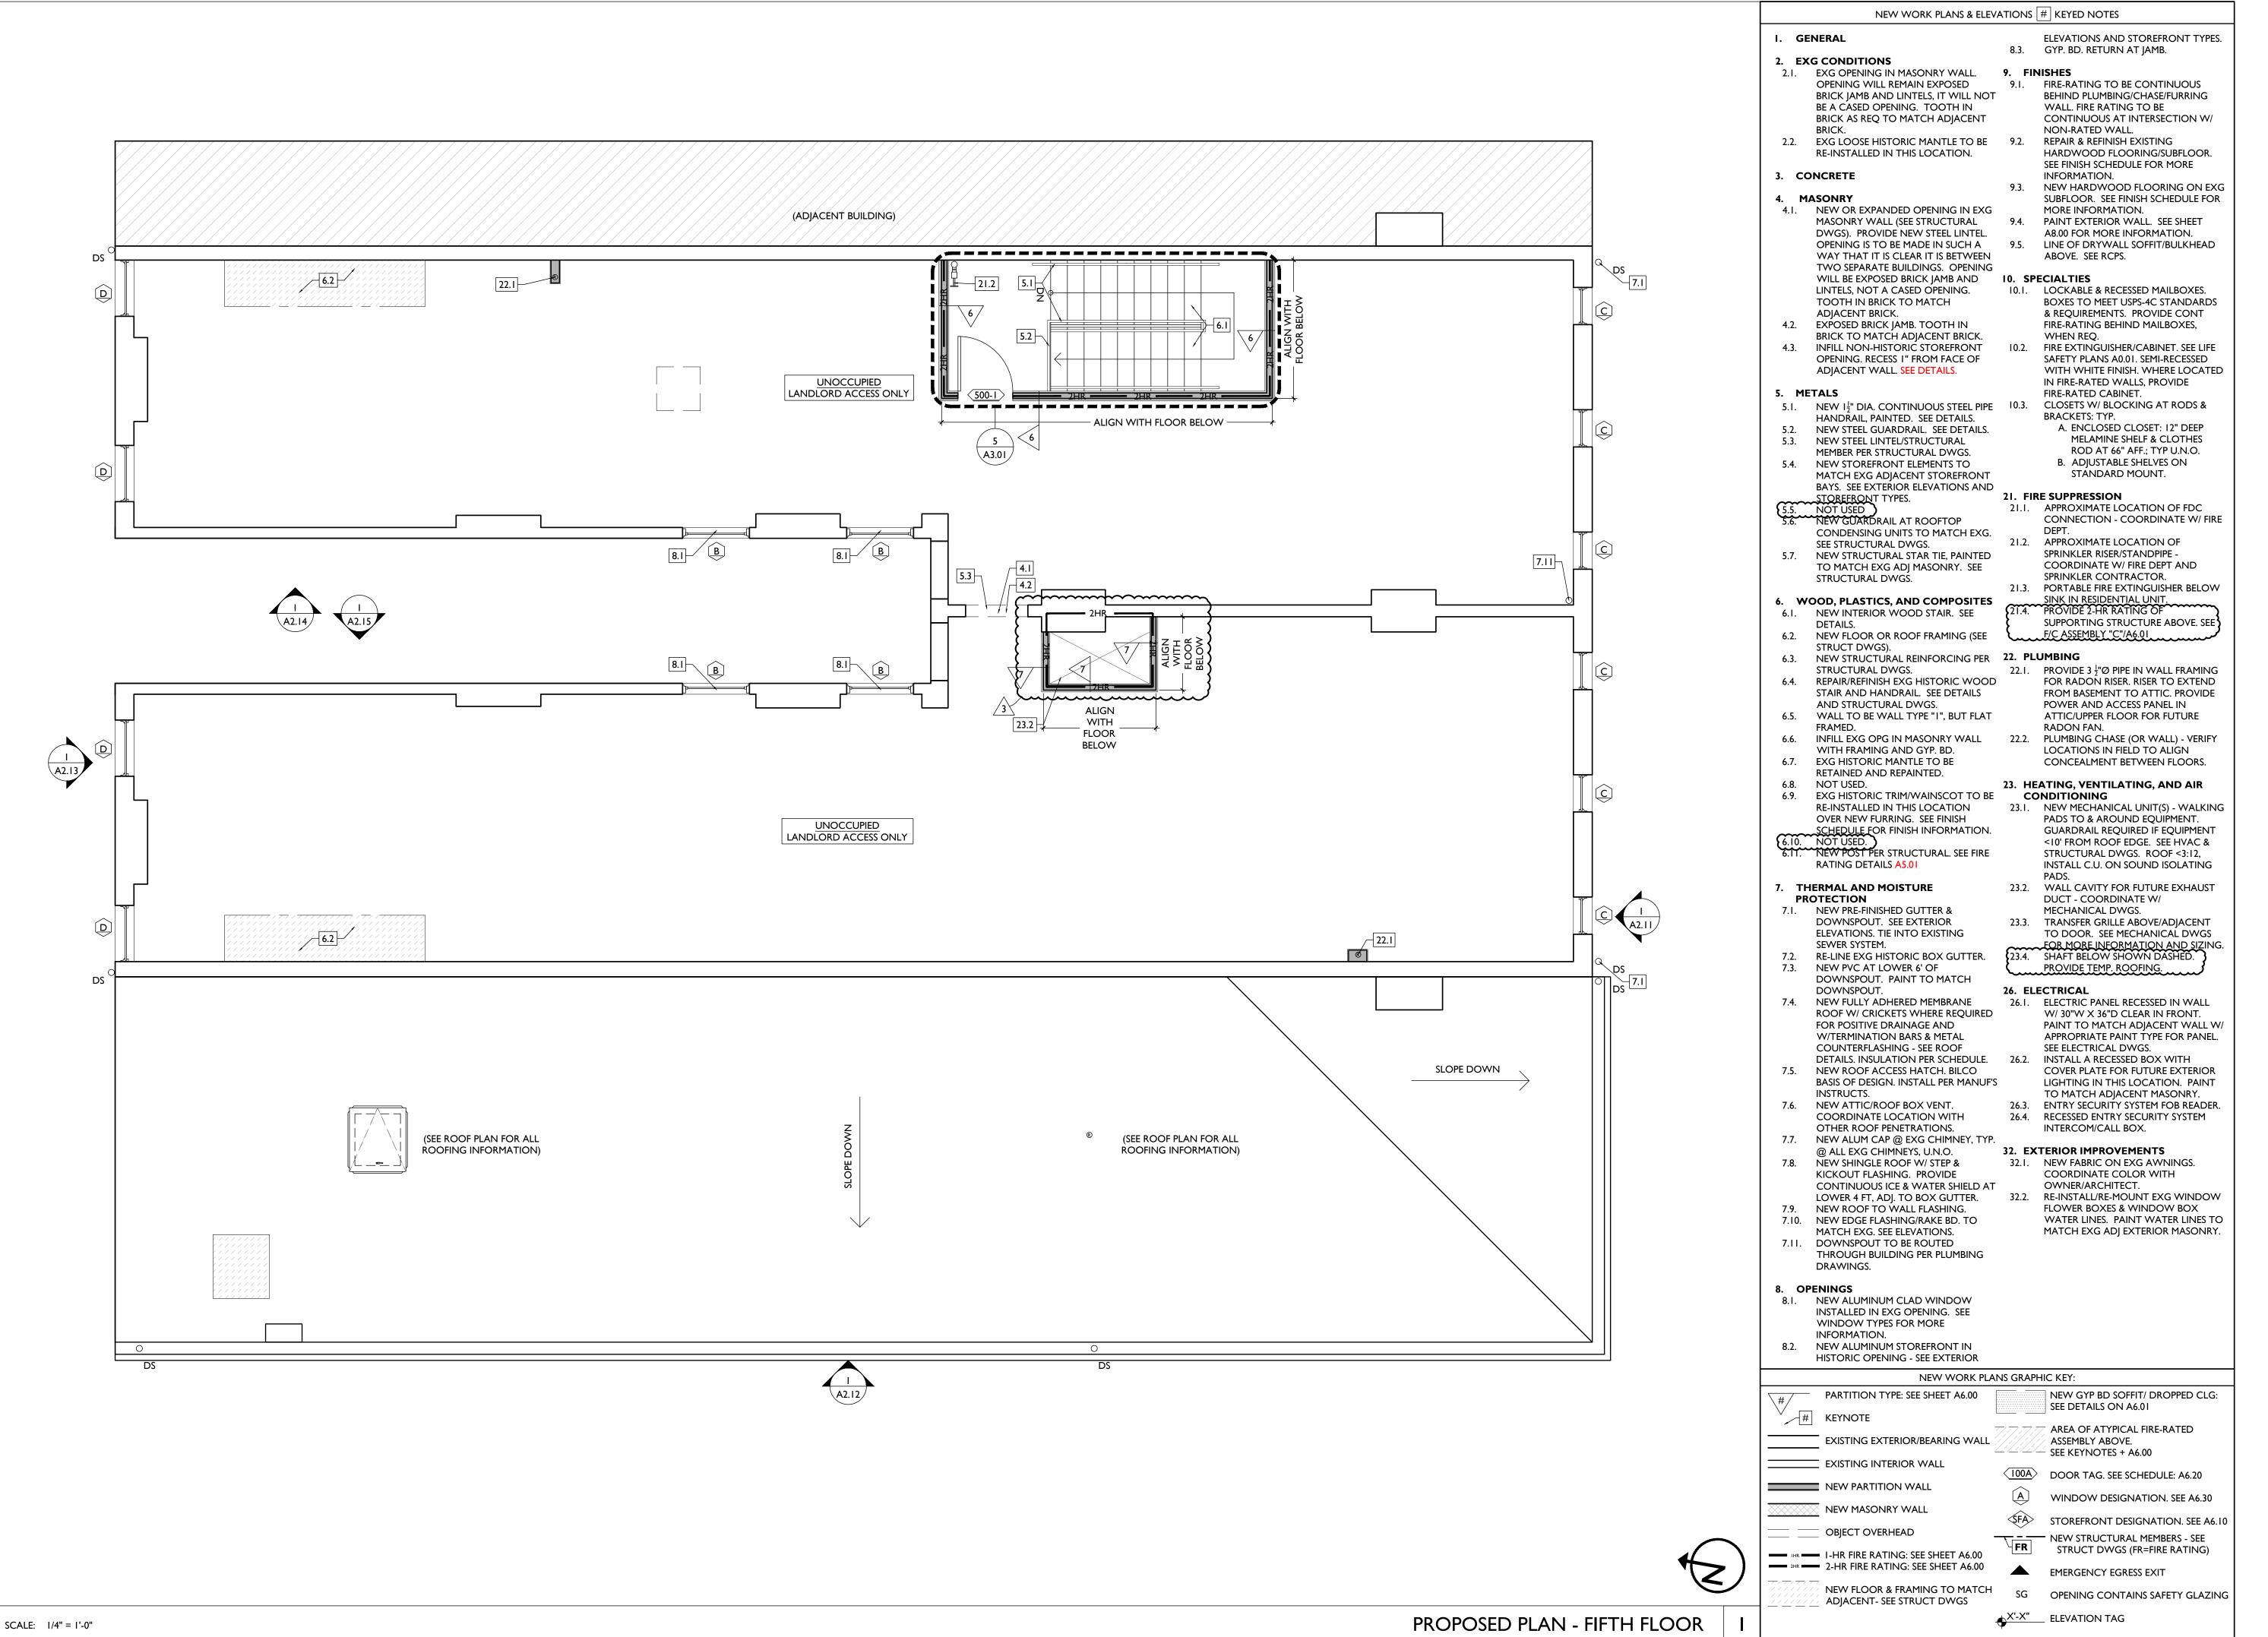
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MR, TB, SO, MR

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TB, MR

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LATTE chitecture + design

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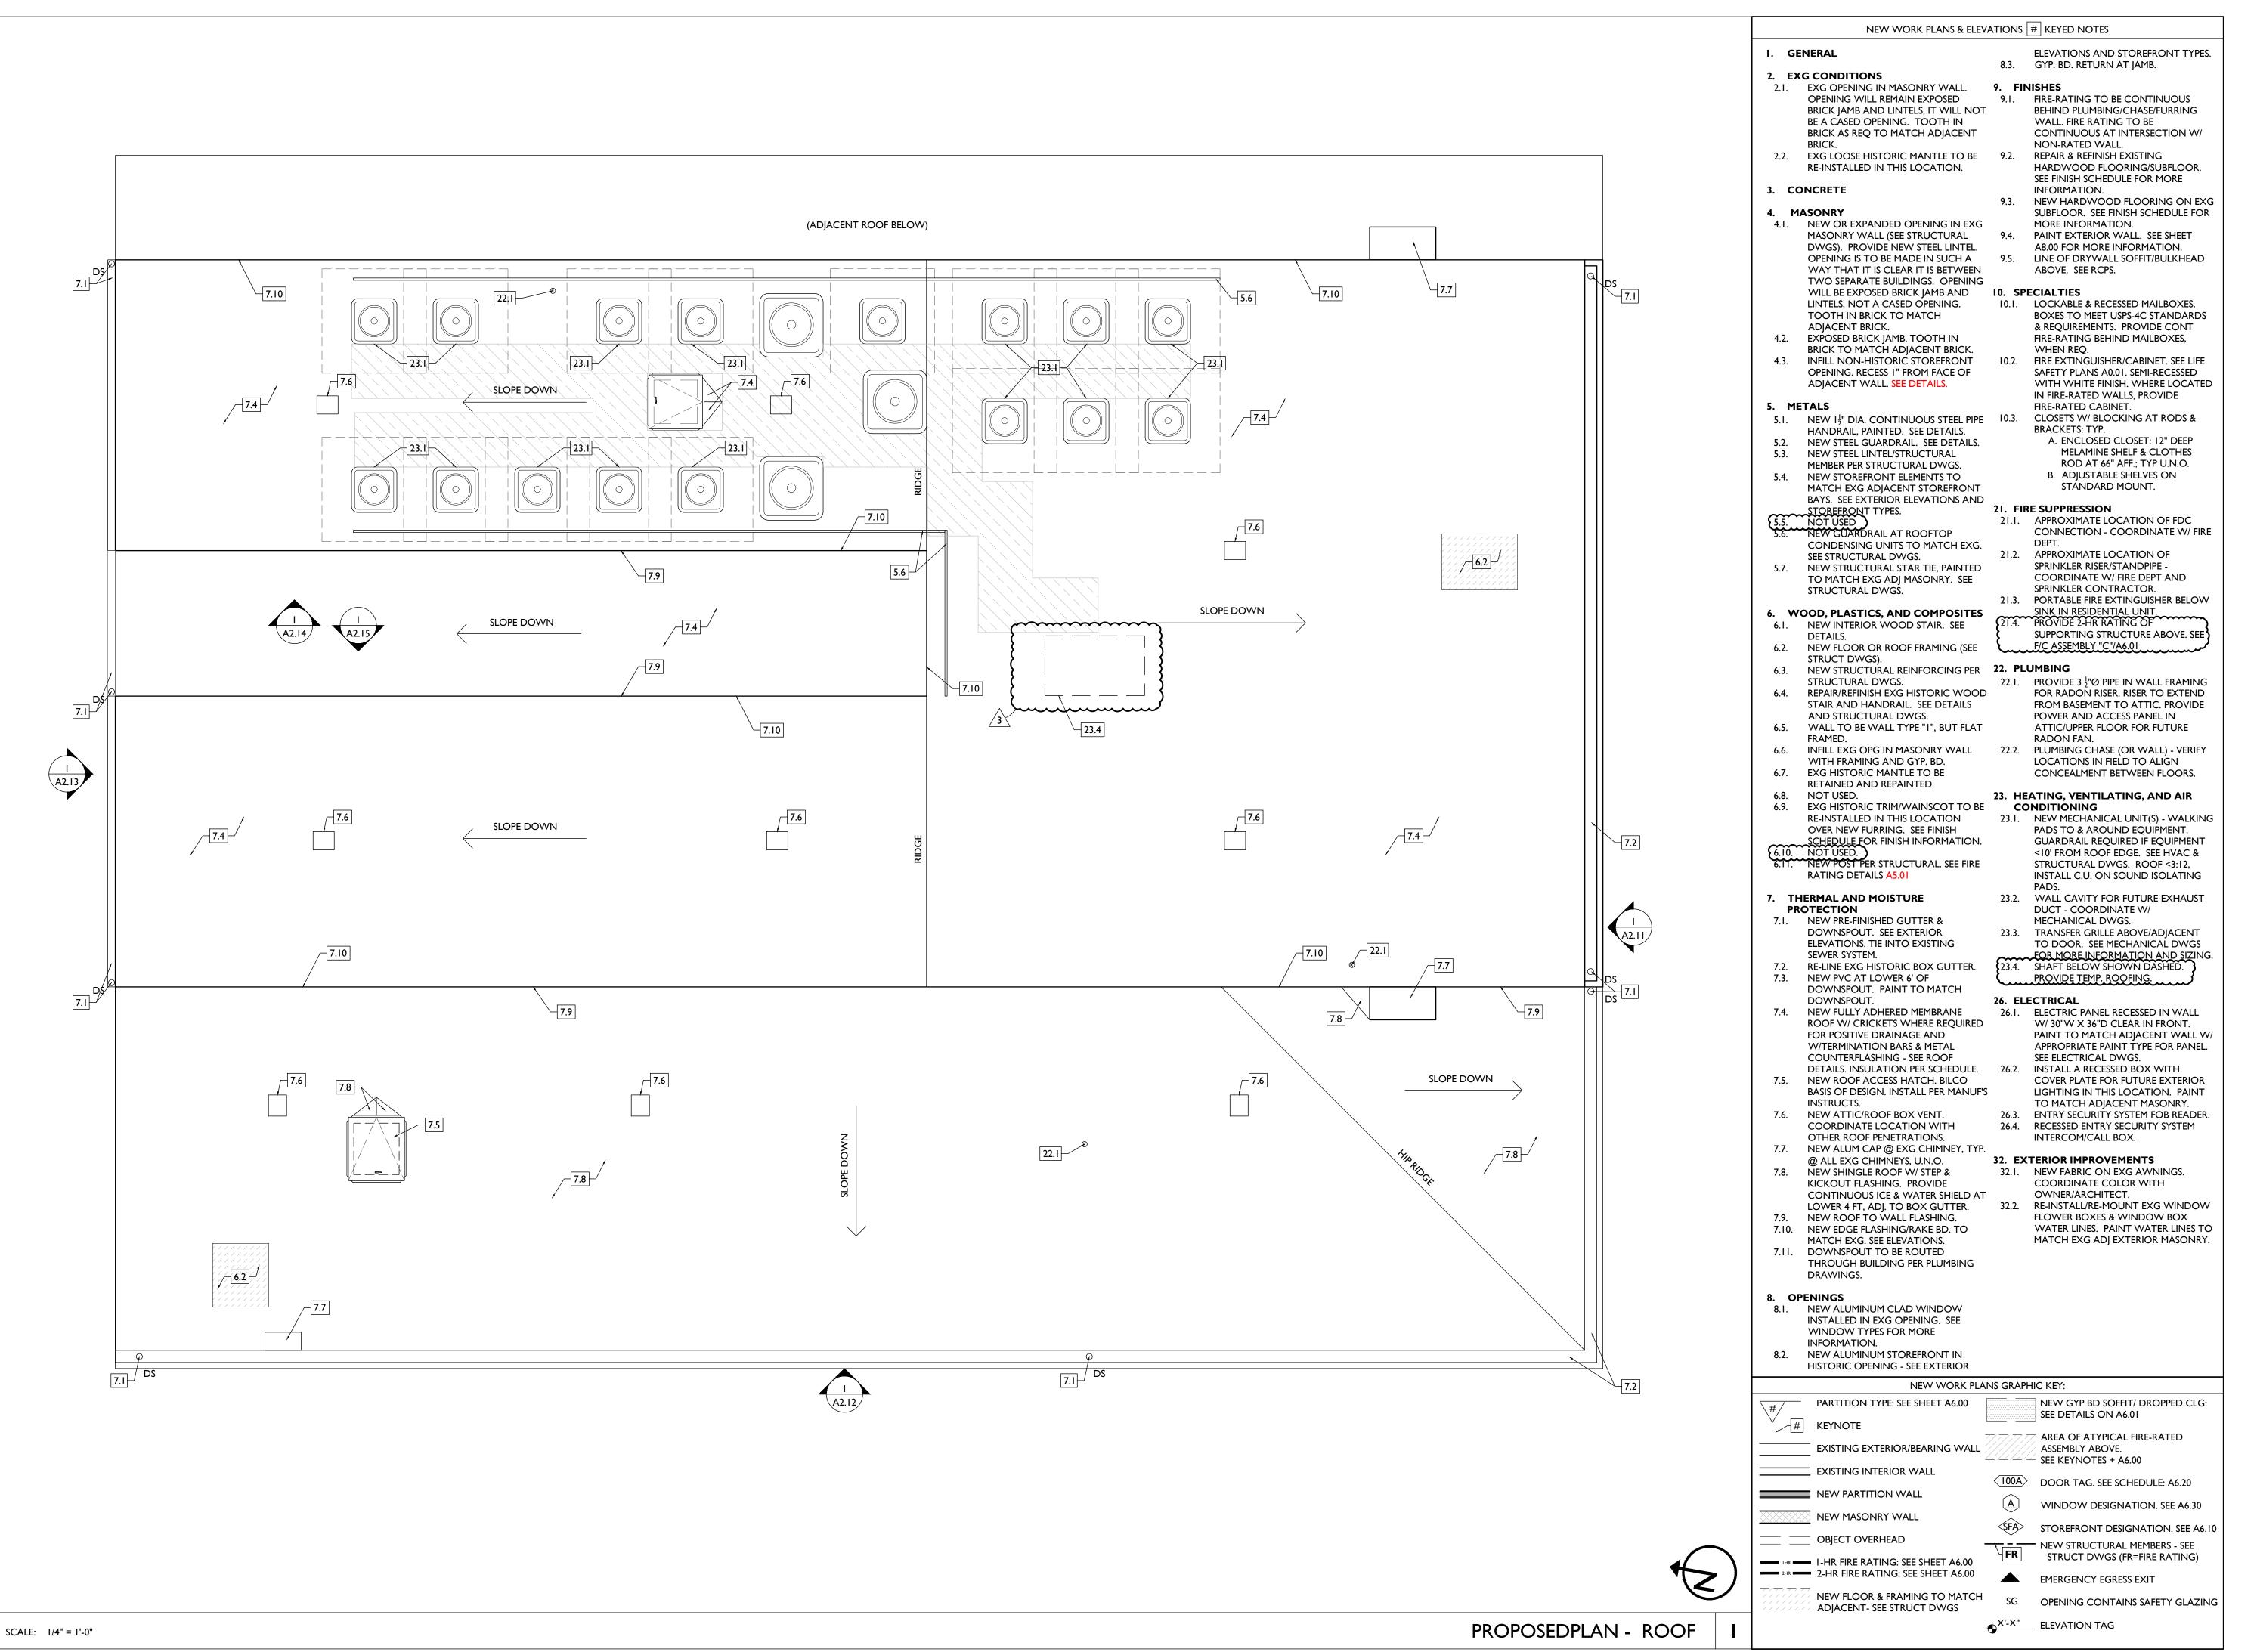
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Drawn by:

TB, MR

AI.I



PLATTE architecture + design


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Design Team: MR, TB, SO, MR Drawn by: TB, MR

 $\Delta II6$



WORK AT HATCHED AREA INCLUDES ONLY
THAT REQUIRED TO MAINTAIN EXISTING
FLOOR/CEILING FIRE RATINGS, AS WELL AS
ANY WORK REQUIRED TO ACCOMMODATE
APARTMENT RENOVATION ABOVE (SUCH AS
STAIRWAYS, RATING OF STAIRS SUPPORTING
STRUCTURE, PLUMBING, SPRINKLERS,
ELECTRICAL SYSTEMS, RISERS AND CONDUIT.

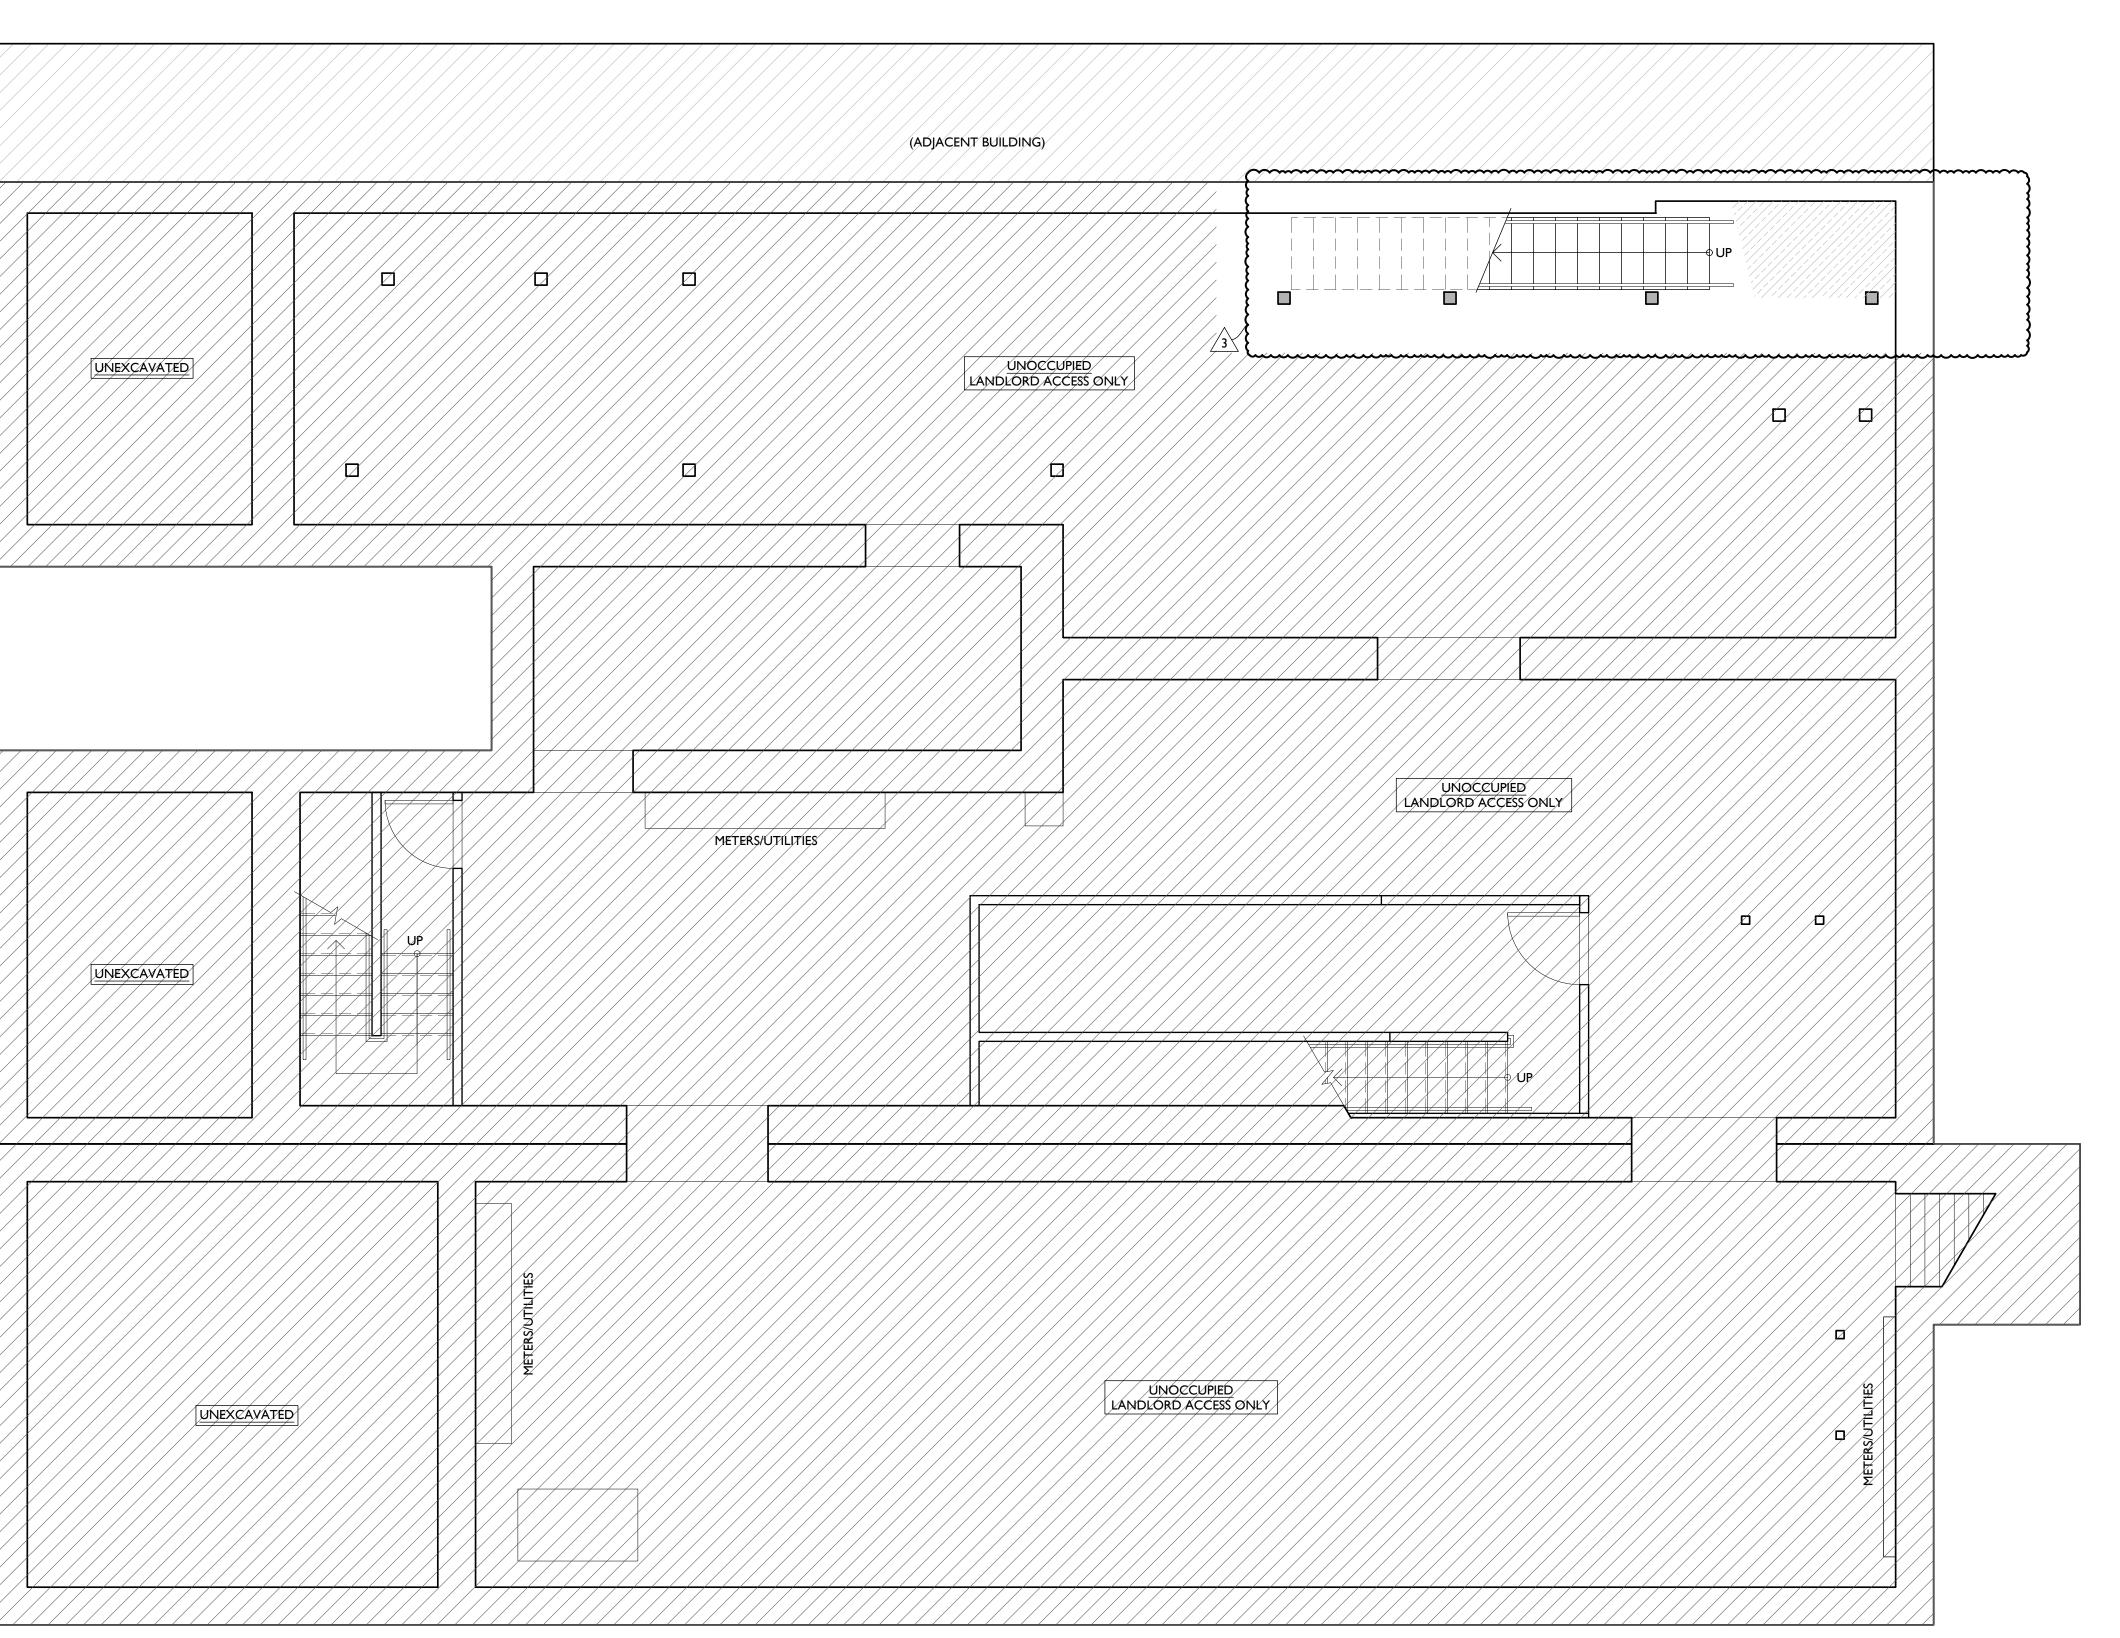

REFLECTED CEILING PLAN FIXTURE LEGEND **FIXTURE** SYMBOL REMARKS SMI - GENERAL LIGHTS. SM2 - DAMP RATED. $igotimes_{ extsf{SM\#}}$ SM3 - ALWAYS ON, TYPICAL IN COMMON CORRIDORS. SM3 MOUNT SM4 LED LIGHT SM5 - FLUSHMOUNT SURFACE MOUNT FIXTURE, TYPICAL SM5 IN FIRST FLOOR STAIRWELLS. SM6 SM6 - DAMP RATED AT EXTERIOR APPLICATIONS VANITY TYP OVER BATHROOM VANITIES- SEE A4.01 FOR LIGHT MOUNTING FI - LARGE FAN CEILING F2 - SMALL FAN F2 LIGHT DIMMABLE, TYP W/ LIGHT KIT SURFACE MOUNTED LINEAR IN STAIRWELLS LED LIGHT (INCLUDE STANDBY POWER FOR EMERGENCY EGRESS) UC CABINET UNDERCABINET LIGHT UC LIGHT TYPICAL SURFACE MOUNTED FIXTURE IN UTILITY AREAS DOWN LIGHTS LIGHT **EXTERIOR** GOOSENECK DOWNLIGHTS ⊕EL2 BATHROOM SEE MECH DWGS EMERGENCY EGRESS EXIT SIGN W/ BATTERY BACKUP AND ES REMOTE CAPABILITY EMERGENCY EGRESS EXIT SIGN W/ BATTERY BACKUP AND ESL EGRESS REMOTE CAPABILITY ESL W/ (2) HEAD EGRESS LIGHTS EGRESS (2) HEAD REMOTE EXTERIOR EMERGENCY EGRESS LIGHT RHI (2) HEAD EMERGENCY EGRESS LIGHT - W/ BATTERY EGRESS BACKUP AND REMOTE CAPABILITY ... EXTERIOR-RATED REFLECTED CEILING PLAN GRAPHIC KEY: CH: 8'-0" CEILING HEIGHT TAG (TYP 8'-0" U.N.O.) SOFFIT/LOWERED GYP BD CEILING AREA OF ATYPICAL FIRE-RATING. SEE PLANS + A0.01 DENOTES NIGHT LIGHT FIXTURE (NL) DENOTES OCCUPANCY SENSOR COMBO SMOKE/CARBON MONOXIDE DETECTOR: IONIZATION (TYP BEDROOMS) D - - PHOTOELECTRIC ____ CENTER ON ARCHITECTURAL FEATURE SUSPENDED LIGHT FIXTURE ---S SPRINKLER HEAD RECOMMENDED LOCATIONS FOR ARCHITECTURAL DESIGN. FIRE SPRINKLER CONTRACTOR TO PROVIDE ENGINEERED DOCUMENTS WALL MOUNTED SPRINKLER HEAD RECOMMENDED LOCATIONS FOR ARCHITECTURAL DESIGN. FIRE SPRINKLER CONTRACTOR TO PROVIDE ENGINEERED

REFLECTED CEILING PLAN GENERAL NOTES:

OF WINDOW. FIRE SPRINKLER CONTRACTOR TO

- A. <u>NOTE:</u> THIS IS A HISTORIC TAX CREDIT PROJECT. ALL WORK MUST COMPLY W/ APPROVED. PART 2, INCLUDING AMENDMENTS. NO HISTORIC ELEMENTS SHALL BE REMOVED/MODIFIED UNLESS SPECIFICALLY INDICATED IN ARCH DWGS.
- B. IF A FIXTURE APPEARS TO BE CENTERED IN A SPACE, THEN CENTER IT. C. LOWERED CEILINGS AND SOFFITS SHALL BE 8'-0" HIGH A.F.F., U.N.O.

WC WATER CURTAIN HEAD TO PROVIDE 100% COVERAGE

PROVIDE ENGINEERED DOCUMENTS

DOCUMENTS

- D. CLG HTS AT EXG FLOORS ARE TO BE VI.F.
- E. ALL CEILING FINISHES IN OCCUPIED SPACES TO BE SMOOTH PAINTED DRYWALL U.N.O. SEE FINISH SCHEDULE FOR PAINT COLORS.
- F. BASEMENTS & UNOCCUPIED ATTICS TO HAVE EXPOSED JOISTS NO FINISH CLGS U.N.O.
- U.N.O.
 G. ALL SOFFITS OVER KITCHEN CABINETS TO BE 8'-0" AFF AND 2'-0" WIDE (ALIGNING
- WITH FRONT EDGE OF LOWER CABINETS).
 H. PROVIDE UNDER-CABINET LIGHTING BENEATH ALL UPPER KITCHEN CABINETS IN
- H. PROVIDE UNDER-CABINET LIGHTING BENEATH ALL UPPER KITCHEN CABINETS IN RESIDENTAL UNITS. SEE ELEC DWGS.
- SEE EXTERIOR ELEVATIONS FOR MOUNTING HEIGHTS OF EXTERIOR LIGHTS.
 SEE ELECTRICAL DRAWINGS FOR FIXTURE SPECIFICATIONS.

RENOVATION FOR:

| | 6 | W. EL

Progress Dates

08.15.2022 - BID SET

05.26.2022 - PERMIT REV I 06.15.2022 - PERMIT REV 2 08.19.2023 - ENG CHANGE I

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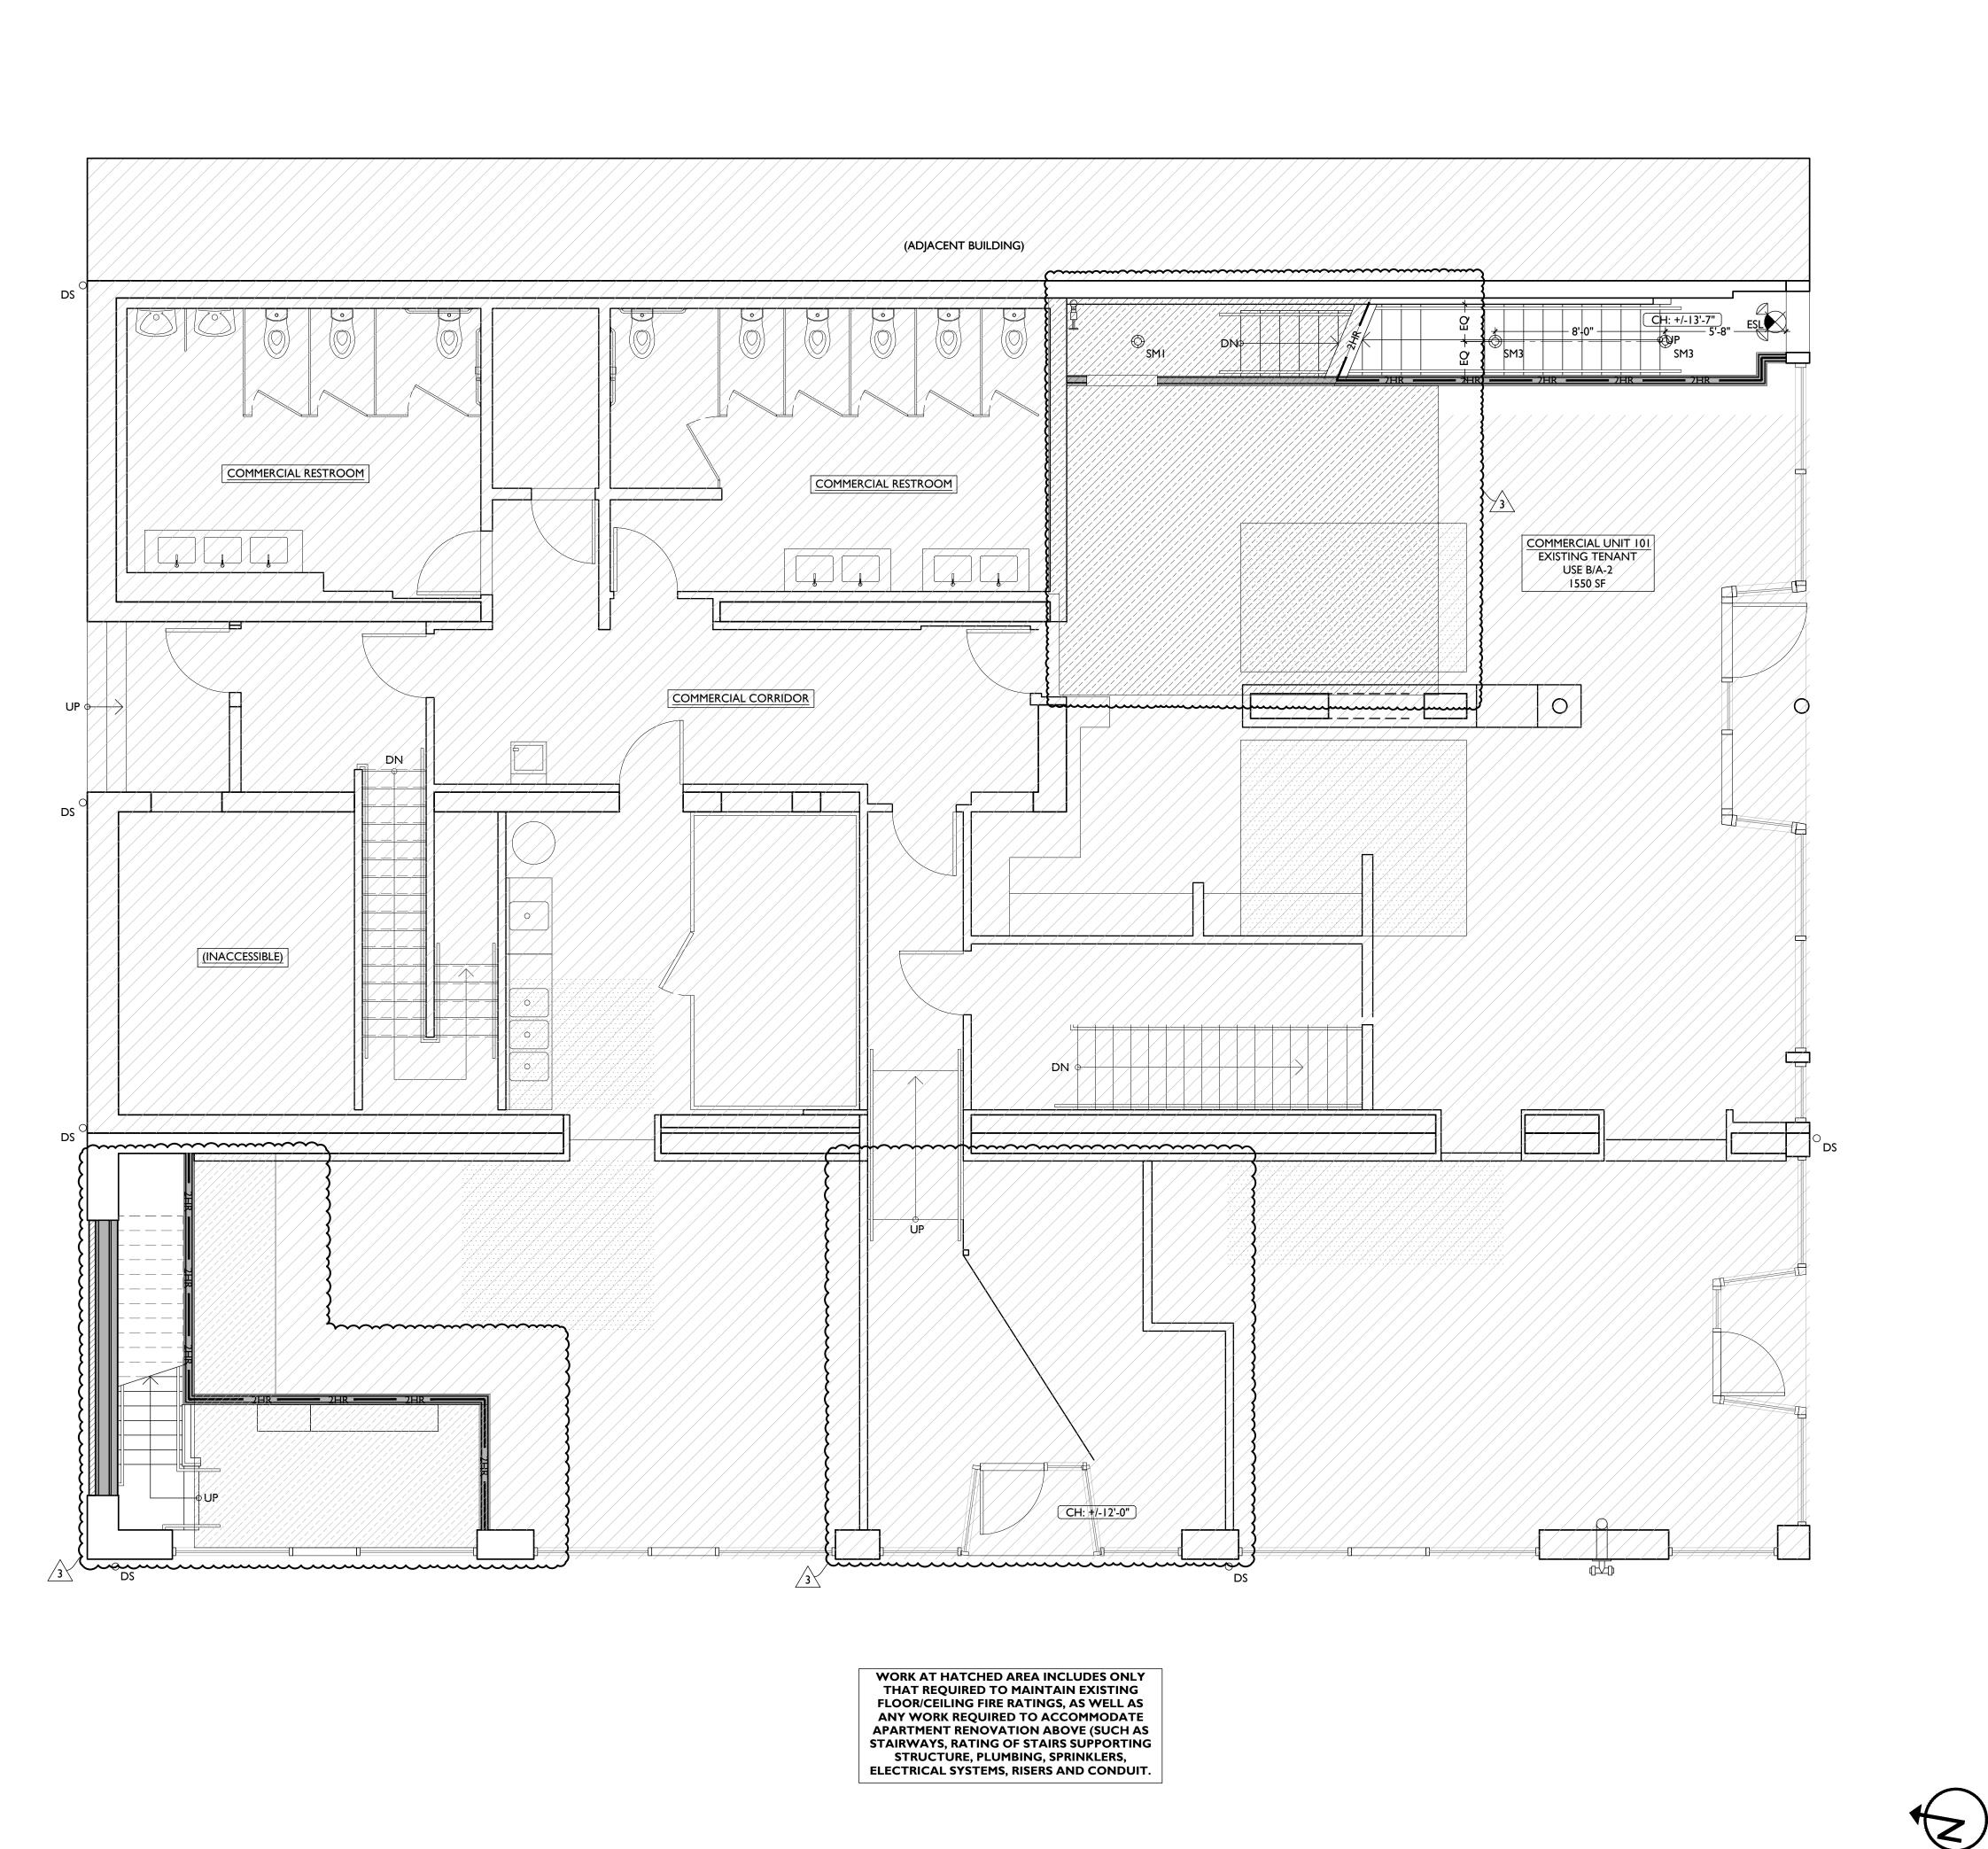
TB, MR

Job No: 22005 02.25.2022

A1.20

REFLECTED CEILING PLAN - BASEMENT

SCALE: 1/4" = 1'-0"



REFLECTED CEILING PLAN FIXTURE LEGEND							
SYMBOL	TAG	FIXTURE TYPE	REMARKS				
⊕ _{SM#}	SM1 SM2 SM3 SM4 SM5 SM6	SURFACE MOUNT LED LIGHT	SMI - GENERAL LIGHTS. SM2 - DAMP RATED. SM3 - ALWAYS ON, TYPICAL IN COMMON CORRIDORS. SM4 - NOT USED SM5 - FLUSHMOUNT SURFACE MOUNT FIXTURE, TYPICAL IN FIRST FLOOR STAIRWELLS. SM6 - DAMP RATED AT EXTERIOR APPLICATIONS				
VI	VI	VANITY LIGHT	TYP OVER BATHROOM VANITIES- SEE A4.01 FOR MOUNTING				
F	FI F2	CEILING FAN W/ LIGHT	FI - LARGE FAN F2 - SMALL FAN DIMMABLE, TYP W/ LIGHT KIT				
L1	LI	LED LIGHT	SURFACE MOUNTED LINEAR IN STAIRWELLS (INCLUDE STANDBY POWER FOR EMERGENCY EGRESS)				
UC	UC	UNDER- CABINET LIGHT	UNDERCABINET LIGHT				
STI (o)	STI	LED STRIP LIGHT	TYPICAL SURFACE MOUNTED FIXTURE IN UTILITY AREAS				
<u>/////////////////////////////////////</u>	ELI	EXTERIOR LIGHT	DOWN LIGHTS				
	EL2	EXTERIOR LIGHT	GOOSENECK DOWNLIGHTS				
(S) EF	EF	BATHROOM VENT	SEE MECH DWGS				
ES	ES	EGRESS	EMERGENCY EGRESS EXIT SIGN W/ BATTERY BACKUP AND REMOTE CAPABILITY				
ESL	ESL	EGRESS	EMERGENCY EGRESS EXIT SIGN W/ BATTERY BACKUP AND REMOTE CAPABILITY W/ (2) HEAD EGRESS LIGHTS				
RHI	RHI	EGRESS	(2) HEAD REMOTE EXTERIOR EMERGENCY EGRESS LIGHT				
EL	EL ELW	EGRESS	(2) HEAD EMERGENCY EGRESS LIGHT - W/ BATTERY BACKUP AND REMOTE CAPABILITY EXTERIOR-RATED				
		REFLECTED	CEILING PLAN GRAPHIC KEY:				

CH: 8'-0" CEILING HEIGHT TAG (TYP 8'-0" U.N.O.) SOFFIT/LOWERED GYP BD CEILING

AREA OF ATYPICAL FIRE-RATING. SEE PLANS + A0.01

(NL) DENOTES NIGHT LIGHT FIXTURE

DENOTES OCCUPANCY SENSOR

COMBO SMOKE/CARBON MONOXIDE DETECTOR: COMBO SMOKE/CARBON MONOXIDE

ONIZATION (TYP BEDROOMS)

DP - - PHOTOELECTRIC

____ CENTER ON ARCHITECTURAL FEATURE

SUSPENDED LIGHT FIXTURE

SPRINKLER HEAD RECOMMENDED LOCATIONS FOR ARCHITECTURAL DESIGN. FIRE SPRINKLER CONTRACTOR TO PROVIDE ENGINEERED DOCUMENTS


LOCATIONS FOR ARCHITECTURAL DESIGN. FIRE SPRINKLER CONTRACTOR TO PROVIDE ENGINEERED **DOCUMENTS**

WC WATER CURTAIN HEAD TO PROVIDE 100% COVERAGE OF WINDOW. FIRE SPRINKLER CONTRACTOR TO PROVIDE ENGINEERED DOCUMENTS

REFLECTED CEILING PLAN GENERAL NOTES:


WALL MOUNTED SPRINKLER HEAD RECOMMENDED


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- B. IF A FIXTURE APPEARS TO BE CENTERED IN A SPACE, THEN CENTER IT. C. LOWERED CEILINGS AND SOFFITS SHALL BE 8'-0" HIGH A.F.F., U.N.O.
- D. CLG HTS AT EXG FLOORS ARE TO BE VI.F.
- E. ALL CEILING FINISHES IN OCCUPIED SPACES TO BE SMOOTH PAINTED DRYWALL U.N.O.
- F. BASEMENTS & UNOCCUPIED ATTICS TO HAVE EXPOSED JOISTS NO FINISH CLGS
- WITH FRONT EDGE OF LOWER CABINETS).
- RESIDENTAL UNITS. SEE ELEC DWGS.
- J. SEE ELECTRICAL DRAWINGS FOR FIXTURE SPECIFICATIONS.

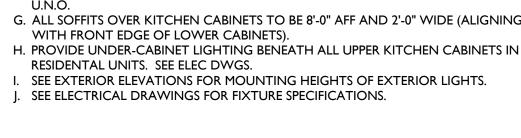



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REFLECTED CEILING PLAN FIXTURE LEGEND

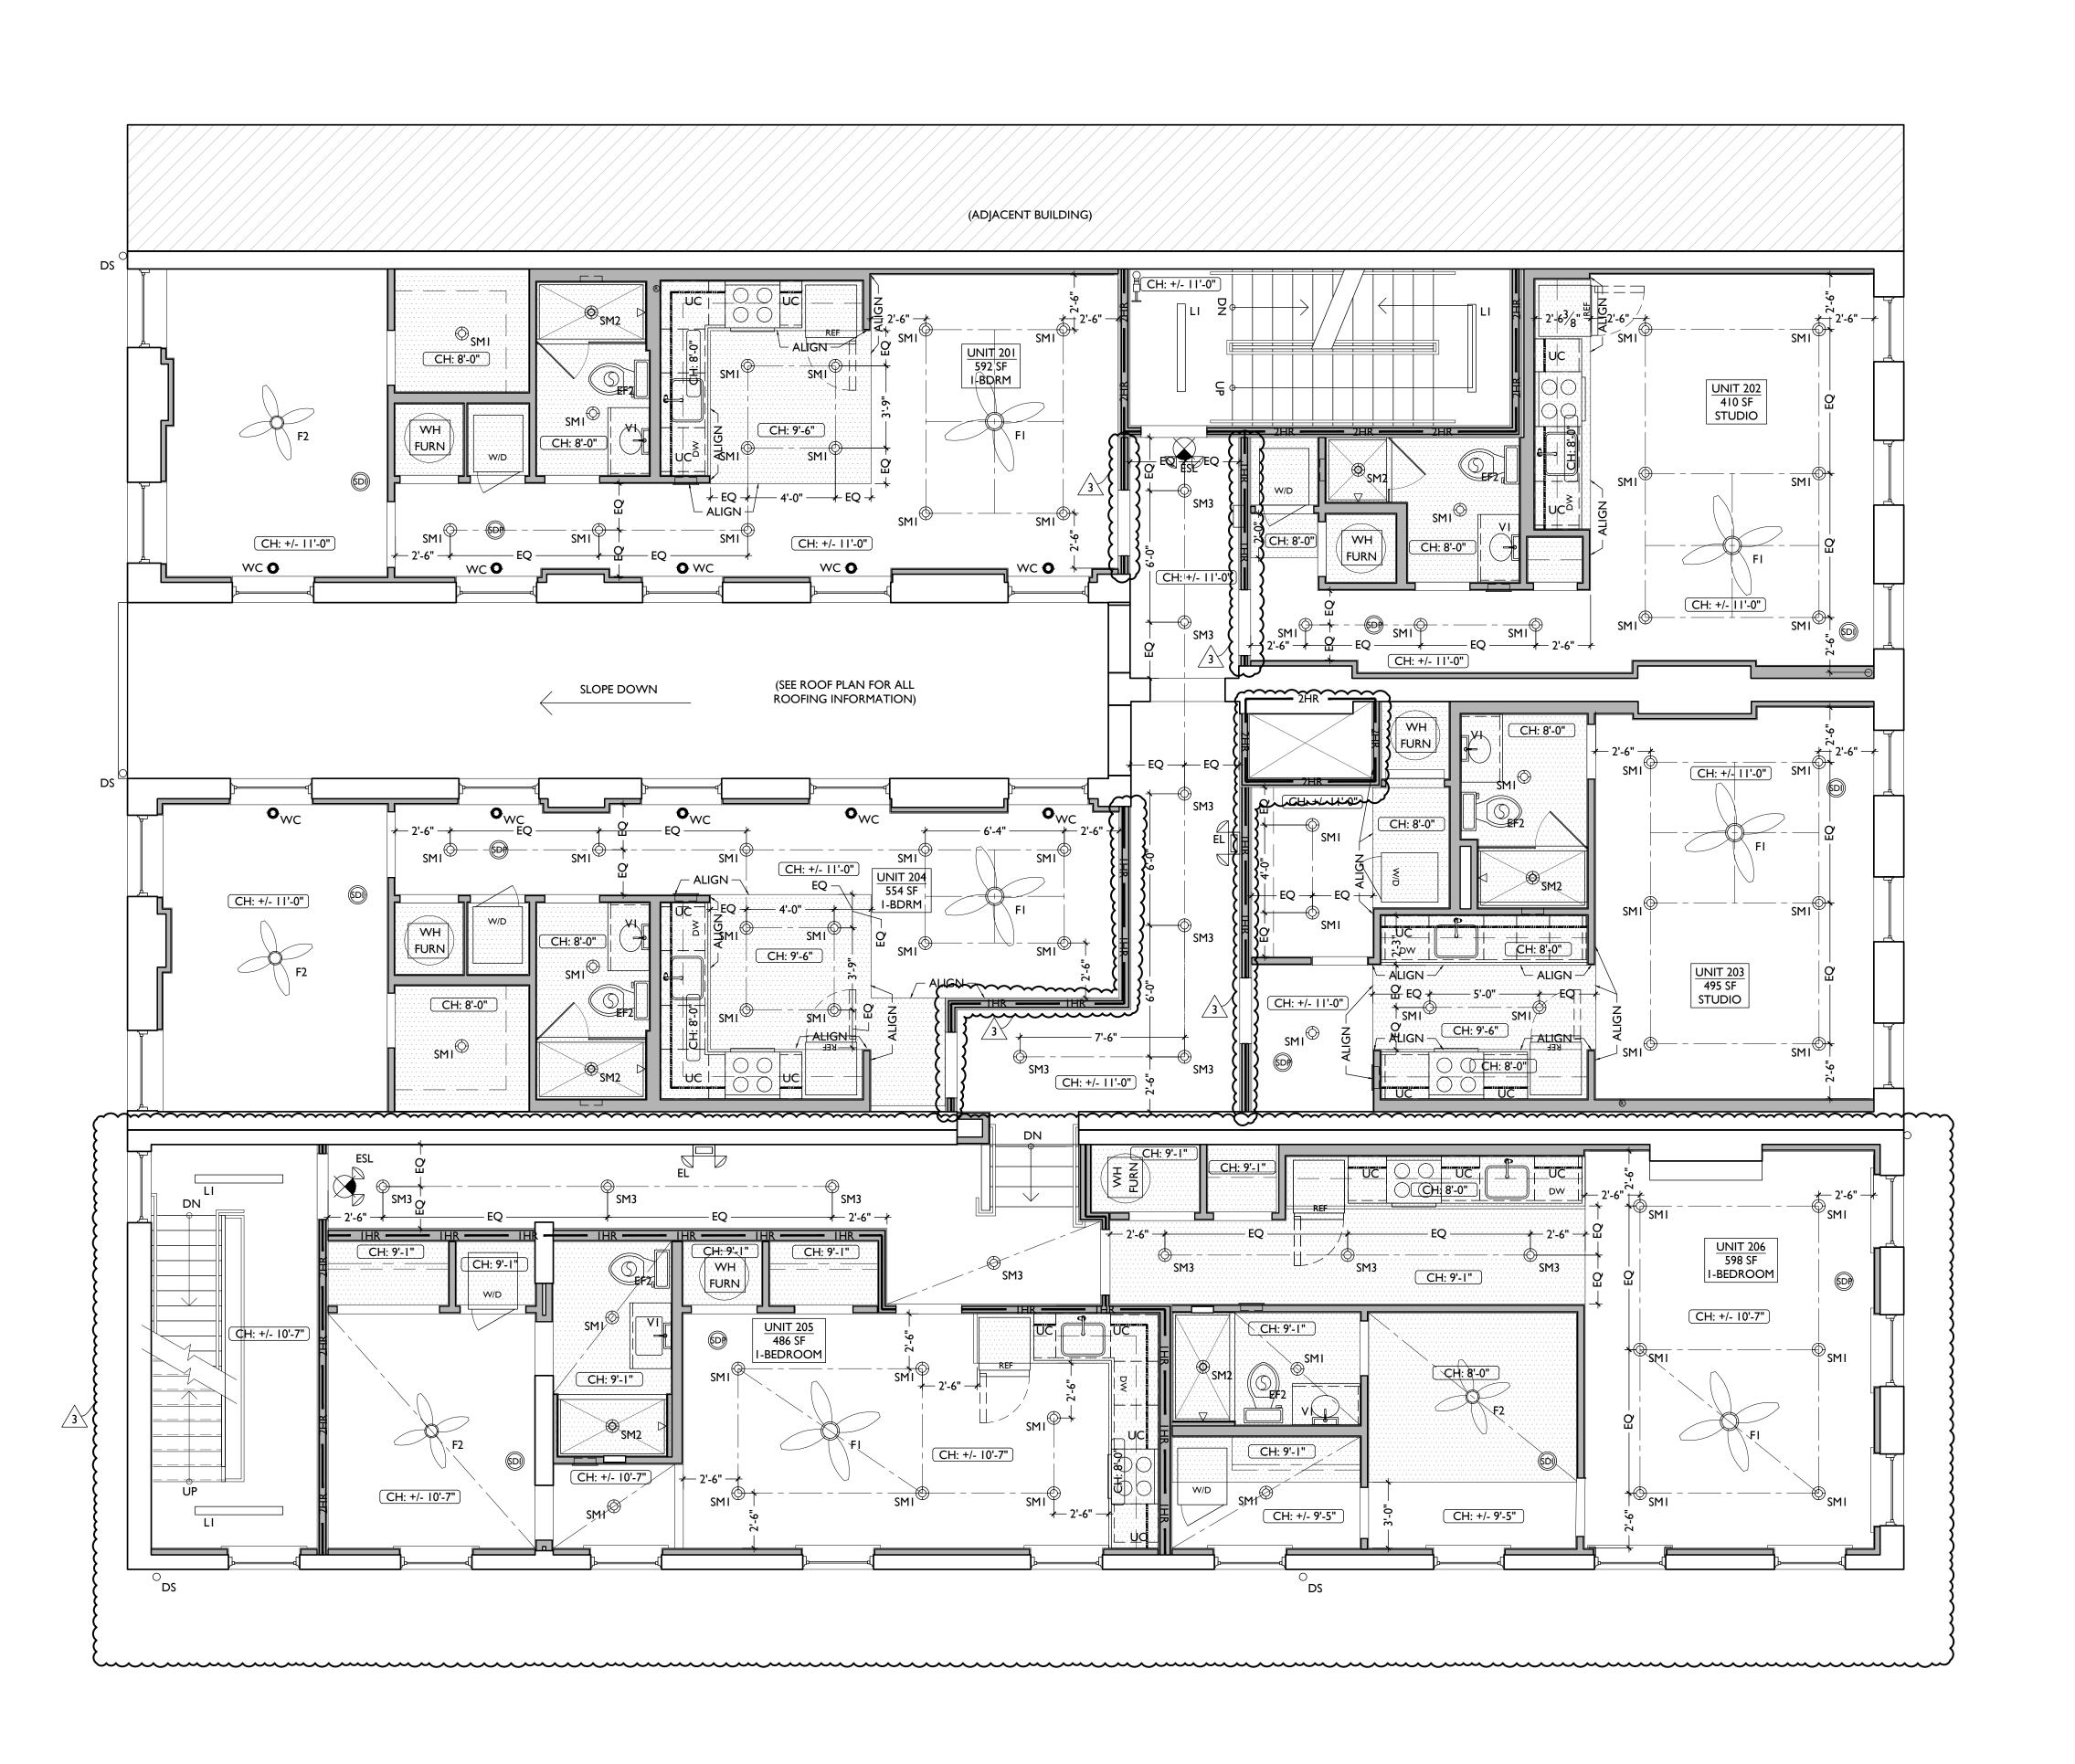SUSPENDED LIGHT FIXTURE

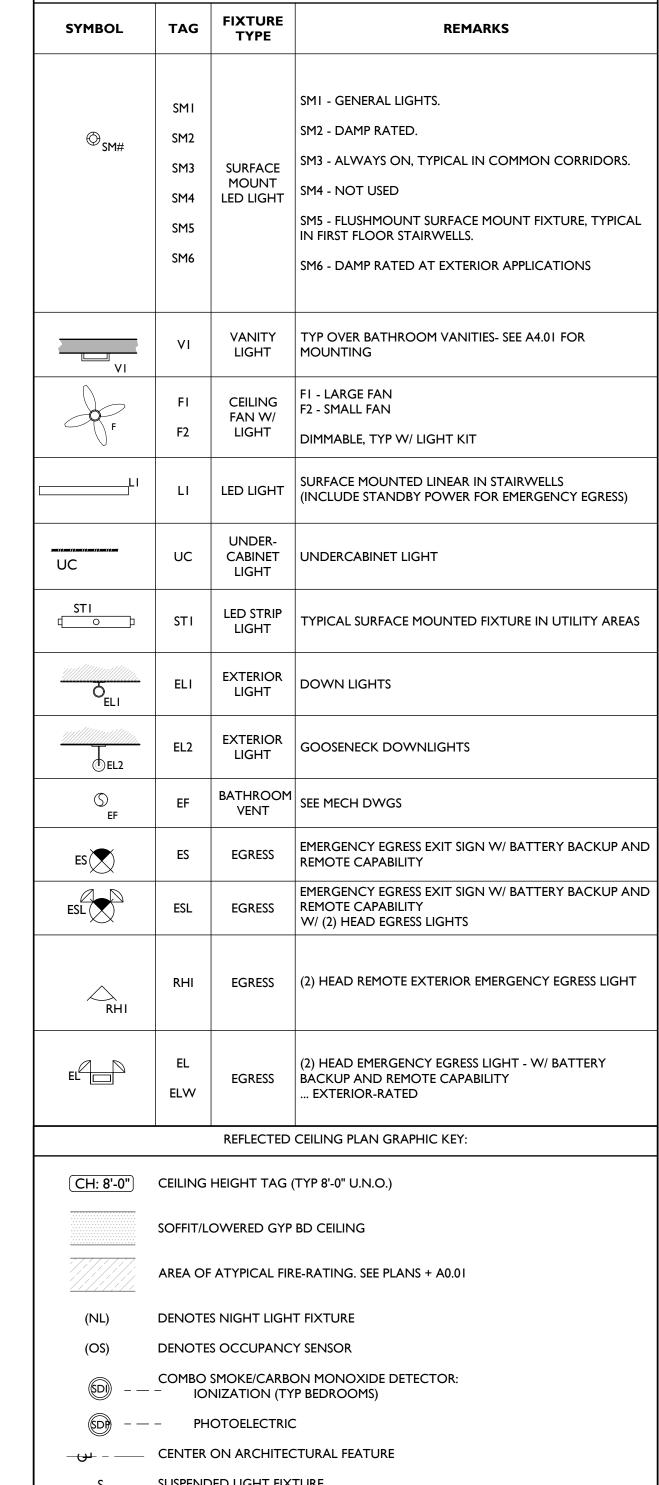SPRINKLER HEAD RECOMMENDED LOCATIONS FOR ARCHITECTURAL DESIGN. FIRE SPRINKLER CONTRACTOR TO PROVIDE ENGINEERED DOCUMENTS

LOCATIONS FOR ARCHITECTURAL DESIGN. FIRE SPRINKLER CONTRACTOR TO PROVIDE ENGINEERED DOCUMENTS

WATER CURTAIN HEAD TO PROVIDE 100% COVERAGE OF WINDOW. FIRE SPRINKLER CONTRACTOR TO PROVIDE ENGINEERED DOCUMENTS

REFLECTED CEILING PLAN GENERAL NOTES:

WALL MOUNTED SPRINKLER HEAD RECOMMENDED


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- I. SEE EXTERIOR ELEVATIONS FOR MOUNTING HEIGHTS OF EXTERIOR LIGHTS.
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MR, TB, SO, MR Drawn by: TB, MR



SYMBOL	TAG	FIXTURE TYPE	REMARKS
[©] sm#	SM1 SM2 SM3 SM4 SM5 SM6	SURFACE MOUNT LED LIGHT	SMI - GENERAL LIGHTS. SM2 - DAMP RATED. SM3 - ALWAYS ON, TYPICAL IN COMMON CORRIDORS SM4 - NOT USED SM5 - FLUSHMOUNT SURFACE MOUNT FIXTURE, TYPICATIN FIRST FLOOR STAIRWELLS. SM6 - DAMP RATED AT EXTERIOR APPLICATIONS
VI	VI	VANITY LIGHT	TYP OVER BATHROOM VANITIES- SEE A4.01 FOR MOUNTING
F	FI F2	CEILING FAN W/ LIGHT	FI - LARGE FAN F2 - SMALL FAN DIMMABLE, TYP W/ LIGHT KIT
L1	LI	LED LIGHT	SURFACE MOUNTED LINEAR IN STAIRWELLS (INCLUDE STANDBY POWER FOR EMERGENCY EGRESS)
UC	UC	UNDER- CABINET LIGHT	UNDERCABINET LIGHT
STI (o)	STI	LED STRIP LIGHT	TYPICAL SURFACE MOUNTED FIXTURE IN UTILITY AREA
Ö _{ELI}	ELI	EXTERIOR LIGHT	DOWN LIGHTS
	EL2	EXTERIOR LIGHT	GOOSENECK DOWNLIGHTS
(S) EF	EF	BATHROOM VENT	SEE MECH DWGS
ES	ES	EGRESS	EMERGENCY EGRESS EXIT SIGN W/ BATTERY BACKUP A REMOTE CAPABILITY
ESL	ESL	EGRESS	EMERGENCY EGRESS EXIT SIGN W/ BATTERY BACKUP A REMOTE CAPABILITY W/ (2) HEAD EGRESS LIGHTS
RHI	RHI	EGRESS	(2) HEAD REMOTE EXTERIOR EMERGENCY EGRESS LIGH
EL	EL ELW	EGRESS	(2) HEAD EMERGENCY EGRESS LIGHT - W/ BATTERY BACKUP AND REMOTE CAPABILITY EXTERIOR-RATED

REFLECTED CEILING PLAN FIXTURE LEGEND

CH: 8'-0" CEILING HEIGHT TAG (TYP 8'-0" U.N.O.)

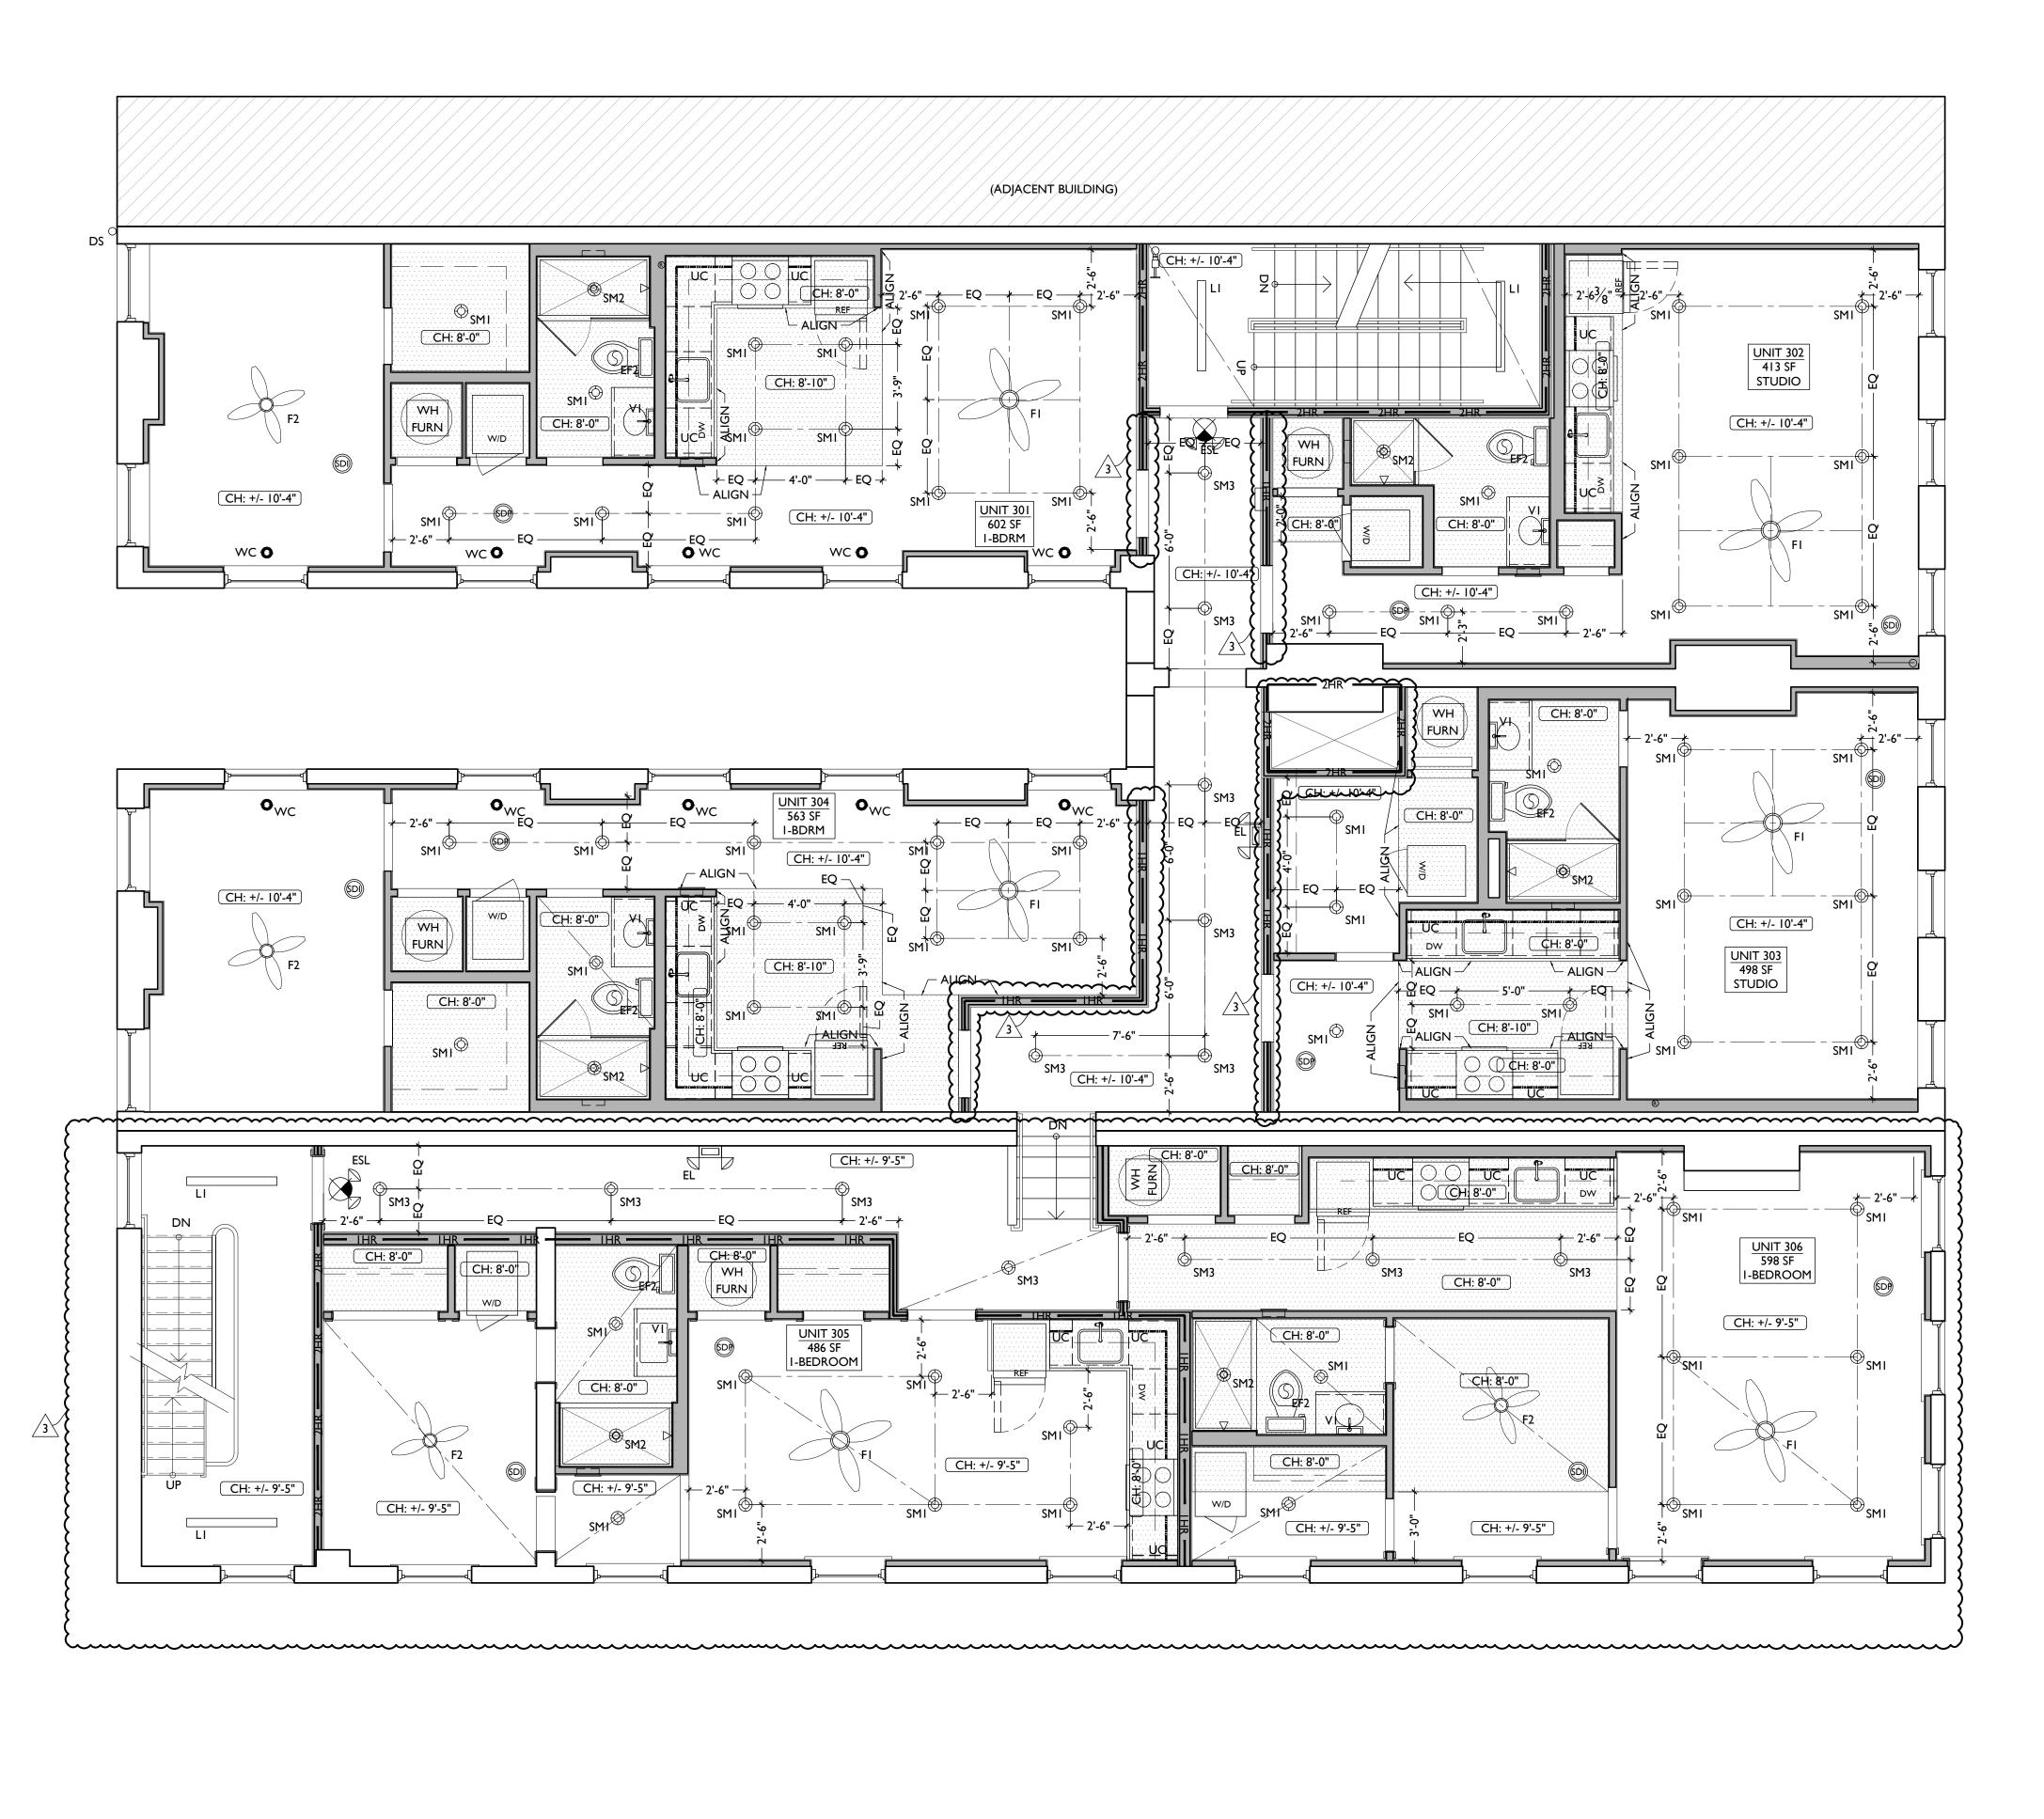SOFFIT/LOWERED GYP BD CEILING

AREA OF ATYPICAL FIRE-RATING. SEE PLANS + A0.01

(NL) DENOTES NIGHT LIGHT FIXTURE

(OS) DENOTES OCCUPANCY SENSOR

COMBO SMOKE/CARBON MONOXIDE DETECTOR:

COMBO SMOKE/CARBON MONOXIDE DE COMBO SMOKE/CARBON MONOXIDE DE

PHOTOELECTRIC

CENTER ON ARCHITECTURAL FEATURE

S SUSPENDED LIGHT FIXTURE

SPRINKLER HEAD RECOMMENDED LOCATIONS FOR ARCHITECTURAL DESIGN. FIRE SPRINKLER CONTRACTOR TO PROVIDE ENGINEERED DOCUMENTS

WALL MOUNTED SPRINKLER HEAD RECOMMENDED LOCATIONS FOR ARCHITECTURAL DESIGN. FIRE SPRINKLER CONTRACTOR TO PROVIDE ENGINEERED DOCUMENTS

WATER CURTAIN HEAD TO PROVIDE 100% COVERAGE OF WINDOW. FIRE SPRINKLER CONTRACTOR TO PROVIDE ENGINEERED DOCUMENTS

REFLECTED CEILING PLAN GENERAL NOTES:


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- E. ALL CEILING FINISHES IN OCCUPIED SPACES TO BE SMOOTH PAINTED DRYWALL U.N.O. SEE FINISH SCHEDULE FOR PAINT COLORS.
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 I. SEE EXTERIOR ELEVATIONS FOR MOUNTING HEIGHTS OF EXTERIOR LIGHTS.



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Design Team: MR, TB, SO, MR


Drawn by: TB, MR

V. ELDER STREET

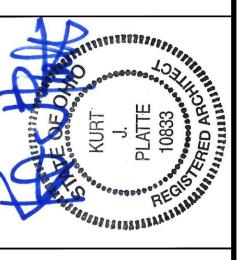RENOV.

Job No: 22005 02.25.2022

A1.23

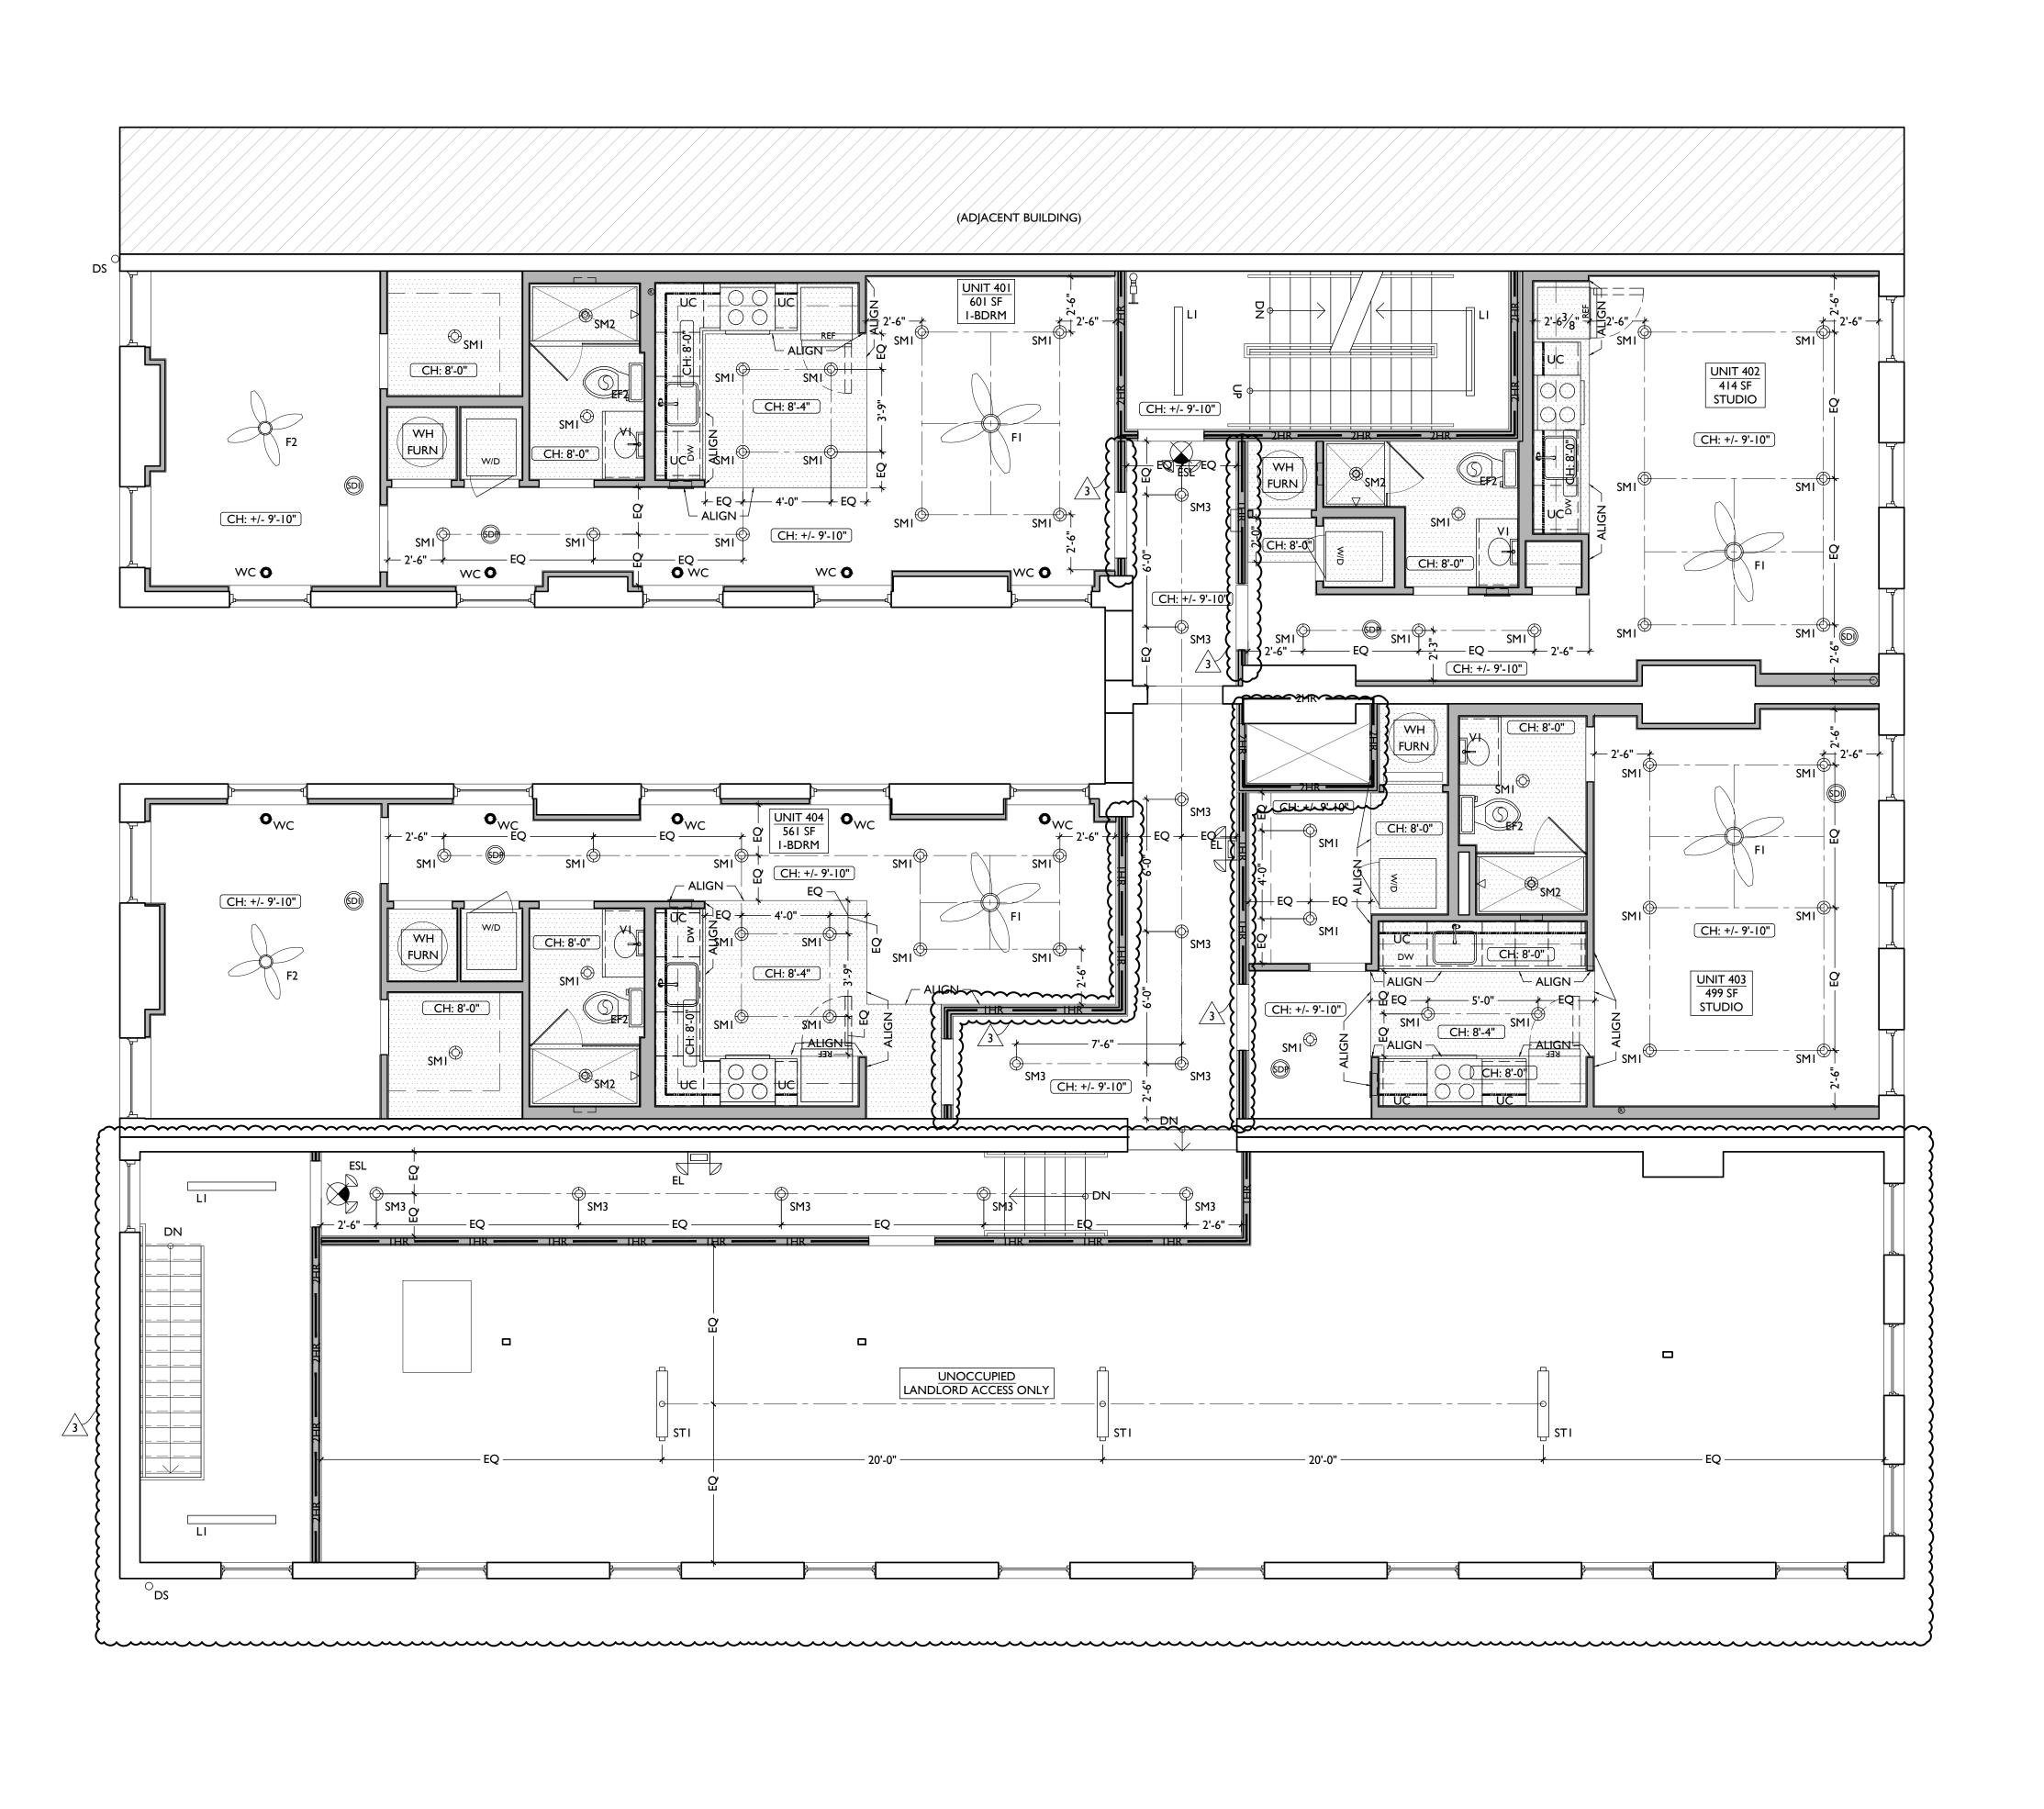

SYMBOL	TAG	FIXTURE TYPE	REMARKS
	SMI		SMI - GENERAL LIGHTS.
\bigcirc	SM2		SM2 - DAMP RATED.
⊕ _{SM#}		CLIDEACE	SM3 - ALWAYS ON, TYPICAL IN COMMON CORRIDORS.
	SM3	SURFACE MOUNT	SM4 - NOT USED
	SM4	LED LIGHT	SM5 - FLUSHMOUNT SURFACE MOUNT FIXTURE, TYPICA
	SM5		IN FIRST FLOOR STAIRWELLS.
	SM6		SM6 - DAMP RATED AT EXTERIOR APPLICATIONS
VI	VI	VANITY LIGHT	TYP OVER BATHROOM VANITIES- SEE A4.01 FOR MOUNTING
	FI	CEILING	FI - LARGE FAN
F	F2	FAN W/ LIGHT	F2 - SMALL FAN
<u> </u>	'-	2.0111	DIMMABLE, TYP W/ LIGHT KIT
L1	LI	LED LIGHT	SURFACE MOUNTED LINEAR IN STAIRWELLS (INCLUDE STANDBY POWER FOR EMERGENCY EGRESS)
UC	UC	UNDER- CABINET LIGHT	UNDERCABINET LIGHT
STI (0)	STI	LED STRIP LIGHT	TYPICAL SURFACE MOUNTED FIXTURE IN UTILITY AREA
O _{ELI}	ELI	EXTERIOR LIGHT	DOWN LIGHTS
	EL2	EXTERIOR LIGHT	GOOSENECK DOWNLIGHTS
(S) EF	EF	BATHROOM VENT	SEE MECH DWGS
ES	ES	EGRESS	EMERGENCY EGRESS EXIT SIGN W/ BATTERY BACKUP AN REMOTE CAPABILITY
ESL	ESL	EGRESS	EMERGENCY EGRESS EXIT SIGN W/ BATTERY BACKUP AN REMOTE CAPABILITY W/ (2) HEAD EGRESS LIGHTS
RHI	RHI	EGRESS	(2) HEAD REMOTE EXTERIOR EMERGENCY EGRESS LIGHT
EL	EL ELW	EGRESS	(2) HEAD EMERGENCY EGRESS LIGHT - W/ BATTERY BACKUP AND REMOTE CAPABILITY EXTERIOR-RATED
		REFLECTED	CEILING PLAN GRAPHIC KEY:
(CH: 8'-0")	CEILING	HEIGHT TAG (TYP 8'-0" U.N.O.)
		OWERED GYP	
	AREA OF ATYPICAL FIRE-RATING. SEE PLANS + A0.01		
(NL)	DENOTES NIGHT LIGHT FIXTURE		
(OS)	DENOTES OCCUPANCY SENSOR		
	COMBO SMOKE/CARBON MONOXIDE DETECTOR:		
(SDI) — —	- PHOTOELECTRIC		
ــــــs	CENTER ON ARCHITECTURAL FEATURE SUSPENDED LIGHT FIXTURE		
•	SPRINKLER HEAD RECOMMENDED LOCATIONS FOR ARCHITECTURAL DESIGN. FIRE SPRINKLER CONTRACTOR TO PROVIDE ENGINEERED DOCUMENTS		
∇			
<u> </u>	WALL MOUNTED SPRINKLER HEAD RECOMMENDED LOCATIONS FOR ARCHITECTURAL DESIGN. FIRE SPRINKLER CONTRACTOR TO PROVIDE ENGINEERED		

REFLECTED CEILING PLAN FIXTURE LEGEND

REFLECTED CEILING PLAN GENERAL NOTES:

OF WINDOW. FIRE SPRINKLER CONTRACTOR TO

WC WATER CURTAIN HEAD TO PROVIDE 100% COVERAGE

PROVIDE ENGINEERED DOCUMENTS

- A. NOTE: THIS IS A HISTORIC TAX CREDIT PROJECT. ALL WORK MUST COMPLY W/ APPROVED. PART 2, INCLUDING AMENDMENTS. NO HISTORIC ELEMENTS SHALL BE REMOVED/MODIFIED UNLESS SPECIFICALLY INDICATED IN ARCH DWGS.
- B. IF A FIXTURE APPEARS TO BE CENTERED IN A SPACE, THEN CENTER IT. C. LOWERED CEILINGS AND SOFFITS SHALL BE 8'-0" HIGH A.F.F., U.N.O.
- D. CLG HTS AT EXG FLOORS ARE TO BE VI.F.
- E. ALL CEILING FINISHES IN OCCUPIED SPACES TO BE SMOOTH PAINTED DRYWALL U.N.O.
- SEE FINISH SCHEDULE FOR PAINT COLORS. F. BASEMENTS & UNOCCUPIED ATTICS TO HAVE EXPOSED JOISTS - NO FINISH CLGS

DOCUMENTS

- G. ALL SOFFITS OVER KITCHEN CABINETS TO BE 8'-0" AFF AND 2'-0" WIDE (ALIGNING WITH FRONT EDGE OF LOWER CABINETS).
- H. PROVIDE UNDER-CABINET LIGHTING BENEATH ALL UPPER KITCHEN CABINETS IN RESIDENTAL UNITS. SEE ELEC DWGS.
- I. SEE EXTERIOR ELEVATIONS FOR MOUNTING HEIGHTS OF EXTERIOR LIGHTS. J. SEE ELECTRICAL DRAWINGS FOR FIXTURE SPECIFICATIONS.



Job No: 22005 02.25.2022

Progress Dates


08.15.2022 - BID SET

05.26.2022 - PERMIT REV I 06.15.2022 - PERMIT REV 2

MR, TB, SO, MR

Drawn by: TB, MR[´]

08.19.2023 - ENG CHANGE I

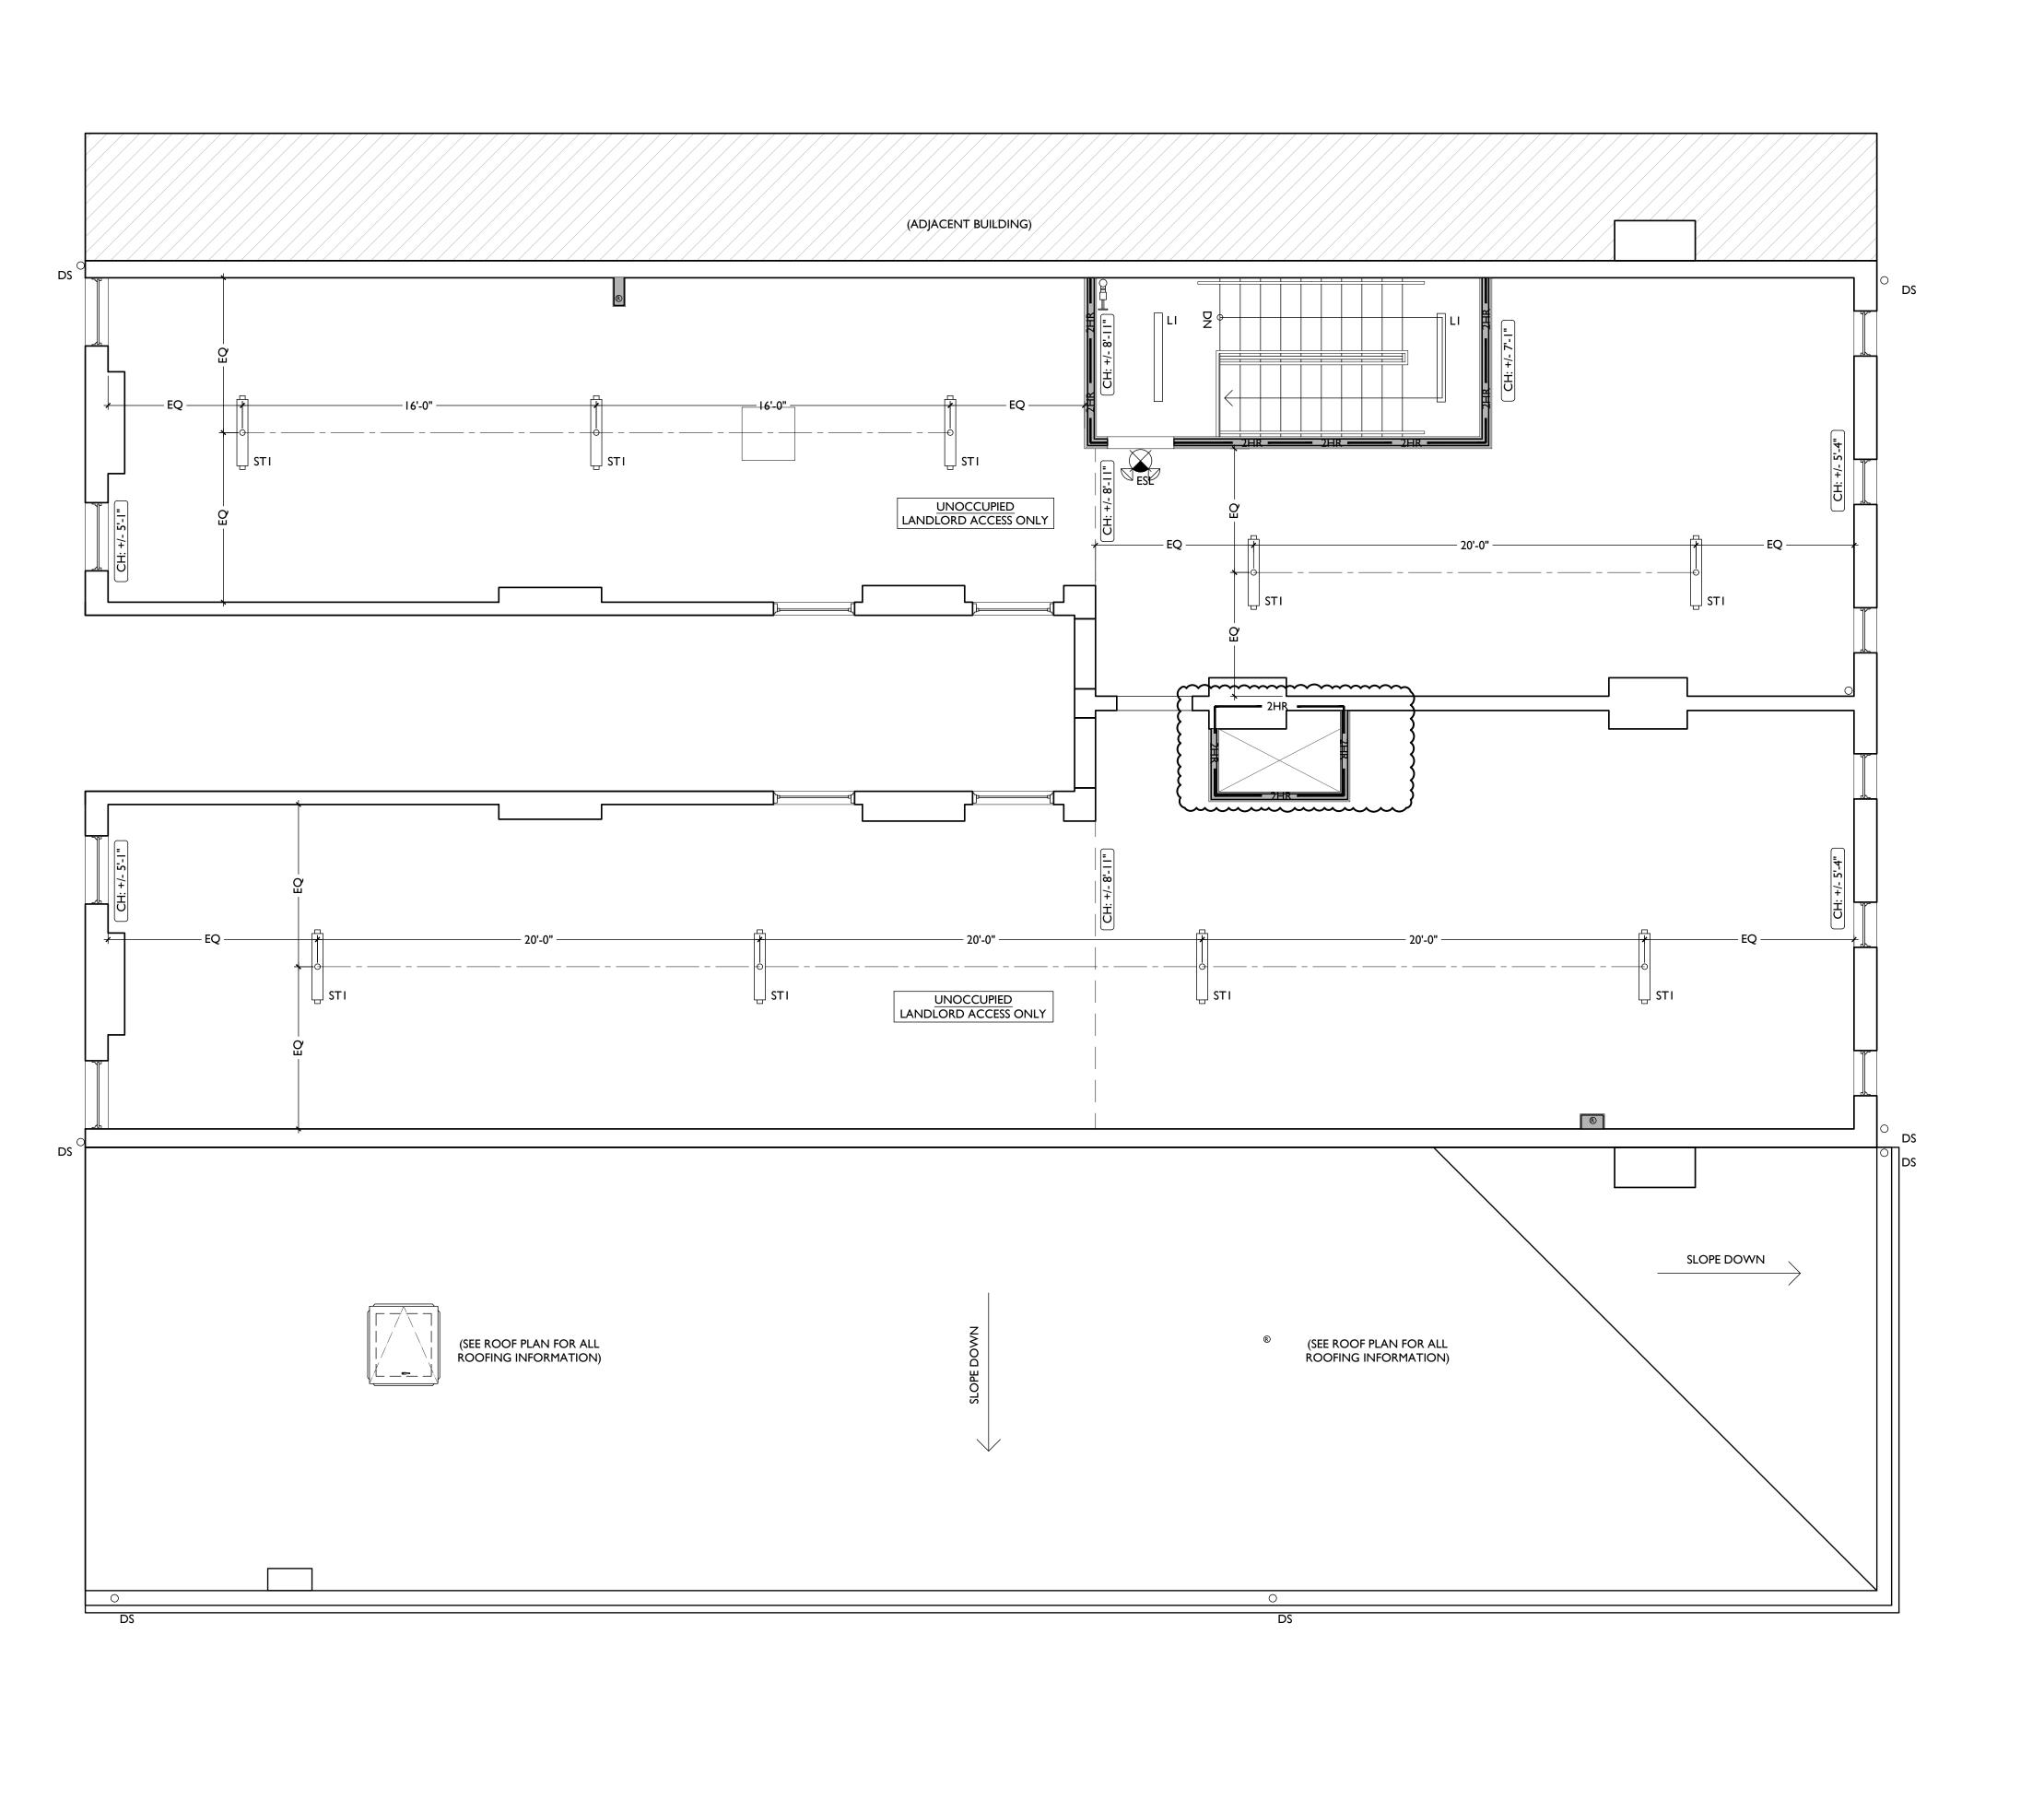

		REFLECTED	CEILING PLAN FIXTURE LEGEND		
SYMBOL	TAG	FIXTURE TYPE	REMARKS		
	SMI		SMI - GENERAL LIGHTS.		
$igotimes_{SM\#}$	SM2		SM2 - DAMP RATED.		
	SM3	SURFACE	SM3 - ALWAYS ON, TYPICAL IN COMMON CORRIDORS.		
	SM4	MOUNT LED LIGHT	SM4 - NOT USED		
	SM5		SM5 - FLUSHMOUNT SURFACE MOUNT FIXTURE, TYPICAL IN FIRST FLOOR STAIRWELLS.		
	SM6		SM6 - DAMP RATED AT EXTERIOR APPLICATIONS		
	VI	VANITY LIGHT	TYP OVER BATHROOM VANITIES- SEE A4.01 FOR MOUNTING		
VI	FI	CEILING	FI - LARGE FAN		
F	F2	FAN W/ LIGHT	F2 - SMALL FAN		
V	'-	2.0111	DIMMABLE, TYP W/ LIGHT KIT		
LI	LI	LED LIGHT	SURFACE MOUNTED LINEAR IN STAIRWELLS (INCLUDE STANDBY POWER FOR EMERGENCY EGRESS)		
UC	UC	UNDER- CABINET LIGHT	UNDERCABINET LIGHT		
STI (O)	STI	LED STRIP LIGHT	TYPICAL SURFACE MOUNTED FIXTURE IN UTILITY AREAS		
<u>//////</u> O _{ELI}	ELI	EXTERIOR LIGHT	DOWN LIGHTS		
	EL2	EXTERIOR LIGHT	GOOSENECK DOWNLIGHTS		
© EF	EF	BATHROOM VENT	SEE MECH DWGS		
ES	ES	EGRESS	EMERGENCY EGRESS EXIT SIGN W/ BATTERY BACKUP AN REMOTE CAPABILITY		
ESL	ESL	EGRESS	EMERGENCY EGRESS EXIT SIGN W/ BATTERY BACKUP AN REMOTE CAPABILITY W/ (2) HEAD EGRESS LIGHTS		
RHI	RHI	EGRESS	(2) HEAD REMOTE EXTERIOR EMERGENCY EGRESS LIGHT		
EL	EL ELW	EGRESS	(2) HEAD EMERGENCY EGRESS LIGHT - W/ BATTERY BACKUP AND REMOTE CAPABILITY EXTERIOR-RATED		
		REFLECTED	CEILING PLAN GRAPHIC KEY:		
CH: 8'-0"	CEILING	HEIGHT TAG ((TYP 8'-0" U.N.O.)		
	SOFFIT/LOWERED GYP BD CEILING AREA OF ATYPICAL FIRE-RATING. SEE PLANS + A0.01 (NL) DENOTES NIGHT LIGHT FIXTURE (OS) DENOTES OCCUPANCY SENSOR COMBO SMOKE/CARBON MONOXIDE DETECTOR: IONIZATION (TYP BEDROOMS) DENOTES OCCUPANCY SENSOR PHOTOELECTRIC				
(NL)					
(OS)					
(D) - —					

REFLECTED CEILING PLAN GENERAL NOTES:

OF WINDOW. FIRE SPRINKLER CONTRACTOR TO

SPRINKLER HEAD RECOMMENDED LOCATIONS FOR ARCHITECTURAL DESIGN. FIRE SPRINKLER
CONTRACTOR TO PROVIDE ENGINEERED DOCUMENTS

SPRINKLER CONTRACTOR TO PROVIDE ENGINEERED

- A. <u>NOTE:</u> THIS IS A HISTORIC TAX CREDIT PROJECT. ALL WORK MUST COMPLY W/ APPROVED. PART 2, INCLUDING AMENDMENTS. NO HISTORIC ELEMENTS SHALL BE REMOVED/MODIFIED UNLESS SPECIFICALLY INDICATED IN ARCH DWGS.
- B. IF A FIXTURE APPEARS TO BE CENTERED IN A SPACE, THEN CENTER IT. C. LOWERED CEILINGS AND SOFFITS SHALL BE 8'-0" HIGH A.F.F., U.N.O.
- D. CLG HTS AT EXG FLOORS ARE TO BE VI.F.
- E. ALL CEILING FINISHES IN OCCUPIED SPACES TO BE SMOOTH PAINTED DRYWALL U.N.O. SEE FINISH SCHEDULE FOR PAINT COLORS.

 F. BASEMENTS & UNOCCUPIED ATTICS TO HAVE EXPOSED JOISTS - NO FINISH CLGS

_____ CENTER ON ARCHITECTURAL FEATURE

DOCUMENTS


SUSPENDED LIGHT FIXTURE

WALL MOUNTED SPRINKLER HEAD RECOMMENDED LOCATIONS FOR ARCHITECTURAL DESIGN. FIRE

WC WATER CURTAIN HEAD TO PROVIDE 100% COVERAGE

PROVIDE ENGINEERED DOCUMENTS

- G. ALL SOFFITS OVER KITCHEN CABINETS TO BE 8'-0" AFF AND 2'-0" WIDE (ALIGNING
- WITH FRONT EDGE OF LOWER CABINETS). H. PROVIDE UNDER-CABINET LIGHTING BENEATH ALL UPPER KITCHEN CABINETS IN
- RESIDENTAL UNITS. SEE ELEC DWGS. I. SEE EXTERIOR ELEVATIONS FOR MOUNTING HEIGHTS OF EXTERIOR LIGHTS.
- J. SEE ELECTRICAL DRAWINGS FOR FIXTURE SPECIFICATIONS.

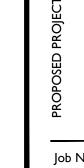

Progress Dates

Design Team: MR, TB, SO, MR

Drawn by: TB, MR

08.15.2022 - BID SET

05.26.2022 - PERMIT REV I 06.15.2022 - PERMIT REV 2 08.19.2023 - ENG CHANGE I




05.26.2022 - PERMIT REV I 06.15.2022 - PERMIT REV 2 08.19.2023 - ENG CHANGE I

MR, TB, SO, MR

Drawn by:

TB, MR

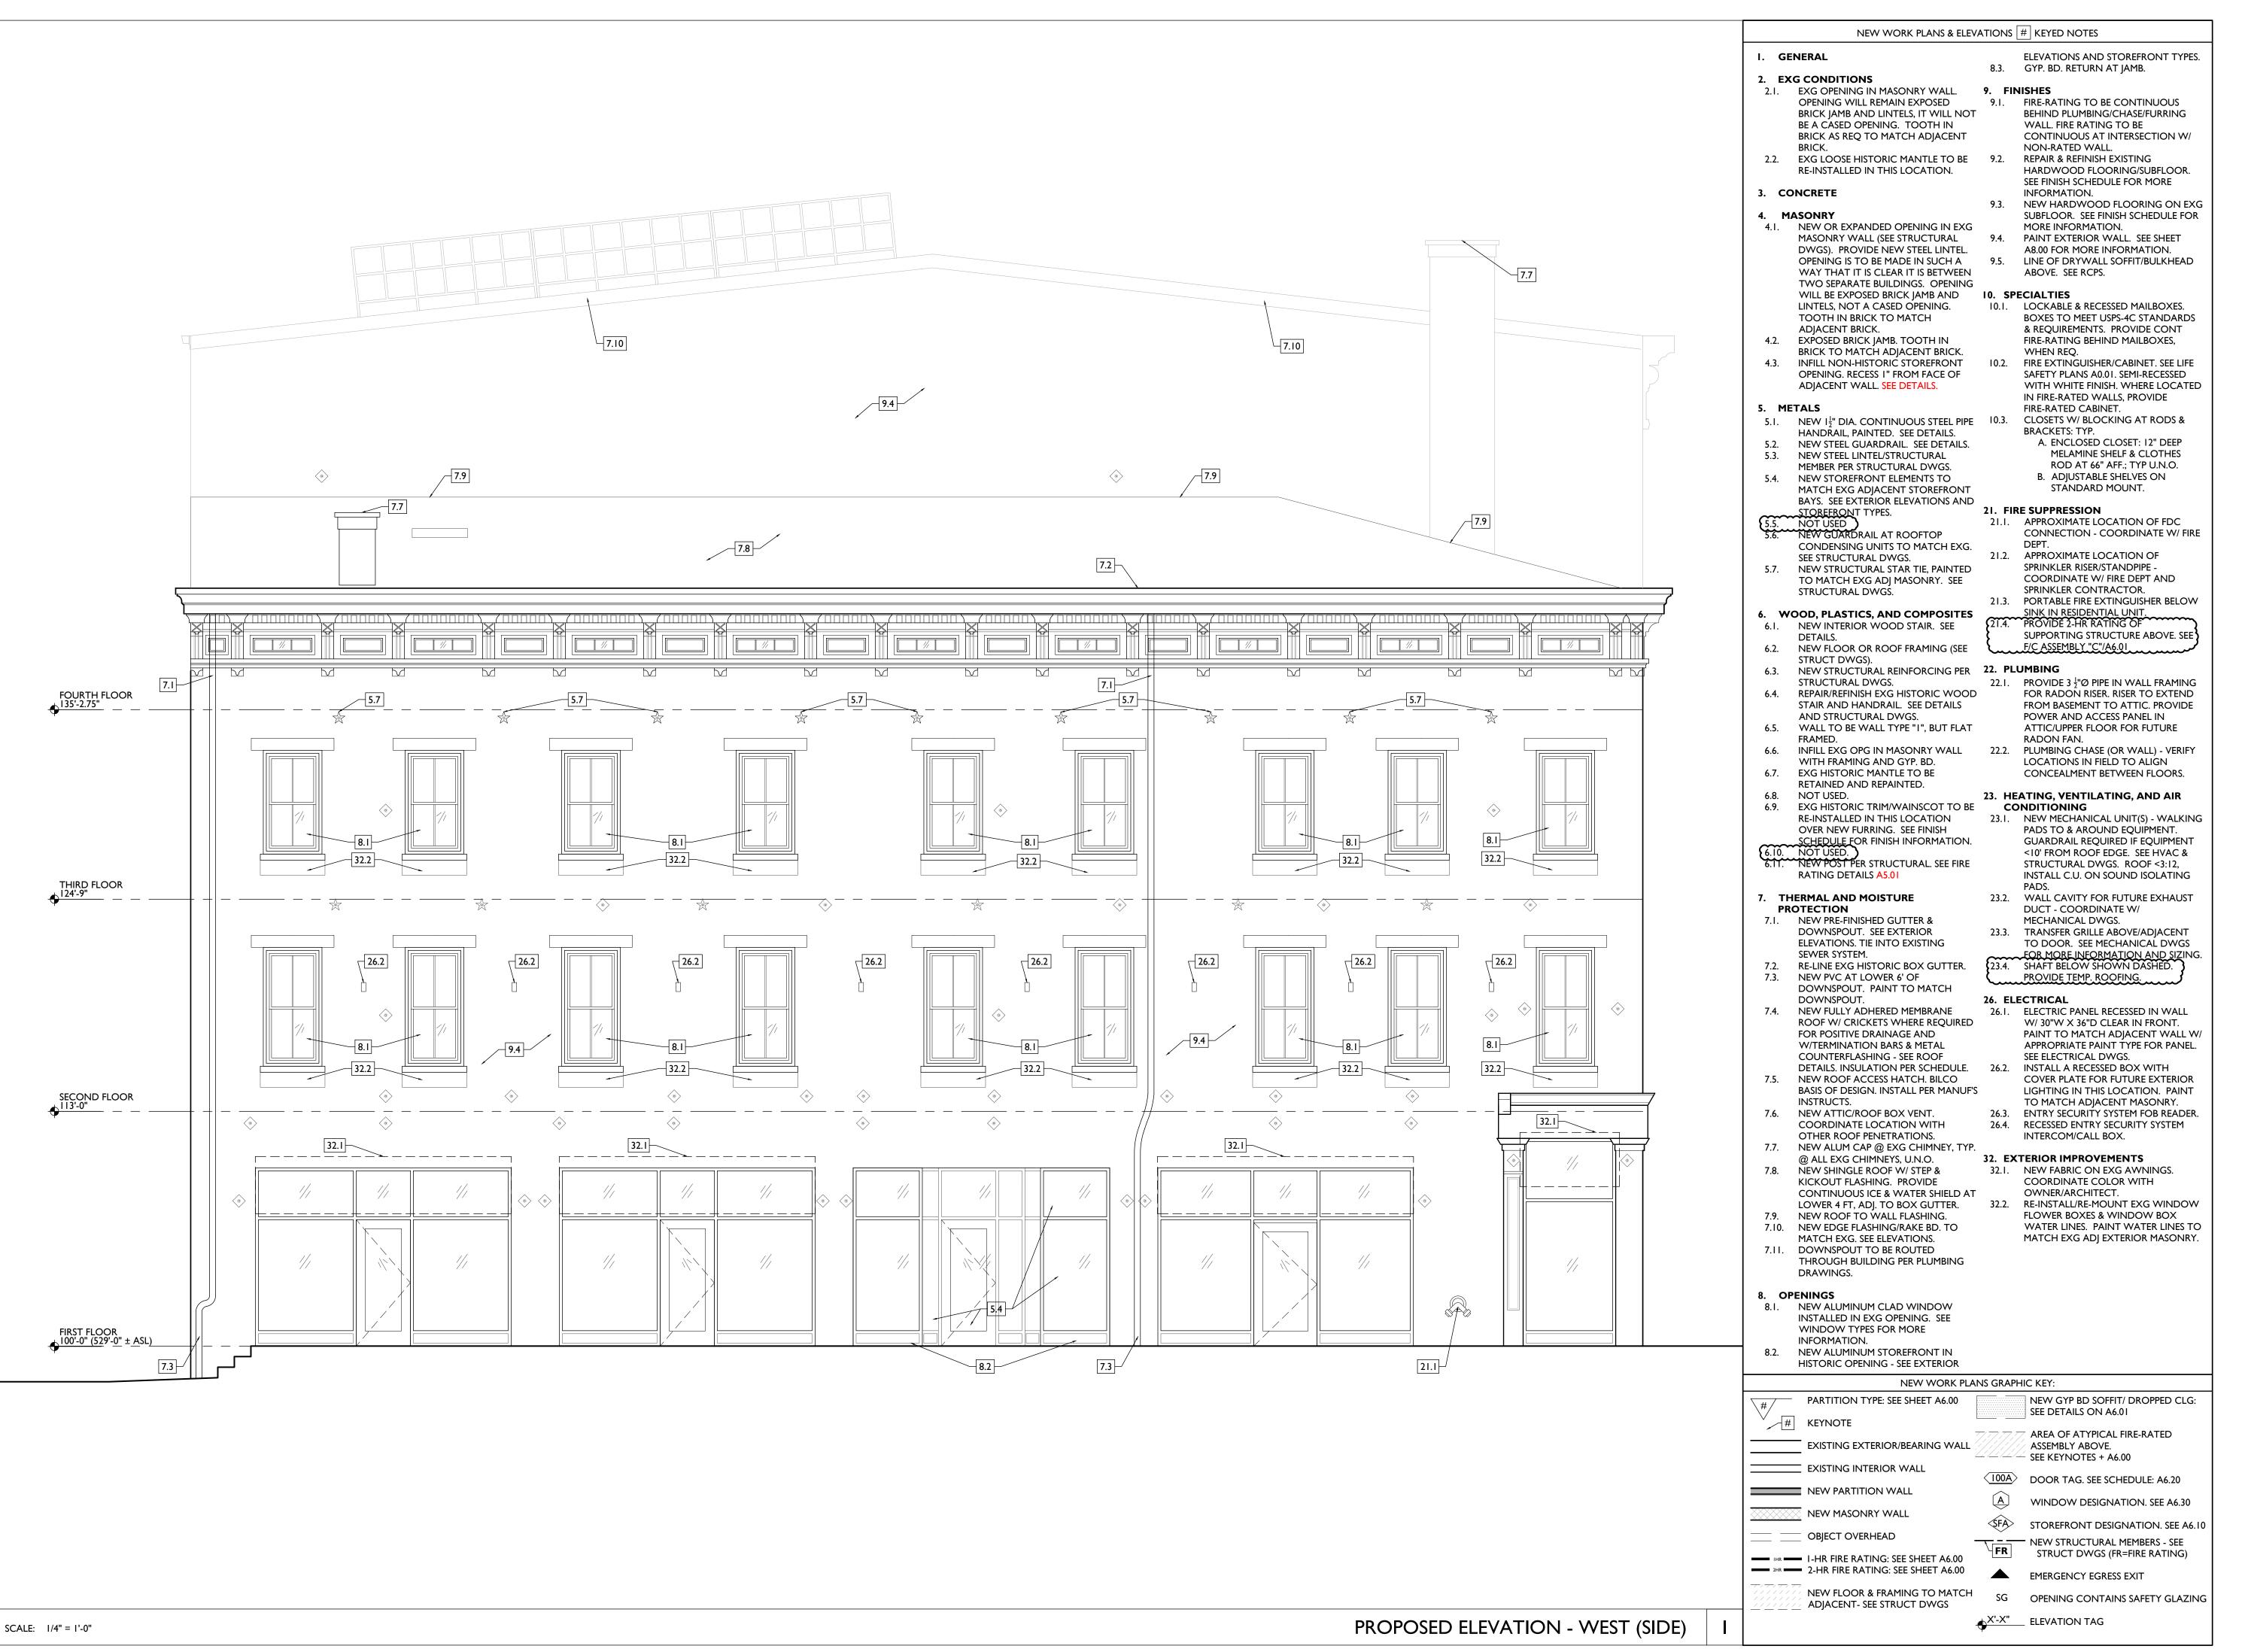


05.26.2022 - PERMIT REV I 06.15.2022 - PERMIT REV 2 08.19.2023 - ENG CHANGE I

MR, TB, SO, MR

Drawn by:

TB, MR

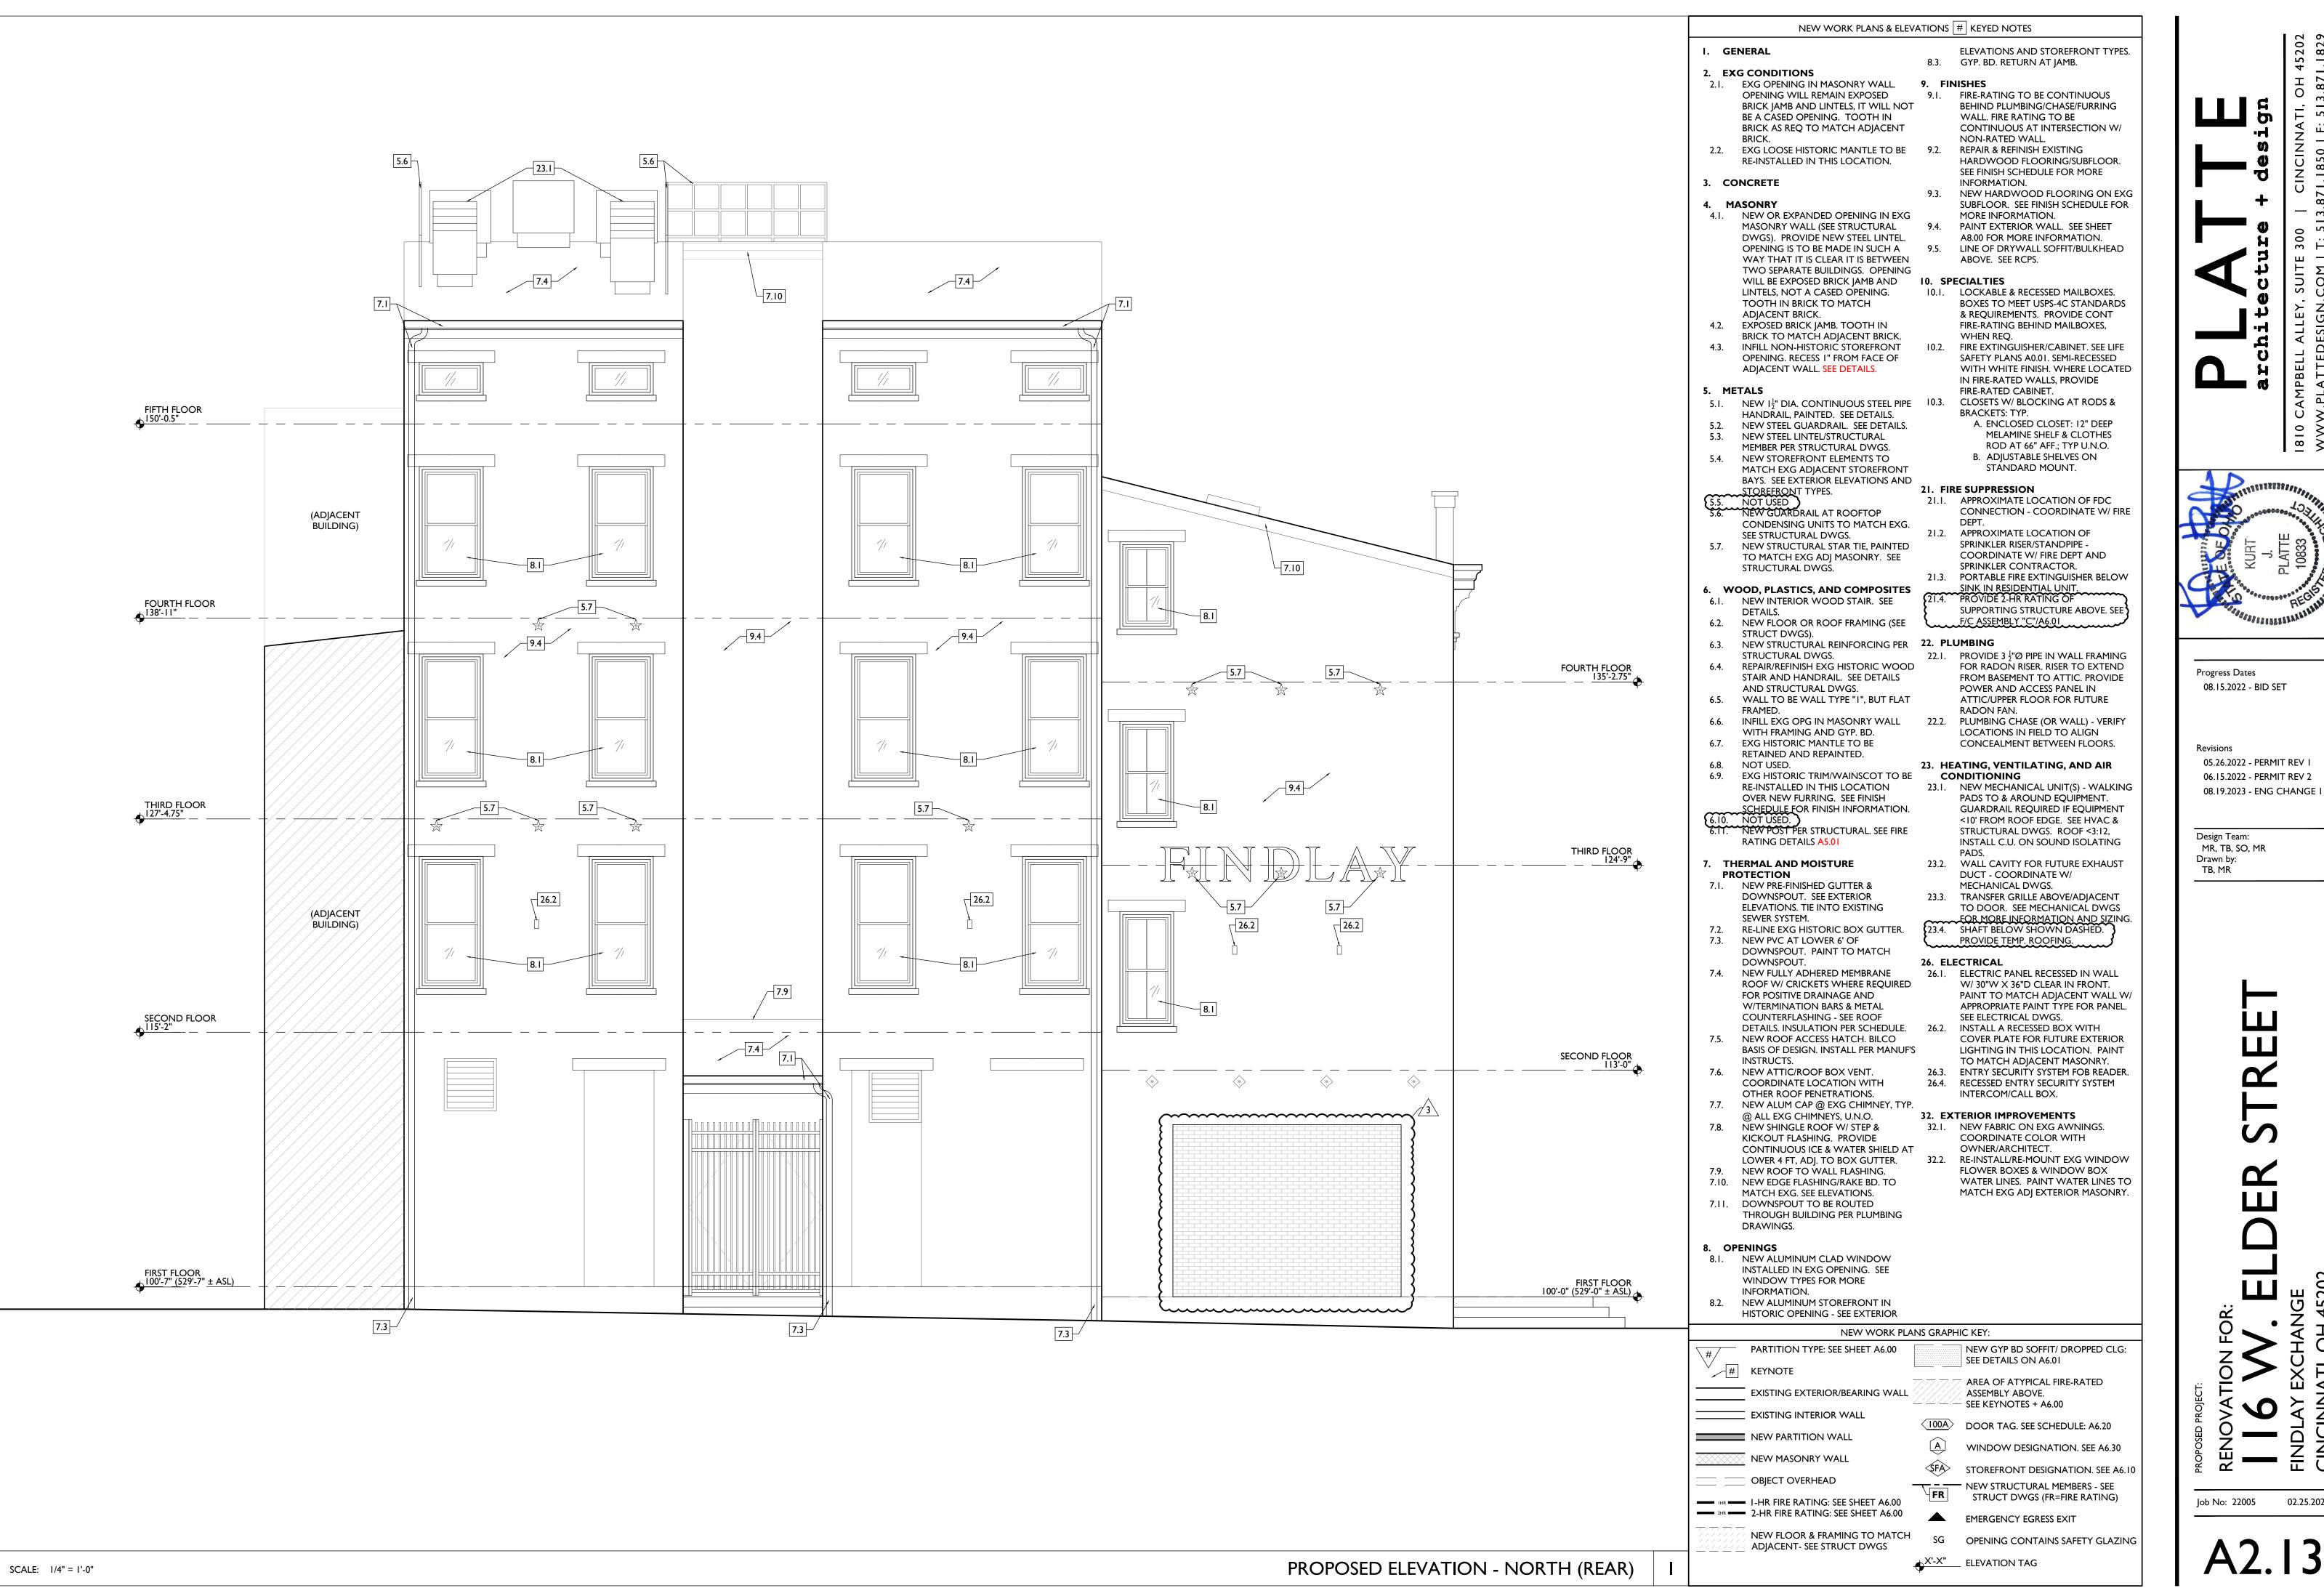

05.26.2022 - PERMIT REV I 06.15.2022 - PERMIT REV 2




Job No: 22005 02.25.2022

Progress Dates 08.15.2022 - BID SET


05.26.2022 - PERMIT REV I 06.15.2022 - PERMIT REV 2 08.19.2023 - ENG CHANGE I

MR, TB, SO, MR Drawn by: TB, MR

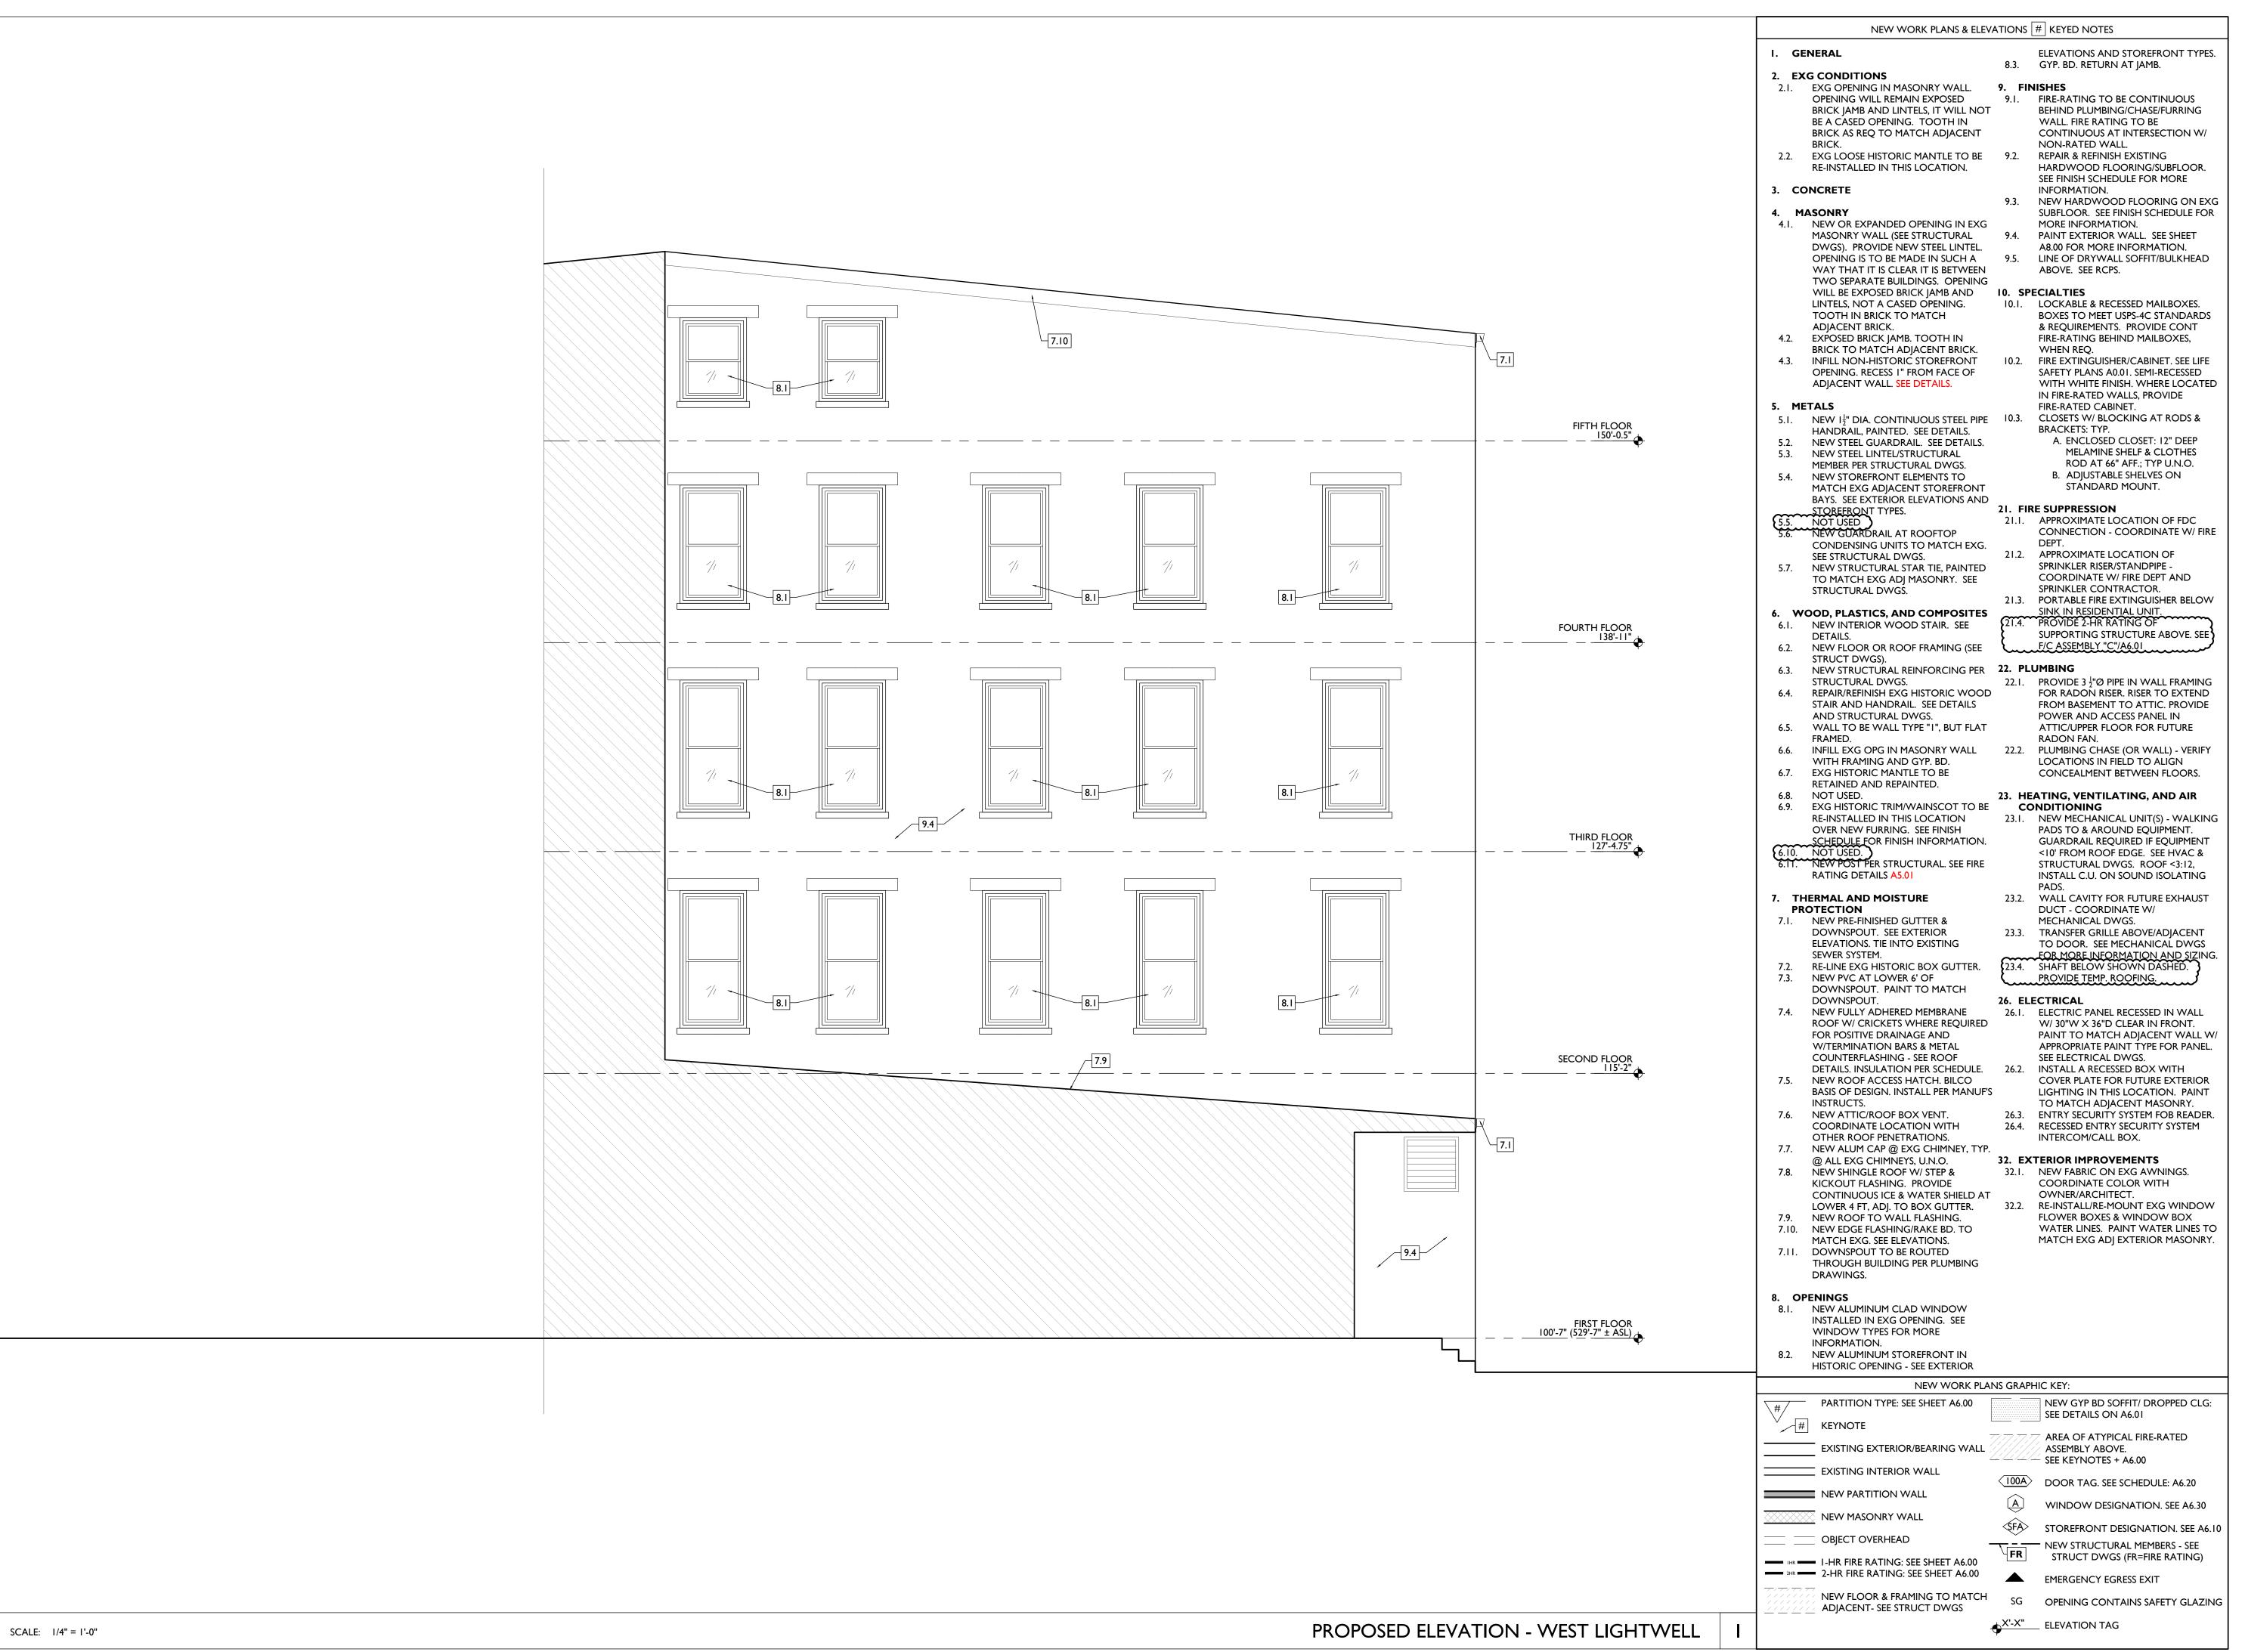


05.26.2022 - PERMIT REV I 06.15.2022 - PERMIT REV 2 08.19.2023 - ENG CHANGE I


MR, TB, SO, MR Drawn by: TB, MR

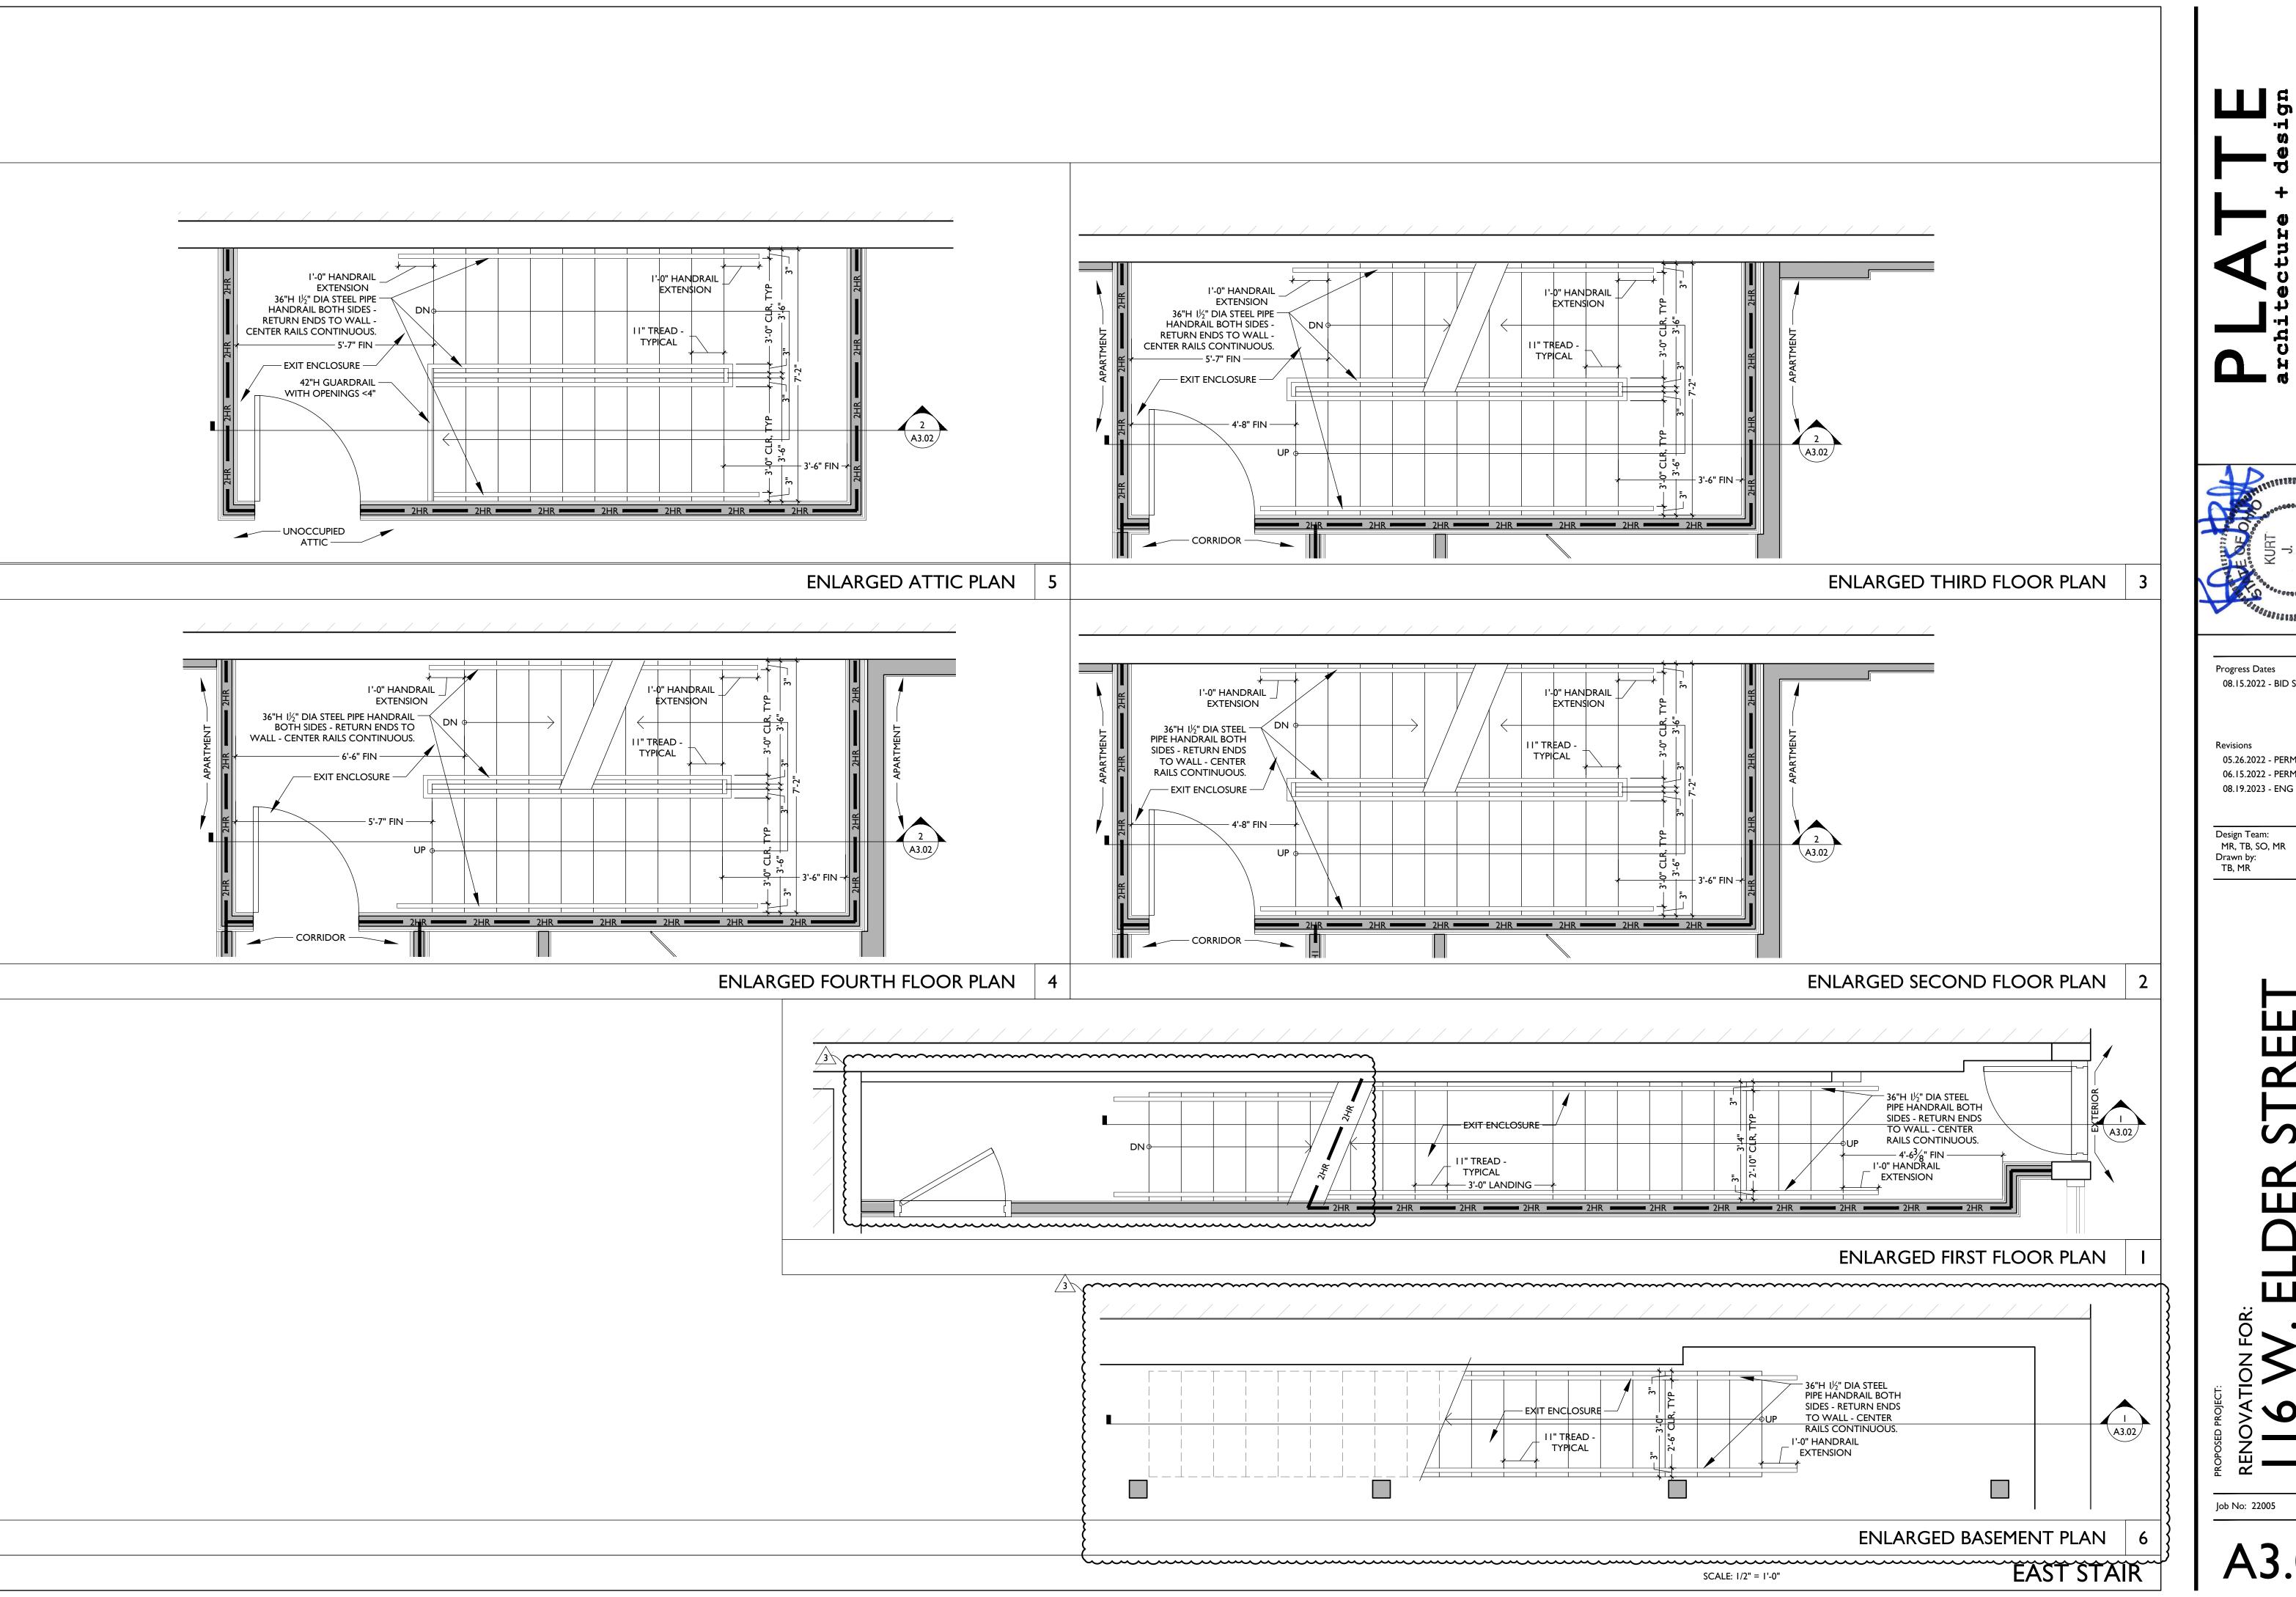


08.15.2022 - BID SET

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4C MAILBOX UNITS, RECESSED, 3700 SERIES, SERVING 21 ADDRESSES, W/ 5 PARCEL BOXES (WE CAN ADJUST/NEGOTIATE THIS, THERE ARE ONLY 16 APARTMENTS, I JUST WASN'T SURE IF COMMERCIAL SHOULD BE INCLUDED AND WANTED TO MAKE SURE THEY FIT WHERE WE WERE PROPOSING THEM!). - 3716S-06 MAILBOXES COMMERCIAL INTERIOR ELEVATIONS SCALE: 1/2" = 1'-0"

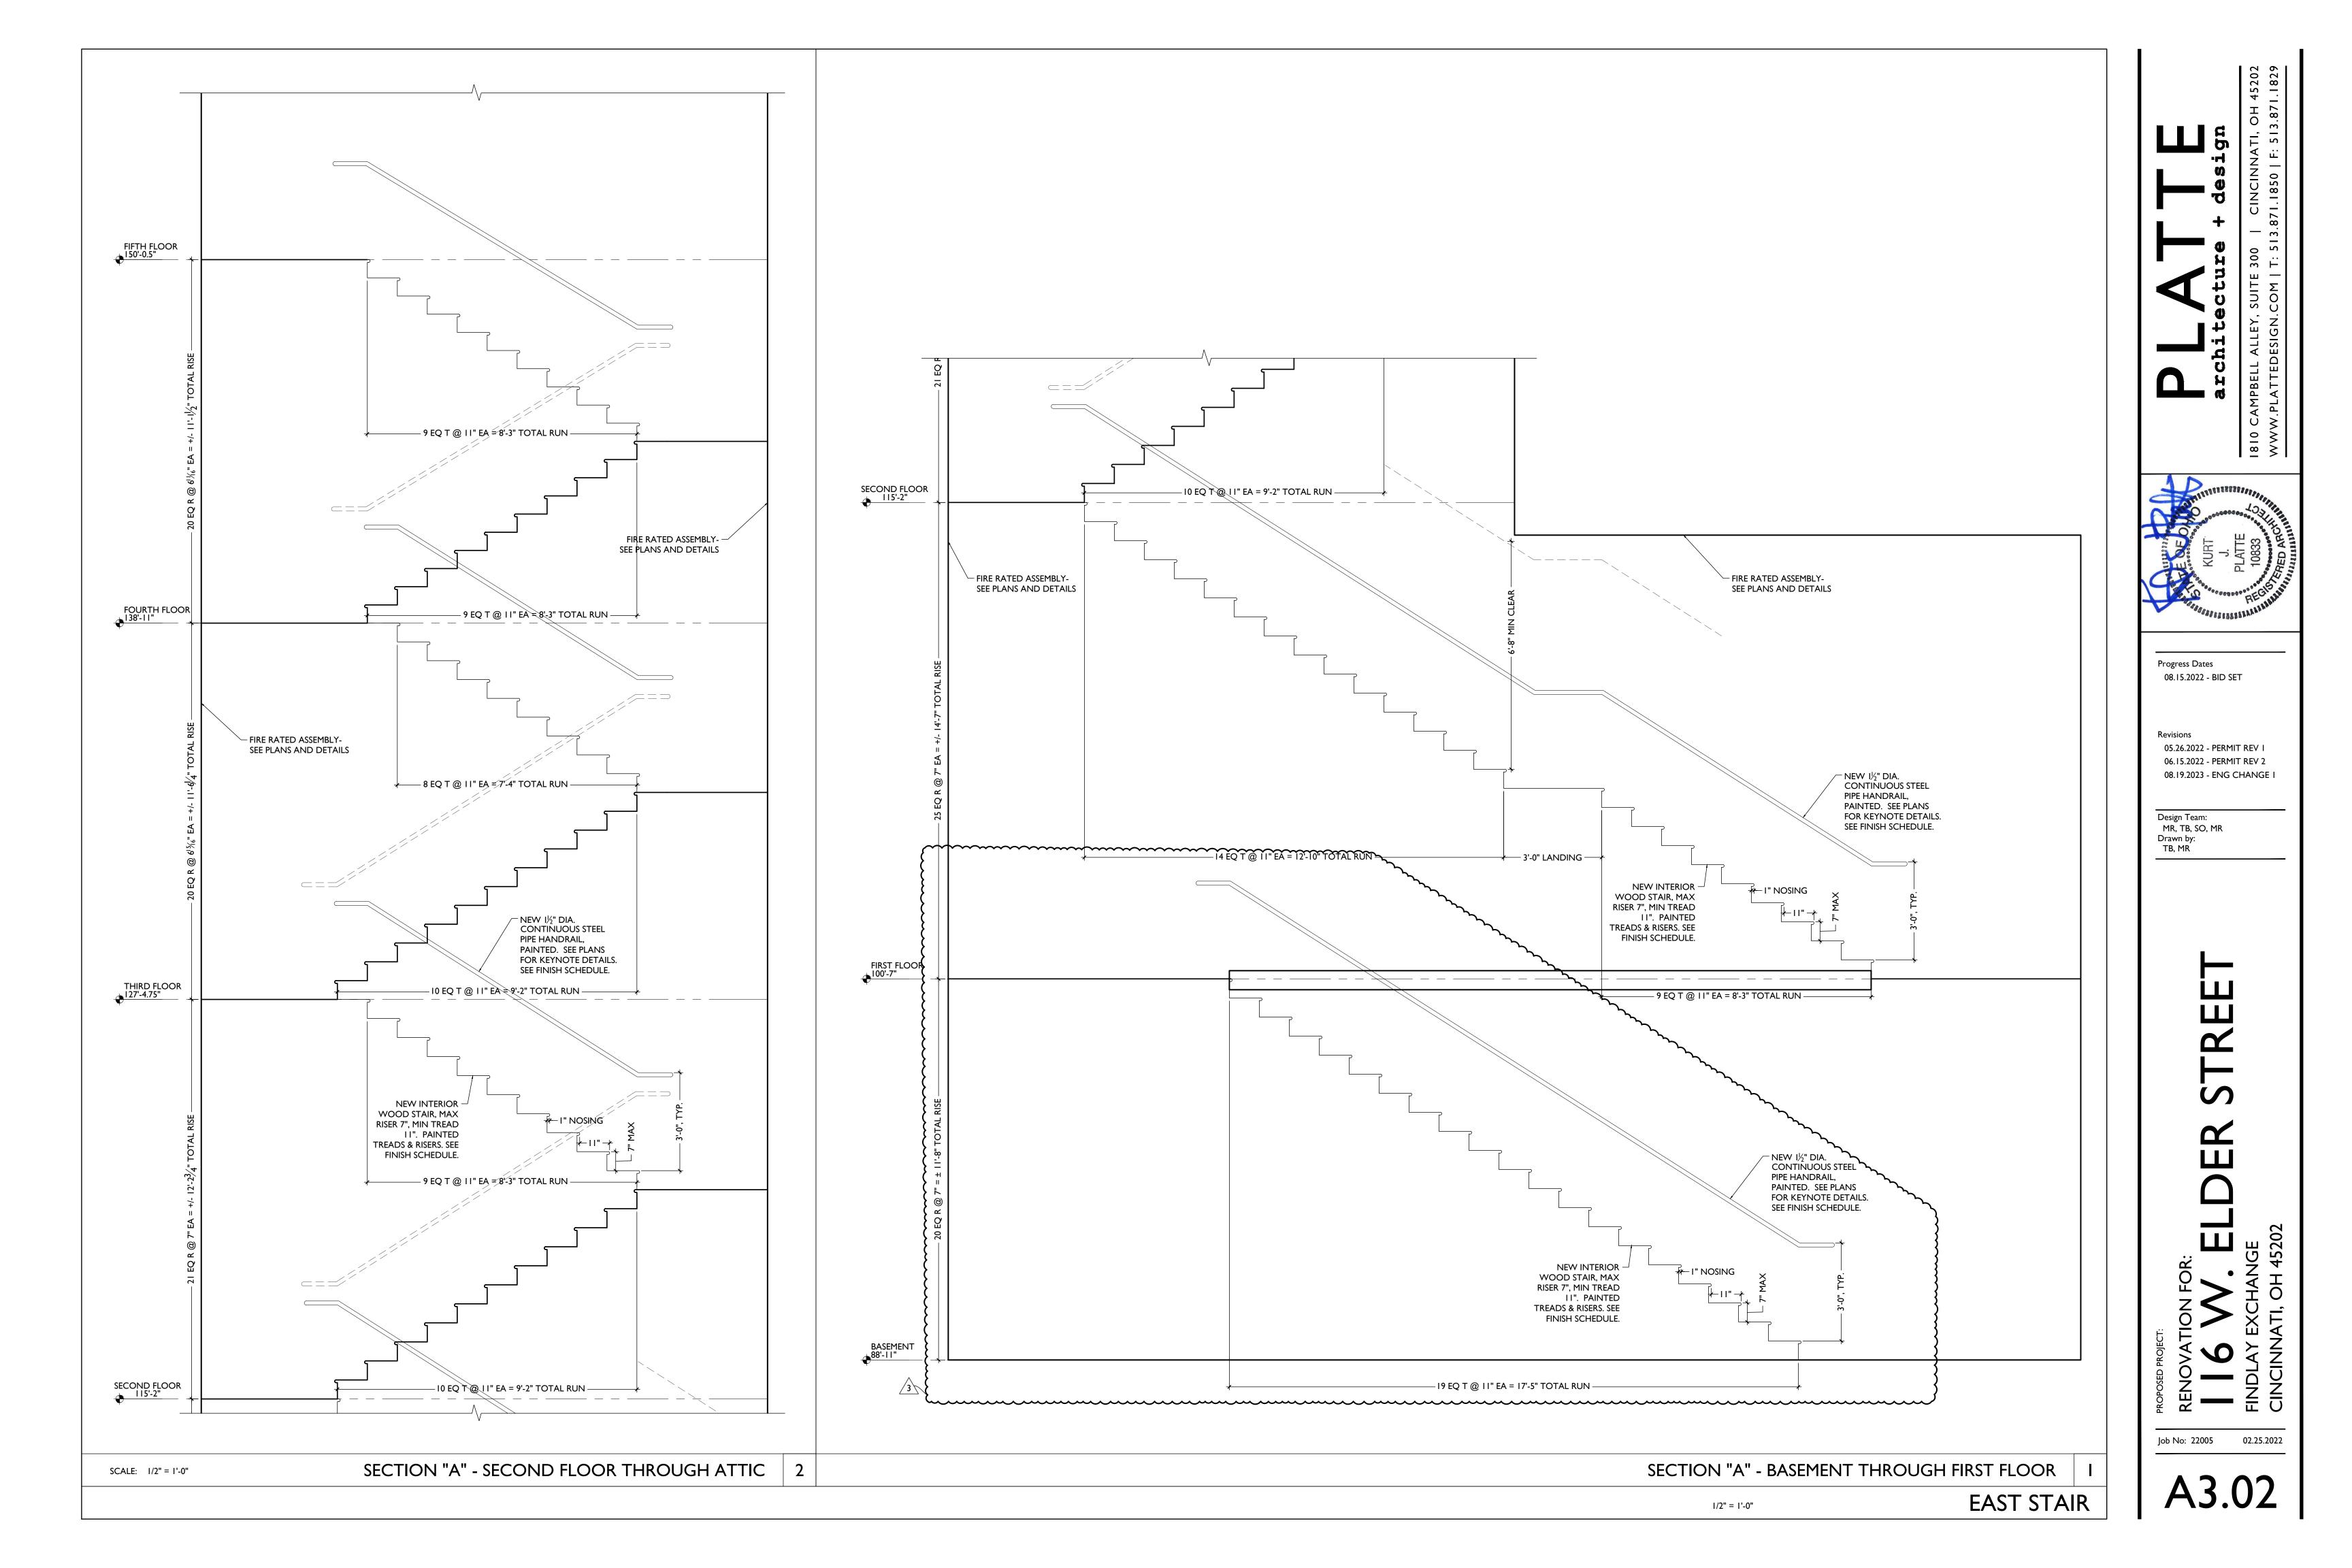Progress Dates 08.15.2022 - BID SET

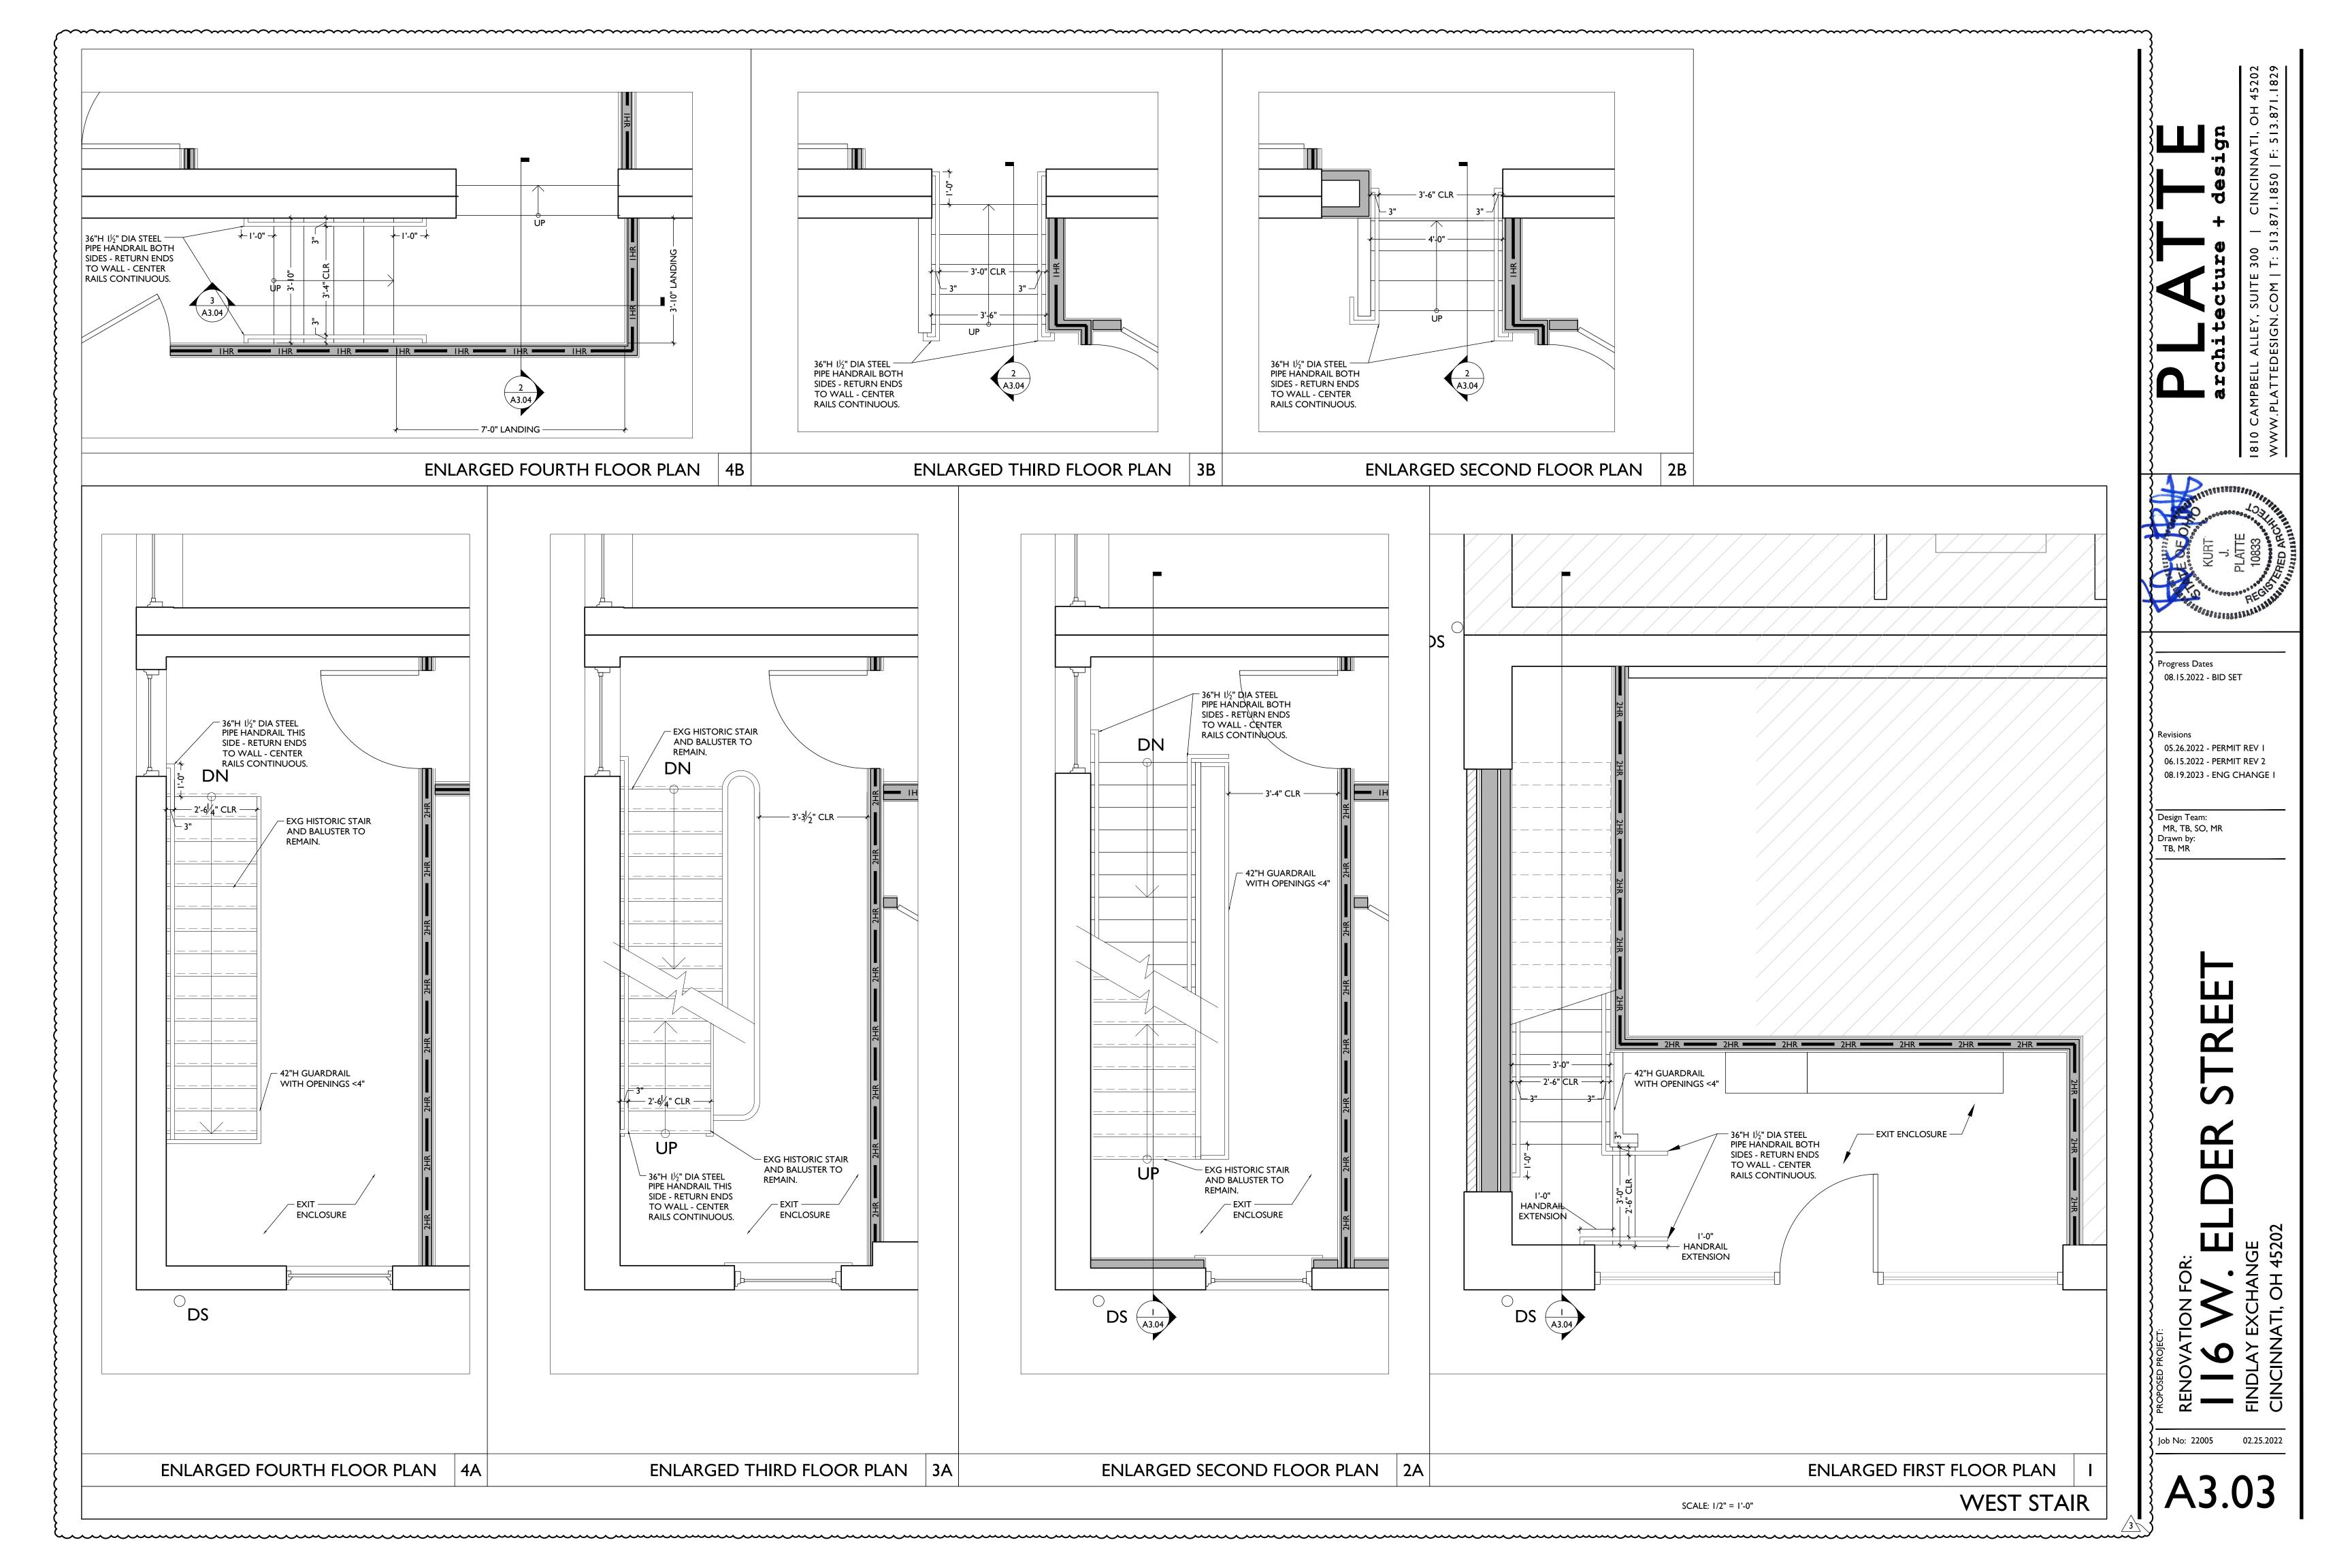05.26.2022 - PERMIT REV I 08.19.2023 - ENG CHANGE I

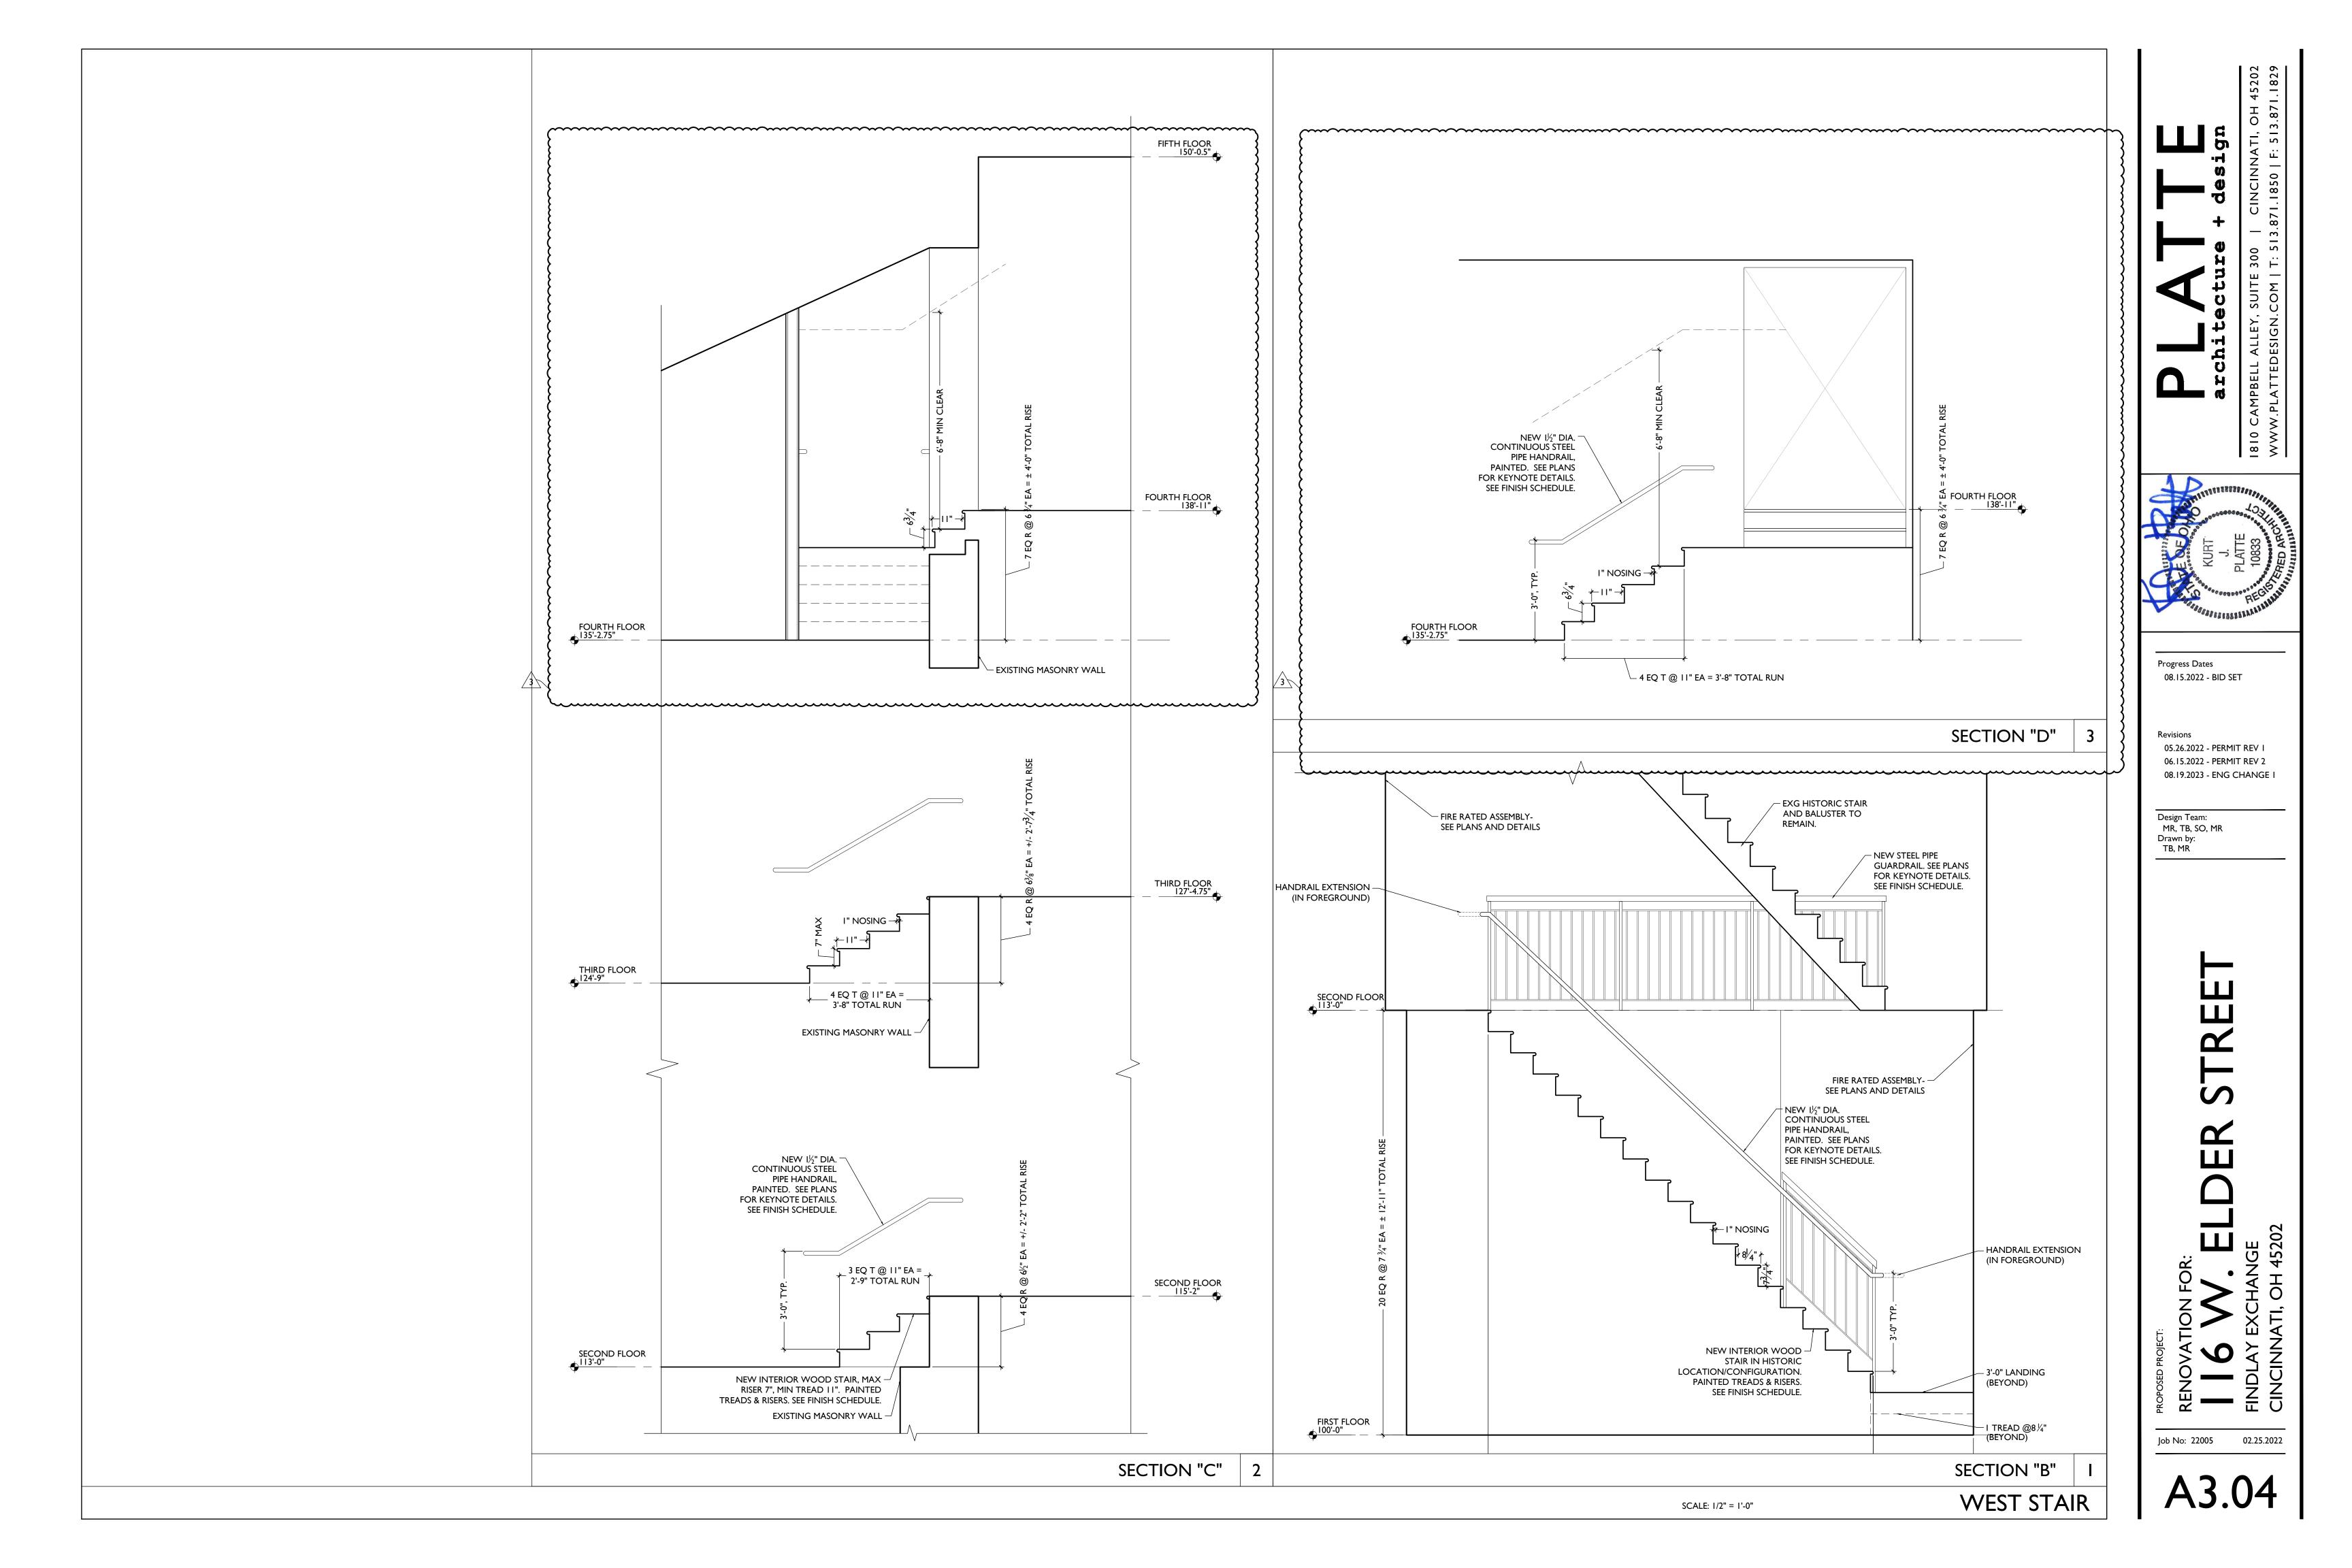Design Team: MR, TB, SO, MR Drawn by: TB, MR


Job No: 22005 02.25.2022



08.15.2022 - BID SET 05.26.2022 - PERMIT REV I

STREET

A4.20

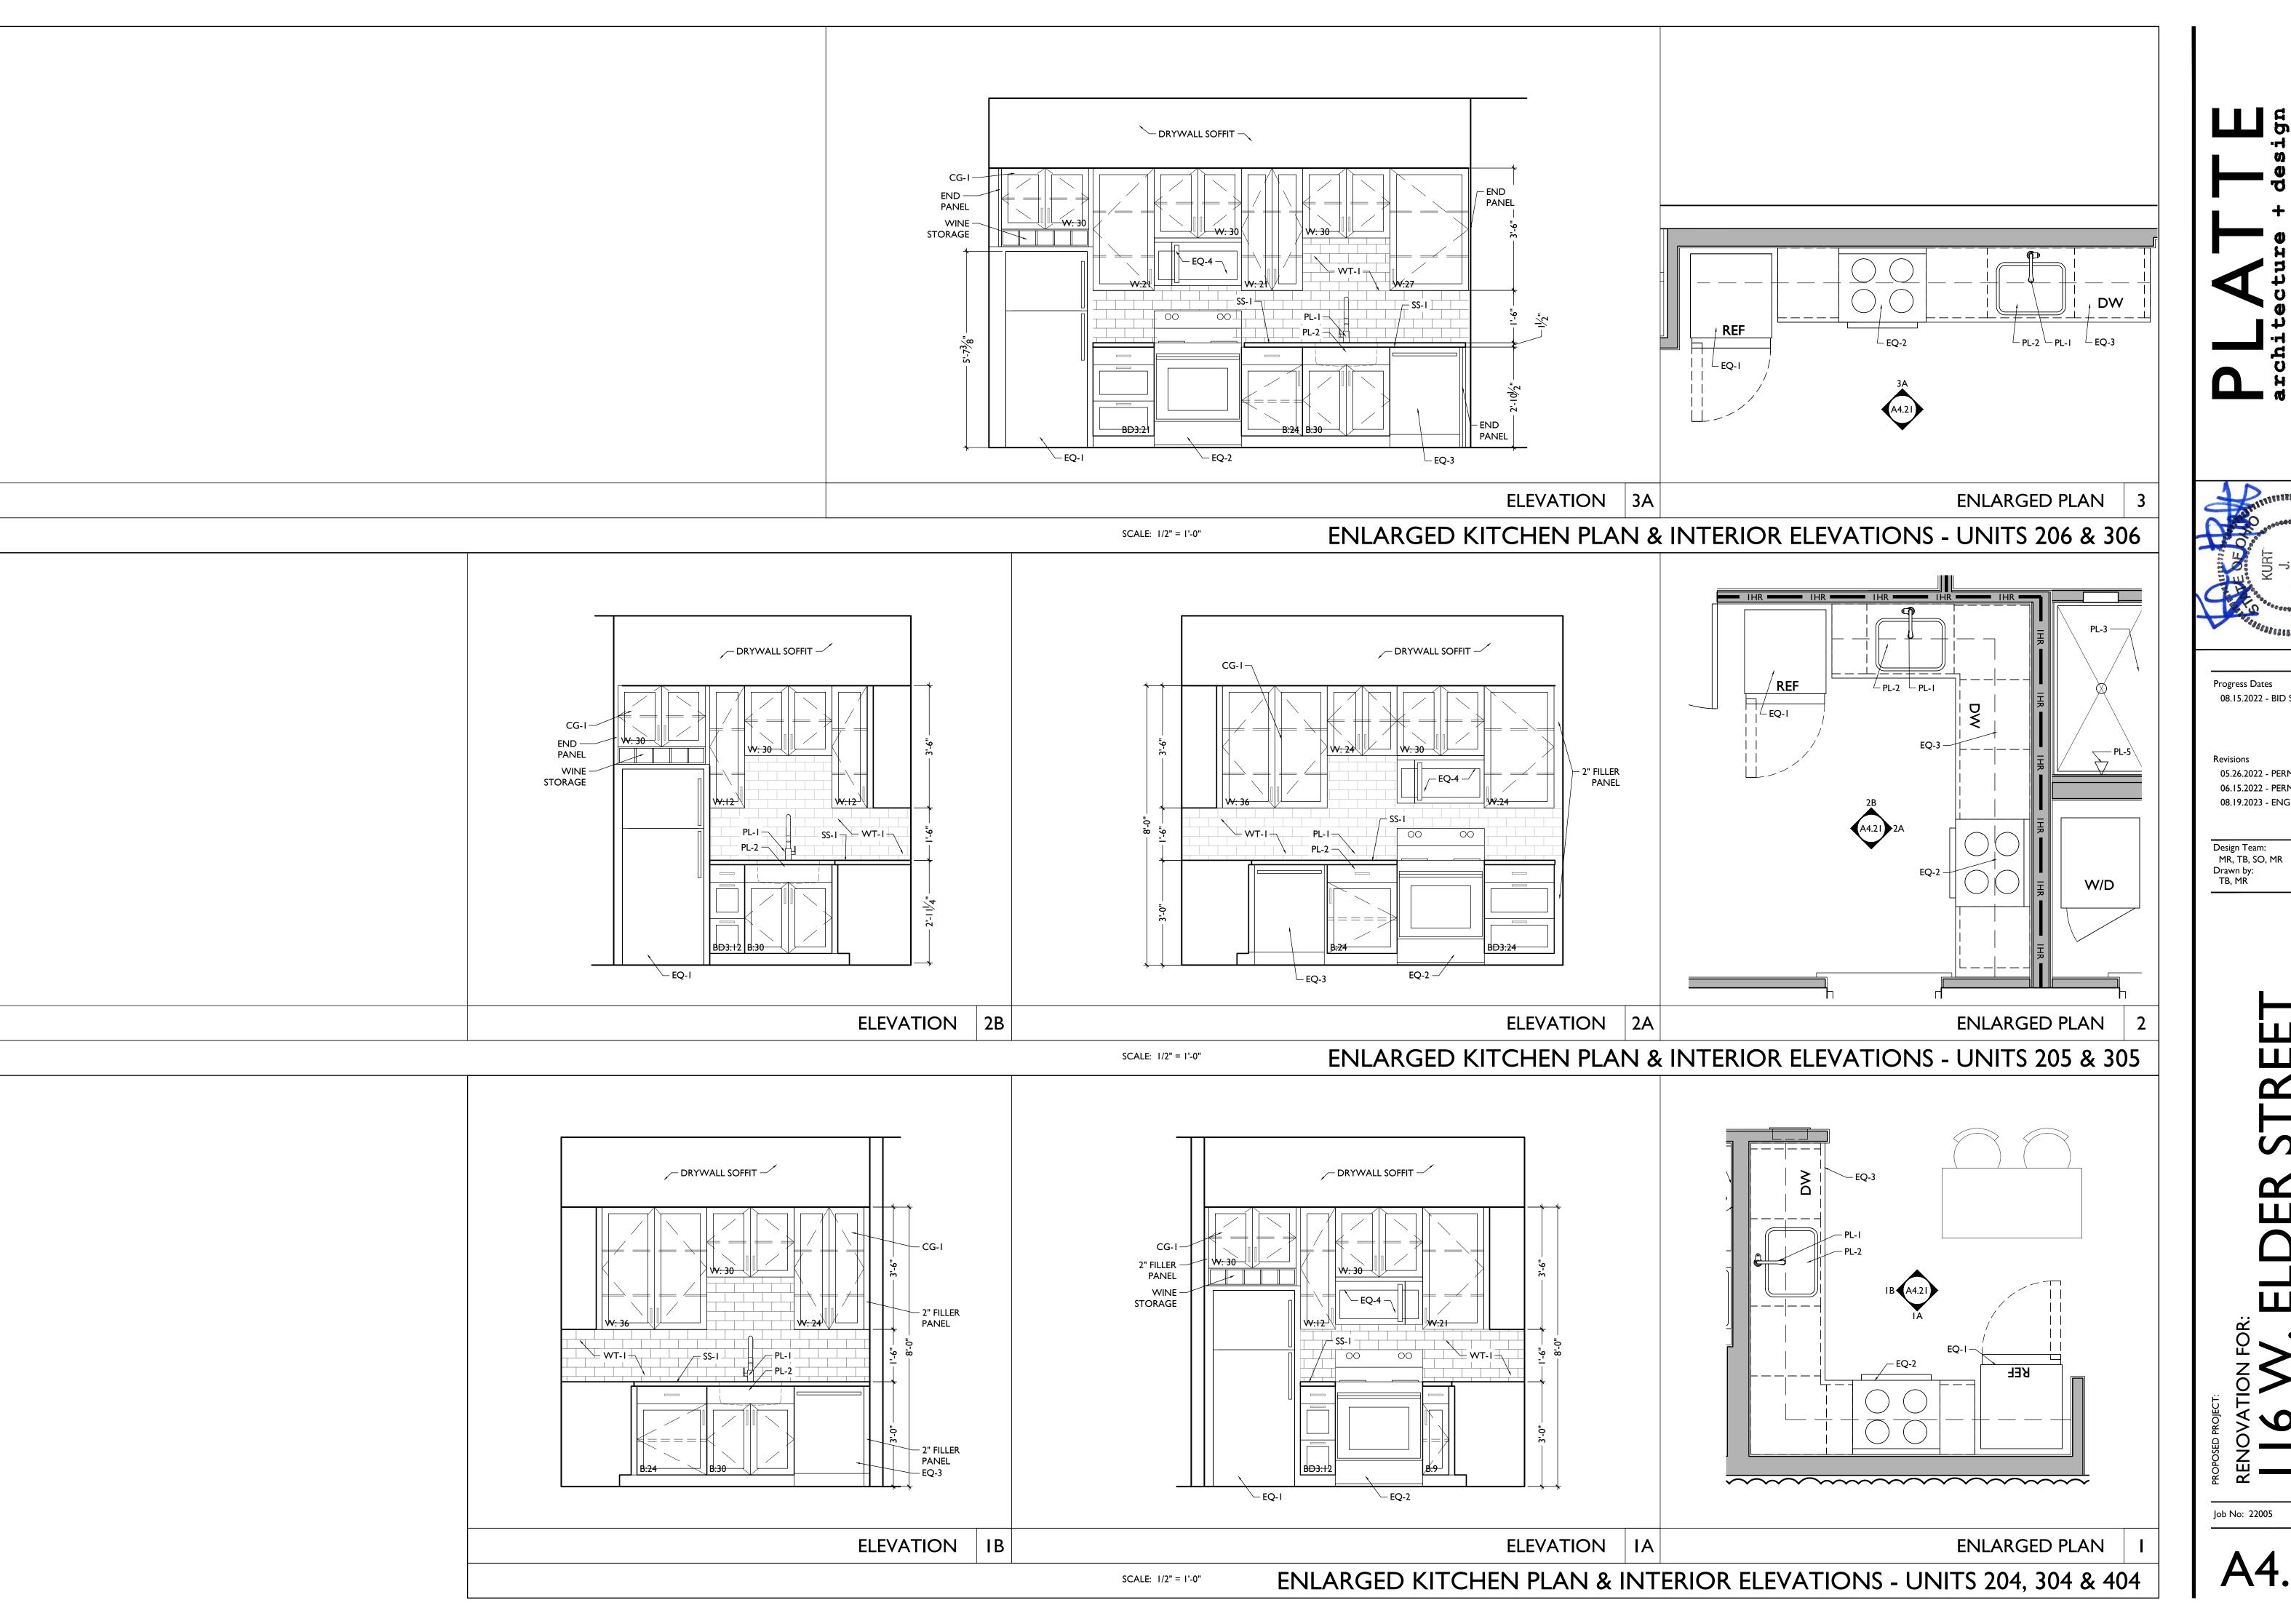

Progress Dates 08.15.2022 - BID SET 05.26.2022 - PERMIT REV I 06.15.2022 - PERMIT REV 2 08.19.2023 - ENG CHANGE I

STREET DER

A4.21



05.26.2022 - PERMIT REV I 06.15.2022 - PERMIT REV 2 08.19.2023 - ENG CHANGE I

Design Team: MR, TB, SO, MR Drawn by: TB, MR

STREET DER

A4.30




05.26.2022 - PERMIT REV I 06.15.2022 - PERMIT REV 2 08.19.2023 - ENG CHANGE I

Design Team: MR, TB, SO, MR Drawn by: TB, MR

STREET DER


A4.3 I

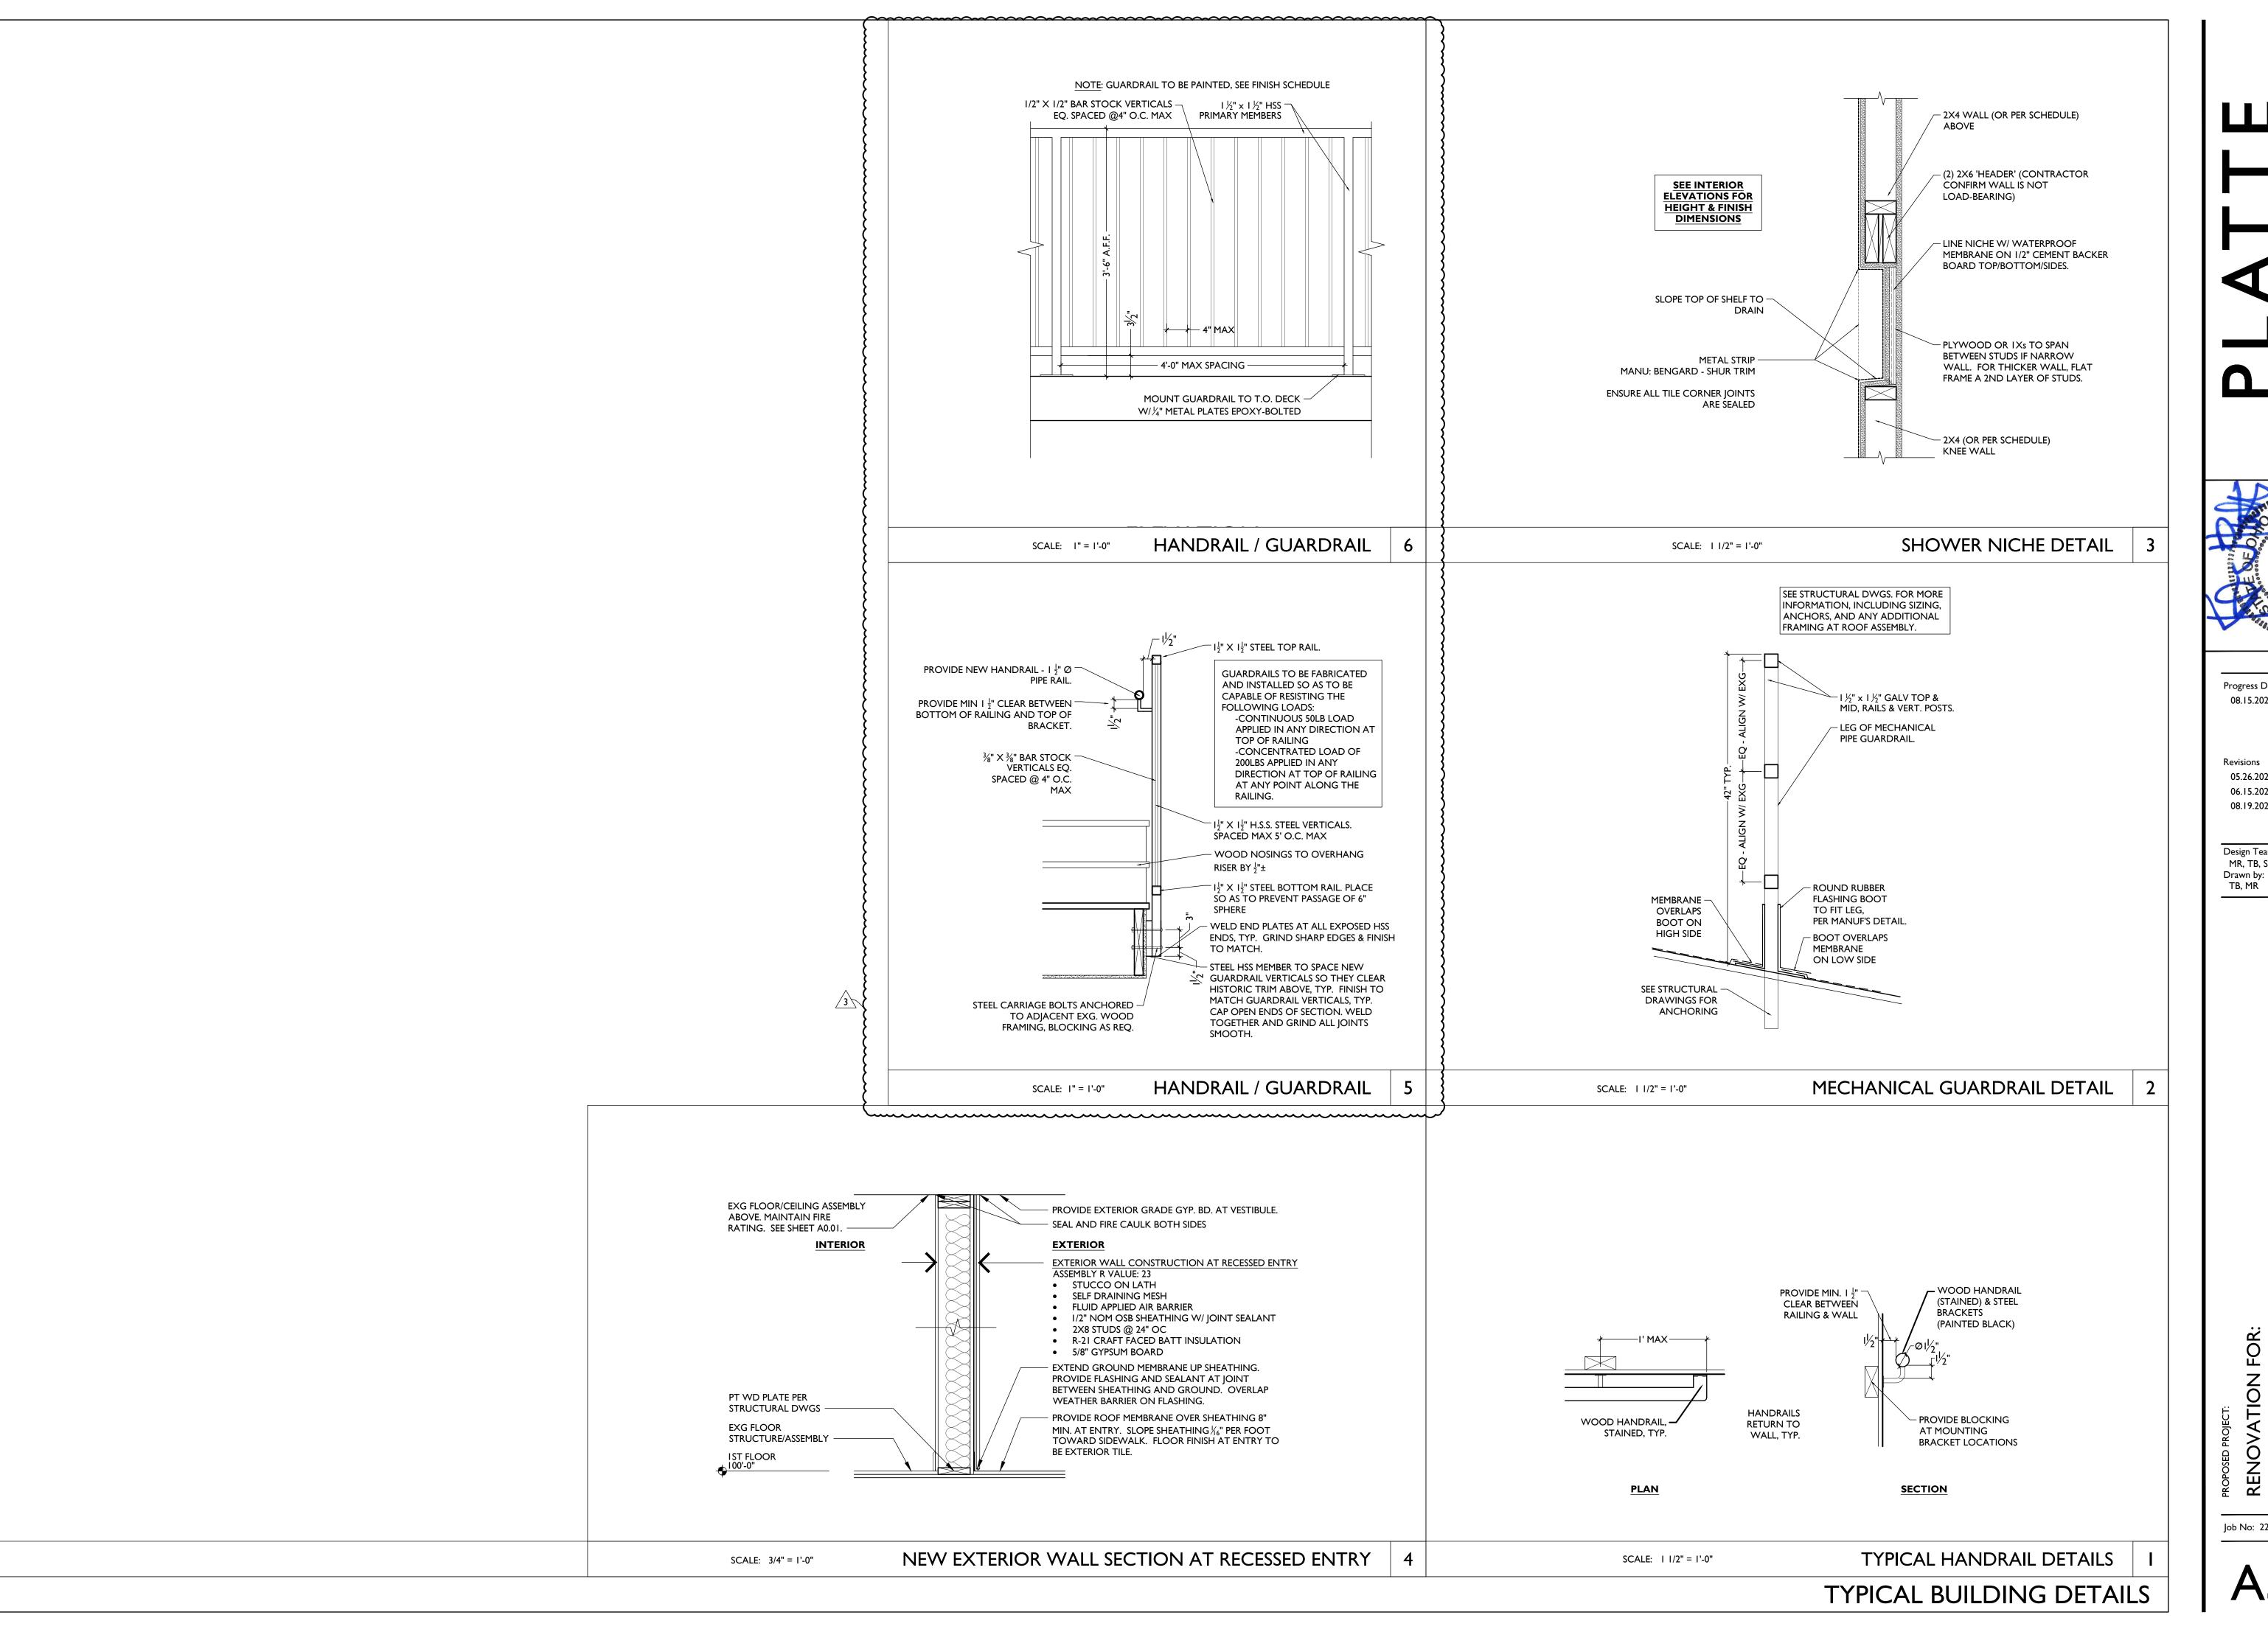

05.26.2022 - PERMIT REV I 06.15.2022 - PERMIT REV 2 08.19.2023 - ENG CHANGE I

Design Team: MR, TB, SO, MR

Job No: 22005 02.25.2022

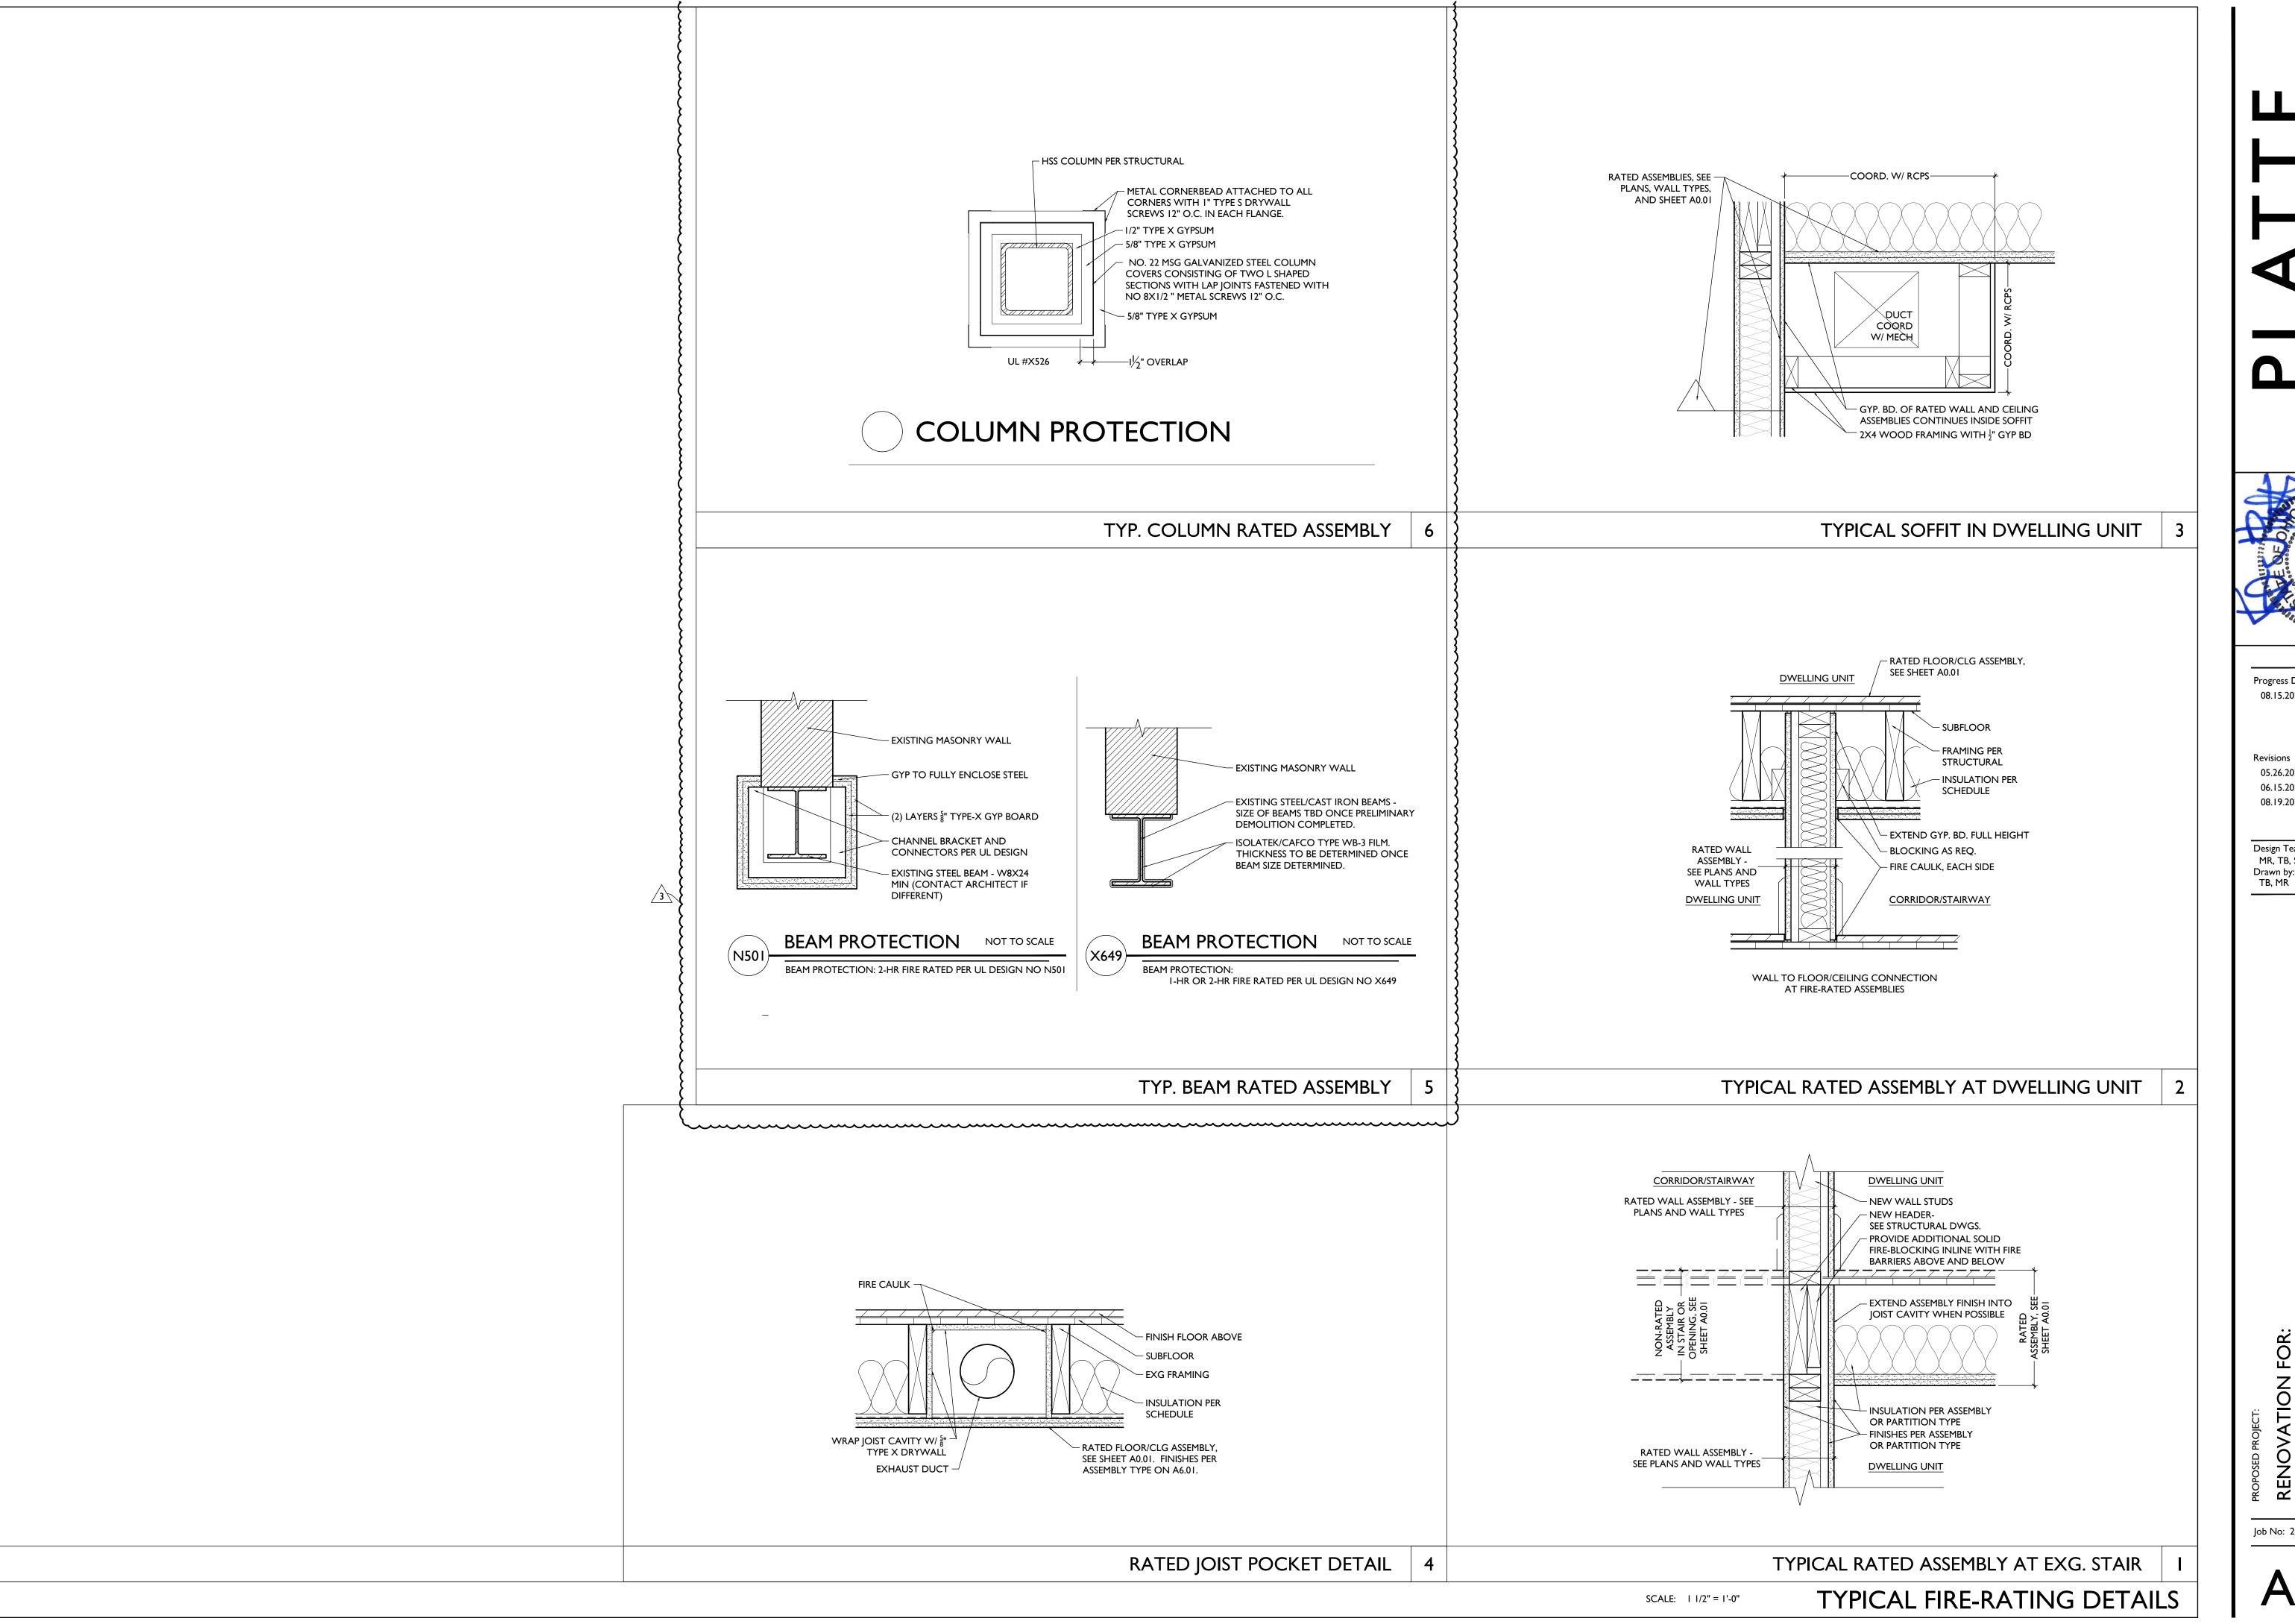


05.26.2022 - PERMIT REV I 06.15.2022 - PERMIT REV 2 08.19.2023 - ENG CHANGE I

Design Team: MR, TB, SO, MR

Drawn by: TB, MR

Job No: 22005 02.25.2022

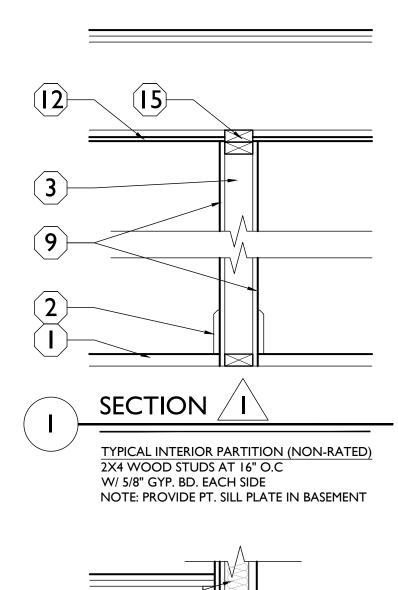

SECTION /7


NOTES: COORDINATE ALL W/ FIRE RATING & U.L. ASSEMBLY.

I. CLAY OR SHALE BRICK: SOLID BRICK

2. CONCRETE MASONRY UNIT


720 PRESCRIPTIVE FIRE RESISTANCE - TABLE 720.1 (2) RATED FIRE-RESISTANCE FOR WALLS

UL #U438

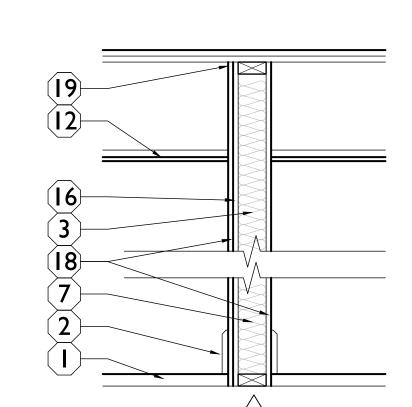


NEW 2-HR SHAFTWALL - FIRE BARRIER NEW I-HR RATED - FIRE BARRIER 4"-"C-H" SHAPED STUDS @ 24" O.C. AND "J" SHAPE RUNNERS AT TOP, BOTTOM AND SIDES W/ (2) LAYERS 5/8" TYPE X GYP. BD. ONE SIDE & (I) LAYER I" NOMINAL GYP LINER PANEL W) SOUND ATTENUATION INSUL PER SCHEDULE PROVIDE INSULATION PER SCHEDULE SECTION $\sqrt{3}$


FURRING AT EXG WALLS (NON-RATED) I 5/8" METAL STUD FURRING AT 16" O.C HELD I" OFF EXG. WALL W/ 5/8" GYP. BD. ONE SIDE, COORD DEPTH OF FURRING WHERE ELECTRICAL PANEL IS PROVIDED. SEE ELEC DWGS. PROVIDE INSULATION PER SCHEDULE

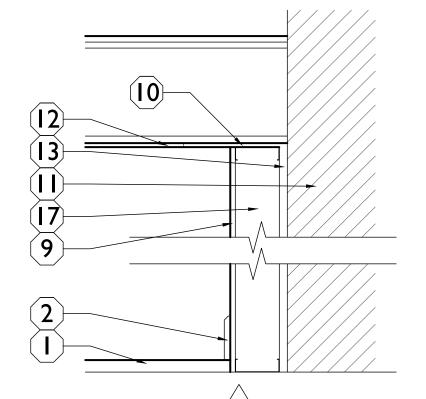

SECTION 4 PLUMBING FURRING AT EXG WALLS (NON-RATED) 2X6 METAL STUD FRAMING AT 16" O.C HELD I" OFF EXG. WALL W/ 5/8" MOISTURE-RESISTANT GYP. BD. ONE SIDE

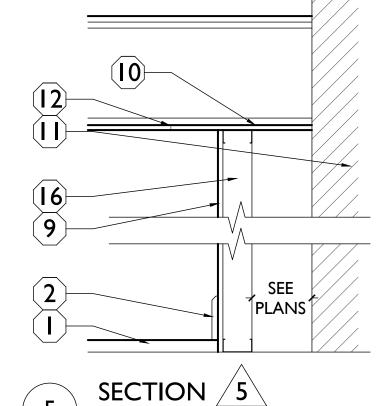

CHASE WALL (NON-RATED) 2X4 METAL STUD FRAMING AT 16" O.C W/ 5/8" GYP. BD. ONE SIDE PROVIDE INSULATION PER SCHEDULE PROVIDE MOISTURE-RESISTANT GYP. BD. IN **BATHROOMS**

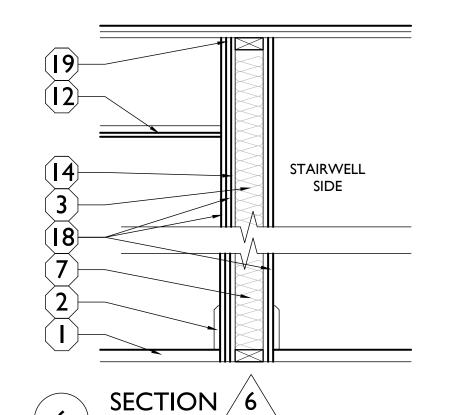

NEW 2-HR RATED - FIRE BARRIER 2X4 (U.N.O.) FIRESTOPPED WOOD STUDS AT 16" O.C. (NEW OR EXG) W/ RESILIENT CHANNELS AT 24" O.C. ONE SIDE (TYP. NON-STAIRWELL SIDE) W/ (2) LAYERS 5/8" TYPE X GYP. BD. EACH SIDE SOUND SEAL PERIMETER AT BOTH SIDES, TOP, AND BOTTOM PROVIDE INSULATION PER SCHEDULE NOTE: PROVIDE PT. SILL PLATE IN BASEMENT

UL #U301

WALL ASSEMBLIES/ PARTITION TYPES

KEYED NOTES:

FINISHED FLOOR -SEE FINISH SCHEDULE

SCHEDULED BASE -SEE FINISH SCHEDULE

WALL FRAMING (NEW OR EXG) 2X4 WOOD STUDS @ 16" O.C.

WALL FRAMING (NEW OR EXG) 2X6 WOOD STUDS @ 16" O.C.

I 5/8" METAL STUD FURRING @ 16" O.C.

6 FRAMING RATING FRAMING TO BEAR ON FLOOR OF EQUAL

INSULATION PER SCHEDULE.

SHEET A6.00

WALL STRUCTURE TO BYPASS FLR CLG **ASSEMBLY**

5/8" GYPSUM BOARD

PROVIDE GYP BD 'RIPPERS' ABOVE FURRING ALONG EXT PERIMETER TO MAINTAIN

FIRE-RATING OF F/C ASSEMBLY EXG. MASONRY OR HISTORIC PLASTER WALL

FLOOR FRAMING AND CEILING RATED ASSEMBLY CONTINUOUS TO RATED

PARTITION OR WALL. I" GAP BETWEEN FRAMING AND FACE OF **EXISTING EXTERIOR WALL**

1/2" METAL RESILIENT CHANNELS @ 24" O.C. HORIZ ON ONE SIDE OF STUDS

HORIZ. ON ONE SIDE OF STUDS

DOUBLE WOOD TOP PLATE, TO MAINTAIN FIRE-RATING OF F/C ASSEMBLY (**16**) 3 5/8" METAL STUD FRAMING @ 16" O.C.

2X6 METAL FURRING @ 16" O.C. HELD TIGHT TO WALL.

5/8" TYPE-X GYP. BOARD EXTEND RATED ASSEMBLY TO UNDERSIDE OF FLOOR SHEATHING ABOVE.

SEE DETAILS ON A6.01 (20) "J" SHAPE SIDE RUNNER

SHAFTWALL STUD @ 24" O.C. MAX

22 I" NOMINAL GYP LINER PANEL

Progress Dates 08.15.2022 - BID SET

Revisions 05.26.2022 - PERMIT REV I 06.15.2022 - PERMIT REV 2 08.19.2023 - ENG CHANGE I

MR, TB, SO, MR Drawn by: TB, MR

Job No: 22005 02.25.2022

INSULATION SCHEDULE

LOCATION	TYPE	R-VALUE	NOTES
FURRING AT EXTERIOR WALLS	SPRAY-APPLIED CELLULOSE	2.625" MIN	FILL CAVITY. SEE ASSEMBLIES "3" & "4" ON A6.00
STAIR HALL ENCLOSURE WALLS / CORRIDOR WALLS	FIBERGLASS BATTS	R-13 (3.5" MIN)	FILL CAVITY & COORD W/ FIRE-RATING & UL ASSEMBLY SEE ASSEMBLY "6" ON A6.00
FLOOR/CEILING BETWEEN AN OCCUPIED RESIDENCE AND AN UNOCCUPIED ATTIC	FIBERGLASS BATTS	R-38	INSULATION BETWEEN JOISTS. SEE ASSEMBLIES
ATTIC CEILING - UNOCCUPIED SPACE	NONE REQ		REQ INSULATION PROVIDED @ ASSEMBLY BELOW. SEE ASSEMBLY "M2" & "A" ON A6.01
ATTIC CEILING - OCCUPIED SPACE/STAIR	FIBERGLASS BATTS	R-38	SEE ASSEMBLY "MI" ON A6.0
FLOOR/CEILING BETWEEN TWO SEPARATE OCCUPIED RESIDENCES	FIBERGLASS BATTS	6" MIN	COORD W/ UL ASSEMBLY & FIRE RATING. SEE ASSEMBLIE "A" "C" "D" & "E" ON A6 01
SHAFT WALLS	FIBERGLASS BATTS	R-13 (3.5" MIN)	PROVIDE INSULATION AS REIN ATTIC SPACES ONLY.

2 HR I HR 3.8" 2.7" 3.6" 2.6" 4.9"

> SCALE: I" = I'-0"

TYPICAL PARTITION TYPES

SHAFT SIDE

W/ 5/8" MOISTURE-RESISTANT GYP. BD. EACH SIDE PROVIDE INSULATION PER SCHEDULE NOTE: PROVIDE PT. SILL PLATE IN BASEMENT

SECTION 2

TYPICAL PLUMBING WET WALL (NON-RATED)

2X6 WOOD STUDS AT 16" O.C., U.N.O.

SECTION 8

2X4 (U.N.O.) FIRESTOPPED WOOD STUDS 24" O.C. (NEW W/ 5/8" RESILIENT CHANNELS 16" O.C. ONE SIDE. W/ (I) LAYER 5/8" TYPE X GYP. BD. EACH SIDE W/ VERTICAL JOINTS LOCATED MIDWAY B/W STUDS. SOUND SEAL PERIMETER AT BOTH SIDES, TOP, AND NOTE: PROVIDE PT. SILL PLATE IN BASEMENT

UL #U309

HDWR	DWARE SCH	EDULE	DO	OR S	CHEC	DUL									DO	OR S	CHE	<u> DUL</u> E
	M	DESCRIPTION	DOOR		DO	OR				FRAME		HDW	REN	1ARKS	DOOR		DC	OOR
HOI	OORS TO REMAIN EXISTING TO REMAIN	EXISTING HARDWARE SET TO REMAIN	NO.		Т										NO.			
NEW COMM	ERCIAL DOORS			WIDTH	HEIGHT	TYPE	FINISH	AZ'G	TYPE	FINISH	GLAZ'G	TYPE	ATING	OTES		WIDTH	HEIGHT	YPE
		ENTRY LOCKSET W/ PANIC HARDWARE RATED HARDWARE PANIC HARDWARE TO BE EXIT ONLY		₹	里	-	듵	GL,	<u> </u>	ᇤ	GL	<u> </u>	- K	Ž		₹	里	<u> </u>
H02	EXTERIOR COMMERCIAL DOOR	OUTSIDE KEY LOCK, INSIDE ALWAYS UNLOCKED O(3) HINGES O(1) CLOSER	BASEME 000-1	NT 3'-0"	6'-8"	DA	PT		FA	PT		H04A	90 MIN		FOURTH 400-1	FLOOR 3'-0"	6'-8"	DA
		• SMOKE SEAL • WALL/FLOOR STOP • WEATHER SEALS	FIRST FL				<u> </u>			••••						3'-0"	6'-8"	DA
NEW COMM	ON RESIDENTIAL DOORS		100-1	2'-6"	6'-8"	DD	FF	3/4	SF3	FF	×	H03	~~~		400-3	3'-0"	5'-0"	DA DA
		• RATED HARDWARE • PANIC HARDWARE TO BE EXIT ONLY	100-2		6'-8"	DA	PT 	- FULL	FA	PT	-	H04	90 MIN	. 3	401-2	2'-6"	6'-8"	DB
H03	EGRESS DOOR FROM STAIR/CORRIDOR TO EXTERIOR	ELECTRONIC ACCESS CONTROL (INTERCOM OR KEY FOB) ELECTRIC STRIKE (3) HINGES	SECONE		6'-8"	DC	FF ~~~~	LITE	EXG	EXG	EXG	H03		رساس	401-3	2'-6" 2'-8"	6'-8" 6'-8"	DB DB
		(I) CLOSER SMOKE SEAL WALL/FLOOR STOP	200-1	1	6'-8"	PA	√ FF~	~~~	FA~	FF.	~~~	H04A	90 MIN	~~~~	401-5	3'-0"	6'-8"	DB
		WEATHER SEALS STORAGE LOCKSET	200-2	3'-0"	6'-8"	DA DA	FF FF	- <u>-</u> -	FA FA	FF FF	سيسا	H05 H05	90 MIN 20 MIN	سسسر	401-6	2'-6" 3'-0"	6'-8" 6'-8"	DB DA
H04	DOOR FROM STAIR/CORRIDOR TO	RATED HARDWARE OUTSIDE KEY LOCK, INSIDE ALWAYS UNLOCKED (3) HINGES	201-2	2'-6"	6'-8"	DB	PT	-	FB	PT	-	H06	<u> </u>)	402-2	2'-8"	6'-8"	DB
	ATTIC	(I) CLOSER SMOKE SEAL WALL/FLOOR STOP	201-3	2'-6"	6'-8" 6'-8"	DB DB	PT PT	-	FB FB	PT PT	-	H08	-	3	402-3	2'-6" 2'-6"	6'-8" 6'-8"	DB DB
		PASSAGE LOCKSET • RATED HARDWARE	201-5		6'-8"	DB	PT	-	FB	PT	-	H06	-		402-5	2'-0"	6'-8"	DB
H04A	PASSAGE DOOR BETWEEN CORRIDOR + EGRESS STAIR	• NO LOCKSET • (3) HINGES • (1) CLOSER	201-6		6'-8" 6'-8"	DB DA	PT FF	-	FB FA	PT FF	-	H08	20 MIN		403-I 403-2	3'-0" 2'-6"	6'-8" 6'-8"	DA DB
NEW DDIVA	FE RECIDENTIAL DOORS	SMOKE SEAL WALL/FLOOR STOP	202-2	2'-8"	6'-8"	DB	PT	-	FB	PT	-	H07	-		403-3	2'-8"	6'-8"	DB
	FE RESIDENTIAL DOORS	ENTRY LOCKSET • RATED HARDWARE	202-3	2'-6"	6'-8" 6'-8"	DB DB	PT PT	-	FB FB	PT PT	-	H08	-	3	403-4 404-1	2'-6" 3'-0"	6'-8" 6'-8"	DB DA
LIOF	RESIDENITIAL LIMIT FAITS COS	ELECTRONIC KEY CARD DEADBOLT (3) HINGES (1) SPRING CLOSER	202-5	2'-0"	6'-8"	DB	PT	-	FB	PT	-	H08	~~~~		404-1	2'-6"	6'-8"	DB
H05	RESIDENTIAL UNIT ENTRY DOOR	WIDE ANGLE VIEWER WALL/FLOOR STOP	203-I 203-2	3'-0" 2'-6"	6'-8" 6'-8"	DA DB	FF PT	-	FA FB	FF PT	-	H05	20 MIN	,	404-3	2'-6" 2'-8"	6'-8" 6'-8"	DB DB
		DOOR SWEEP RUBBER THRESHOLD (LOW PROFILE) PRIVACY LOCKSET	203-3	2'-8"	6'-8"	DB	PT	-	FB	PT	-	H07	-		404-4	3'-0"	6'-8"	DB DB
H06	TYPICAL BEDROOM AND BATHROOM	(3) HINGES WALL/FLOOR STOP	203-4 204-1	2'-6" 3'-0"	6'-8" 6'-8"	DB DA	PT FF	-	FB FA	PT FF	-	H06	- 20 MIN)	404-6	2'-6"	6'-8"	DB
		*WOOD "T" THRESHOLD STORAGE LOCKSET OUTSIDE KEY LOCK, INSIDE ALWAYS UNLOCKED	204-2	2'-6"	6'-8"	DB	PT	-	FB	PT	-	H06	کست		500-I	3'-0"	6'-8"	DA
H07	DOOR TO MECHANICAL CLOSET	ACCESSIBLE BY LANDLORD ONLY (3) HINGES WALL/FLOOR STOP	204-3	2'-6"	6'-8" 6'-8"	DB DB	PT PT	-	FB FB	PT PT	-	H08	-	3	CENTERA	L DOOR N	OTES.	
		WALDFLOOK STOP WOOD "T" THRESHOLD CLOSET LOCKSET	204-5	3'-0"	6'-8"	DB	PT	-	FB	PT	-	H06	-			ERIOR DOO	RS TO BE THE	
H08	SINGLE DOOR TO CLOSET/STORAGE	• (3) HINGES WALLFLOOR STOR	204-6	3'-0"	6'-8"	DB DA	PT FF	~~~~	FB FA	PT FF	-	H08 H05	20 MIN	~~~~	1₹		OOR LITES AN	
H09	DOUBLE SWINGING DOOR TO CLOSET / STORAGE	CLOSET PULLS • (3) PAIR HINGES • DUMMY LEVER HANDLES	205-2	2'-8"	6'-8"	DB	PT	-	FB	PT	-	H08	-			-FINISHED. S	SEE FINISH SCH	
·····			205-3	3'-0" 2'-6"	6'-8" 6'-8"	DB DB	PT PT	-	FB FB	PT PT	-	H07	-) 		EXG DOORS A	
. ALL HARDW			205.5		6'-8"	DB	PT	-	FB	PT	-	H06	-		PROPOSED		TAX CREDIT F R INFORMATIC D TO	
Σ. ALL HARDV	VARE TO BE SATIN CHROME, STAINLESS S		205-6	3'-0" 2'-4"	6'-8" 6'-8"	DB DB	PT PT	-	FB FB	PT PT	-	H08 H09	-	3	6. ALL RES	IDENTIAL UI	NIT ENTRY DO OWLEDGE OF	
TO BE POW	DER COAT TO MATCH. /ARE TO BE AS SPECIFIED OR APPROVED	EQUAL.	206-1	3'-0"	6'-8"	DA	FF	-	FA	FF	-	H05	20 MIN		7. ALL INT	ERIOR STAIR	RWAY MEANS SPECIAL KNC	OF EGRESS
COORDIN (ND SERIE	NATE KEYING REQUIREMENTS WITH OWI S), SARGENT (10 LINE). KEY SYSTEM - PRO	ADE I (MORTISE LOCK FOR TOILETS WITH INDICATOR). 'NER. APPROVED MANUFACTURERS: BEST (9K3 SERIES), SCHLAC DVIDE MASTER SYSTEM (KEY INTO OWNER'S EXISTING SMALL	206-2	3'-0" 2'-8"	6'-8" 6'-8"	DB DB	PT PT	-	FB FB	PT PT	-	H07 H08	-) 	DOOR NO		
B. EXIT DEVI	KEY SYSTEM), 5 MASTER KEYS, 3 CHANGE CES ARE BASED ON PRECISION 2100 SERII ON DUPRIN (98 SERIES)	EKEYS PER CYLINDER. IES GRADE I. APPROVED MANUFACTURERS: PRECISION (2100	206-4	2'-8"	6'-8"	DB	PT	-	FB	PT	-	H06	-		Ҡ		IE IN AN EXG	
MANUFA	OSERS ARE BASED ON DORMA 8900 SERI CTURERS: DORMA (8900 SERIES), LCN (404	IES GRADE 1. PROVIDE WITH FULL COVER. APPROVED 40XP SERIES).	206-5		6'-8" 6'-8"	DB DB	PT PT	-	FB FB	PT PT	-	H08	-		 		E UNDERCUT	
		4-1/2", DOORS WIDER THAN 3 FEET TO BE 5" X 4-1/2". R DOORS UP TO 7'6". PROVIDE 4 HINGES FOR DOORS TALLER	(——	LOOK~~										•••••	3			
THAN 7'6 5. COORDINA	". TE KEYING REQUIREMENTS WITH OWNE	ER.	300-1		6'-8"	DA DA	FF FF	<u>~~~</u>	FA FA	FF FF	$\sim\sim$	H04A H04A	90 MIN 90 MIN	~~~~	TYP.			
	TE ELECTRONIC ACCESS CONTROL REQ							$\overline{}$	FA	FF)			
6. COORDINA		DUIREMENTS WITH OWNER	301-1	3'-0"	6'-8"	DA	FF	-	17	• • •	-	H05	20 MIN					
6. COORDINA		QUIREMENTS WITH OWNER		2'-6"	6'-8" 6'-8"	DA DB	FF PT	-	FB FB	PT PT	-	H05 (H06 H08	20 MIN - -	3				
. COORDINA		QUIREMENTS WITH OWNER	301-1 301-2 301-3 301-4	2'-6" 2'-6" 2'-8"	6'-8" 6'-8"	DB DB	PT PT PT		FB FB	PT PT PT	-	H05 (H06 H08 H07	20 MIN - -	<i></i>				
. COORDINA		QUIREMENTS WITH OWNER	301-1 301-2 301-3	2'-6" 2'-6" 2'-8" 3'-0"	6'-8" 6'-8"	DB DB	PT PT		FB FB	PT PT	- - - -	H05 (H06 H08	20 MIN - - - -	<i></i>				
6. COORDINA		QUIREMENTS WITH OWNER	301-1 301-2 301-3 301-4 301-5 301-6	2'-6" 2'-6" 2'-8" 3'-0" 2'-6" 3'-0"	6'-8" 6'-8" 6'-8" 6'-8" 6'-8"	DB DB DB DB DB DA	PT PT PT PT FF	- - - - -	FB FB FB FB FA	PT PT PT PT FF	- - - - -	H05 (H06 H08 H07 H06 H08 H05 (H05 H05 H05 H05 H05 H05 H05 H05 H05 H05	20 MIN 20 MIN	<i></i>				
. COORDINA		QUIREMENTS WITH OWNER	301-1 301-2 301-3 301-4 301-5 301-6	2'-6" 2'-6" 2'-8" 3'-0" 2'-6" 3'-0" 2'-8"	6'-8" 6'-8" 6'-8" 6'-8"	DB DB DB DB DB	PT PT PT PT	- - - - - -	FB FB FB FB	PT PT PT PT	- - - - - -	H05 (H06 H08 H07 H06 H08	-	<i></i>				
, COORDINA		QUIREMENTS WITH OWNER	301-1 301-2 301-3 301-4 301-5 301-6 302-1 302-2 302-3 302-4	2'-6" 2'-6" 2'-8" 3'-0" 2'-6" 3'-0" 2'-6" 2'-6"	6'-8" 6'-8" 6'-8" 6'-8" 6'-8" 6'-8" 6'-8"	DB DB DB DB DA DB DB DB DB	PT PT PT PT FF PT PT PT		FB FB FB FA FB FB FB FB	PT PT PT PT PT FF PT PT PT	- - - - - - -	H05 (H06) H07 H06 H07 H08 H07 H08 H06	-	3				
6. COORDINA		QUIREMENTS WITH OWNER	301-1 301-2 301-3 301-4 301-5 301-6 302-1 302-2 302-3	2'-6" 2'-6" 2'-8" 3'-0" 2'-6" 3'-6" 2'-6" 2'-6" 2'-6"	6'-8" 6'-8" 6'-8" 6'-8" 6'-8" 6'-8"	DB DB DB DB DB DA DB DB DB	PT PT PT PT FF PT PT	- - - - - - -	FB FB FB FA FB FB	PT PT PT PT PT PT FF PT PT		H05 (H06 H08 H07 H06 H08 H07 H08 H06 H08 H06 H08	- - - - 20 MIN	3				
6. COORDINA		QUIREMENTS WITH OWNER	301-1 301-2 301-3 301-4 301-5 301-6 302-1 302-2 302-3 302-4 302-5 303-1 303-2	2'-6" 2'-6" 2'-8" 3'-0" 2'-6" 2'-6" 2'-6" 2'-6" 2'-6" 2'-6" 2'-6"	6'-8" 6'-8" 6'-8" 6'-8" 6'-8" 6'-8" 6'-8" 6'-8" 6'-8" 6'-8"	DB DB DB DB DA DB DB DB DB DB DB DB	PT PT PT FF PT PT FF PT PT PT PT PT PT		FB	PT PT PT PT FF PT		H05 (H06 H08 H05 H06 H08 H05 H06 H08 H05 H08 H05 H08	- - - - 20 MIN - - -	3				
6. COORDINA		QUIREMENTS WITH OWNER	301-1 301-2 301-3 301-4 301-5 301-6 302-1 302-2 302-3 302-4 302-5 303-1	2'-6" 2'-6" 2'-8" 3'-0" 2'-6" 2'-6" 2'-6" 2'-6" 2'-6" 2'-6" 2'-6"	6'-8" 6'-8" 6'-8" 6'-8" 6'-8" 6'-8" 6'-8" 6'-8"	DB DB DB DB DA DB	PT PT PT FF PT PT FF FF FF		FB FB FB FA FB FB FB FB FA FB FB FB FB	PT PT PT FF PT PT FF FF FF		H05 (H06 H08 H07 H06 H08 H06 H08 H05 H06 H08 H05 H05 H07 H08 H06 H08 H05	- - - - 20 MIN	3				
6. COORDINA		QUIREMENTS WITH OWNER	301-1 301-2 301-3 301-4 301-5 301-6 302-1 302-2 302-3 302-4 302-5 303-1 303-2 303-3 303-4	2'-6" 2'-6" 2'-8" 3'-0" 2'-6" 2'-6" 2'-6" 2'-6" 2'-6" 2'-6" 2'-6" 2'-6" 2'-6" 3'-0"	6'-8" 6'-8" 6'-8" 6'-8" 6'-8" 6'-8" 6'-8" 6'-8" 6'-8" 6'-8" 6'-8" 6'-8" 6'-8"	DB DB DB DB DA DB	PT PT PT PT FF PT	- - - - - - - - - - - -	FB FB FB FB FB FB FB FB FA FB FA FB FA FB FA FB FA	PT PT PT PT FF PT		H05 (H06 H08 H07 H06 H08 H05 H08 H07 H06 H08 H07 H06 H08 H07 H06 H05 (H06 H05 H06		3				
6. COORDINA		QUIREMENTS WITH OWNER	301-1 301-2 301-3 301-4 301-5 301-6 302-1 302-2 302-3 302-4 302-5 303-1 303-2 303-3 303-4	2'-6" 2'-6" 2'-8" 3'-0" 2'-6" 2'-6" 2'-6" 2'-6" 2'-6" 2'-6" 2'-6" 2'-6" 2'-6" 2'-6"	6'-8" 6'-8" 6'-8" 6'-8" 6'-8" 6'-8" 6'-8" 6'-8" 6'-8" 6'-8" 6'-8" 6'-8"	DB DB DB DB DA DB	PT PT PT FF PT		FB	PT P		H05 (H06) H08 H07 H08 H05 H08 H05 H08 H07 H06 H08 H07 H06		3				
6. COORDINA		QUIREMENTS WITH OWNER	301-1 301-2 301-3 301-4 301-5 301-6 302-1 302-2 302-3 302-4 302-5 303-1 303-2 303-3 304-1 304-2 304-3 304-4	2'-6" 2'-6" 2'-6" 3'-0" 2'-6" 2'-6" 2'-6" 2'-6" 2'-6" 2'-6" 2'-6" 2'-6" 2'-6" 2'-6" 2'-6" 2'-6"	6'-8" 6'-8" 6'-8" 6'-8" 6'-8" 6'-8" 6'-8" 6'-8" 6'-8" 6'-8" 6'-8" 6'-8" 6'-8" 6'-8" 6'-8"	DB DB DB DB DA DB	PT P		FB F	PT P		H05 (H06 H08 H07 H06 H08 H07 H06 H06 H08 H07 H06 H06 H08 H07		3				
. COORDINA		QUIREMENTS WITH OWNER	301-1 301-2 301-3 301-4 301-5 301-6 302-1 302-2 302-3 302-4 302-5 303-1 303-2 303-3 304-1 304-2 304-3 304-4 304-5	2'-6" 2'-6" 2'-6" 3'-0" 2'-6" 2'-6" 2'-6" 2'-6" 2'-6" 2'-6" 2'-6" 2'-6" 2'-6" 2'-6" 3'-0" 2'-6" 3'-0"	6'-8" 6'-8" 6'-8" 6'-8" 6'-8" 6'-8" 6'-8" 6'-8" 6'-8" 6'-8" 6'-8" 6'-8" 6'-8" 6'-8" 6'-8" 6'-8"	DB D	PT P		FB F	PT P		H05 (H06 H08 H07 H06 H06 H08 H07 H06		3				
. COORDINA		QUIREMENTS WITH OWNER	301-1 301-2 301-3 301-4 301-5 301-6 302-1 302-2 302-3 302-4 302-5 303-1 303-2 303-3 304-1 304-2 304-3 304-5 304-6 305-1	2'-6" 2'-6" 2'-6" 3'-0" 2'-6" 2'-6" 2'-6" 2'-6" 2'-6" 2'-6" 2'-6" 2'-6" 2'-6" 2'-6" 3'-0" 2'-6" 2'-6" 2'-6" 2'-6"	6'-8" 6'-8" 6'-8" 6'-8" 6'-8" 6'-8" 6'-8" 6'-8" 6'-8" 6'-8" 6'-8" 6'-8" 6'-8" 6'-8" 6'-8" 6'-8"	DB D	PT P	- - - - - - - - - - - - - - - - - - -	FB F	PT P		H05 (H08 H07 H06 H08 H07 H06		3				
. COORDINA		QUIREMENTS WITH OWNER	301-1 301-2 301-3 301-4 301-5 301-6 302-1 302-2 302-3 302-4 302-5 303-1 303-2 303-3 304-1 304-2 304-3 304-5	2'-6" 2'-6" 2'-6" 3'-0" 2'-6" 3'-0" 2'-6" 2'-6" 2'-6" 2'-6" 2'-6" 2'-6" 2'-6" 2'-6" 2'-6" 2'-6" 2'-6" 2'-6" 2'-6"	6'-8" 6'-8" 6'-8" 6'-8" 6'-8" 6'-8" 6'-8" 6'-8" 6'-8" 6'-8" 6'-8" 6'-8" 6'-8" 6'-8" 6'-8"	DB DB DB DB DA DB	PT P		FB F	PT P		H05 (H06 H08 H07 H06 H08		3				
o, COORDINA		QUIREMENTS WITH OWNER	301-1 301-2 301-3 301-4 301-5 301-6 302-1 302-2 302-3 302-4 302-5 303-1 303-2 303-3 304-1 304-2 304-3 304-5 305-1 305-2 305-3 305-4	2'-6" 2'-6" 2'-6" 3'-0" 2'-6" 2'-6" 2'-6" 2'-6" 2'-6" 2'-6" 2'-6" 2'-6" 2'-6" 2'-6" 2'-6" 2'-6" 2'-8" 3'-0" 2'-6" 2'-8" 3'-0" 2'-8" 3'-0" 2'-8"	6'-8" 6'-8"	DB D	PT P		FB F	PT P	-	H05 (H06 H08 H07 H06 H08 H07 H08 H08 H08 H07 H08		3				
. COORDINA		QUIREMENTS WITH OWNER	301-1 301-2 301-3 301-4 301-5 301-6 302-1 302-2 302-3 302-4 302-5 303-1 303-2 303-3 304-1 304-2 304-3 304-3 304-6 305-1 305-2 305-3	2'-6" 2'-6" 2'-6" 3'-0" 2'-6"	6'-8" 6'-8" 6'-8" 6'-8" 6'-8" 6'-8" 6'-8" 6'-8" 6'-8" 6'-8" 6'-8" 6'-8" 6'-8" 6'-8" 6'-8" 6'-8" 6'-8" 6'-8" 6'-8" 6'-8"	DB D	PT P		FB F	PT P	-	H05 H08 H07 H06 H08 H05 H06 H08 H07 H08 H08 H07 H08 H08 H07 H08		3				
S. COORDINA		QUIREMENTS WITH OWNER	301-1 301-2 301-3 301-4 301-5 301-6 302-1 302-2 302-3 302-4 302-5 303-1 303-2 303-3 304-1 304-2 304-3 304-5 305-1 305-2 305-3 305-4 305-5 305-6 305-7	2'-6" 2'-6" 2'-6" 3'-0" 2'-6"	6'-8" 6'-8"	DB D	PT P	-	FB F	PT P		H05 H08 H07 H06 H08 H09		3				
6. COORDINA		QUIREMENTS WITH OWNER	301-1 301-2 301-3 301-4 301-5 301-6 302-1 302-2 302-3 302-4 302-5 303-1 303-2 303-3 304-1 304-2 304-3 304-5 305-1 305-2 305-3 305-6	2'-6" 2'-6" 2'-6" 3'-0" 2'-6" 3'-0" 2'-6" 3'-0" 2'-6" 3'-0" 2'-8" 3'-0" 2'-8" 3'-0" 2'-4" 3'-0"	6'-8" 6'-8"	DB D	PT P	-	FB F	PT P		H05 (H08 H07 H06 H08 H08 H07 H08 H08 H07 H08 H08 H07 H08 H08 H07 H08		3				
6. COORDINA		QUIREMENTS WITH OWNER	301-1 301-2 301-3 301-4 301-5 301-6 302-1 302-2 302-3 302-4 302-5 303-1 303-2 303-3 304-1 304-2 304-3 304-3 304-5 305-1 305-2 305-3 305-4 305-5 305-6 305-7 306-1 306-2 306-3	2'-6" 2'-6" 2'-6" 3'-0" 2'-6" 3'-0" 2'-6" 2'-6" 2'-6" 2'-6" 2'-6" 2'-6" 2'-6" 2'-6" 2'-6" 2'-6" 2'-6" 2'-6" 2'-6" 2'-6" 3'-0" 2'-6" 3'-0" 2'-8" 3'-0" 2'-8" 3'-0" 2'-8" 3'-0" 2'-8"	6'-8" 6'-8"	DB D	PT P	-	FB F	PT P	- - - - -	H05 (H06 H08 H07 H06 H08 H09 H05 H07 H08		3				
6. COORDINA		PUIREMENTS WITH OWNER	301-1 301-2 301-3 301-4 301-5 301-6 302-1 302-2 302-3 302-4 302-5 303-1 303-2 303-3 304-1 304-2 304-3 304-5 305-1 305-1 305-2 305-3 305-4 305-5 305-6 305-7 306-1 306-2	2'-6" 2'-6" 2'-6" 3'-0" 2'-6" 3'-0" 2'-6" 2'-6" 2'-6" 2'-6" 2'-6" 2'-6" 2'-6" 2'-6" 2'-6" 2'-6" 2'-6" 2'-6" 3'-0" 2'-6" 3'-0" 2'-8" 3'-0" 2'-8" 3'-0" 2'-8" 3'-0" 2'-8" 3'-0" 2'-8" 3'-0" 2'-8"	6'-8" 6'-8"	DB D	PT P	-	FB F	PT P	- - - - -	H05 (H08 H07 H06 H08 H09 H05 H07		3				

		DO	OR S	CHED	ULI	E							
		DOOR NO.		DOC	PR			1	FRAME		HDW	REM	1ARKS
			WIDTH	НЕІСНТ	TYPE	FINISH	GLAZ'G	TYPE	FINISH	GLAZ'G	TYPE	RATING	NOTES
		FOURTH	FLOOR			L						l	
	}	400-1	3'-0"	6'-8"	DA	FF		FA	FF	-	H04A	90 MIN	
$\overline{}$	` (400-2	3'-0"	6'-8"	DA	FF	-	FA	FF	-	H04	90 MIN	
	\	400-3	3'-0"	5'-0"	DA	FF	-	FA	FF	-	H04	20 MIN	
}	,	401-1	3'-0"	6'-8"	DA DA	FF	~~~	FA	FF		H05	20 MIN	
₹		401-2	2'-6"	6'-8"	DB	PT	-	FB	PT	-	H06		
<u>ر</u>		401-3	2'-6"	6'-8"	DB	PT	-	FB	PT	-	H08	-	3
		401-4	2'-8"	6'-8"	DB	PT	-	FB	PT	-	H07	-	
<u>~</u>	,	401-5	3'-0"	6'-8"	DB	PT	-	FB	PT	-	H06	-	
	}	401-6	2'-6"	6'-8"	DB	PT	-	FB	PT	-	H08	-	
∽		402-1	3'-0"	6'-8"	DA	FF	-	FA	FF	-	H05	20 MIN	
		402-2	2'-8"	6'-8"	DB	PT	-	FB	PT	-	H07	-	
		402-3	2'-6"	6'-8"	DB	PT	-	FB	PT	-	H08	-	3
		402-4	2'-6"	6'-8"	DB	PT	-	FB	PT	-	H06	-	
		402-5	2'-0"	6'-8"	DB	PT	-	FB	PT	-	H08		
		403-1	3'-0"	6'-8"	DA	FF	-	FA	FF	-	H05	20 MIN	
		403-2	2'-6"	6'-8"	DB	PT	-	FB	PT	-	H08		
		403-3	2'-8"	6'-8"	DB	PT	-	FB	PT	-	H07	-	
		403-4	2'-6"	6'-8"	DB	PT	-	FB	PT	-	H06		
		404-1	3'-0"	6'-8"	DA	FF	-	FA	FF	-	H05	20 MIN	
		404-2	2'-6"	6'-8"	DB	PT	-	FB	PT	-	H06	<u>.</u>	
		404-3	2'-6"	6'-8"	DB	PT	-	FB	PT	-	H08	-	3
		404-4	2'-8"	6'-8"	DB	PT	-	FB	PT	-	H07	-	
		404-5	3'-0"	6'-8"	DB	PT	-	FB	PT	-	H06	-	
		404-6	2'-6"	6'-8"	DB	PT	-	FB	PT	-	H08	-	
		FIFTH FL	OOR	•			•					l l	
		500-1	3'-0"	6'-8"	DA	FF	-	FA	FF	-	H04	90 MIN	

DOOR NOTES:

ERIOR DOORS TO BE THERMALLY BROKEN & INSULATED WITH WEATHER STRIPPING.

AZING IN DOOR LITES AN SIDE LITES TO BE SAFETY GLAZING.

OD DOORS AND TRIM ARE TO BE PAINTED. ALL METAL DOORS AND FRAMES ARE TO BE FINISHED. SEE FINISH SCHEDULES AND EXTERIOR COLORED ELEVATIONS FOR FINISH/COLOR

SIZE OF ALL EXG DOORS AND DOOR OPENINGS IN THE FIELD.


A HISTORIC TAX CREDIT PROJECT WITH SENSITIVE HISTORIC MATERIALS, INCLUDING DOORS. SEE EXG & BE REFERRED TO.

IDENTIAL UNIT ENTRY DOORS SHALL BE READILY OPENABLE FROM THE EGRESS SIDE WITHOUT THE USE OF SPECIAL KNOWLEDGE OR EFFORT.

ERIOR STAIRWAY MEANS OF EGRESS DOORS SHALL BE READILY OPENABLE FROM THE EGRESS SIDE WITHOUT OF A KEY OR SPECIAL KNOWLEDGE OR EFFORT.

OOR IS AN EXISTING DOOR. SALVAGE AND REINSTALL IN THIS LOCATION.

OOR IS TO BE UNDERCUT PER MECHANICAL REQUIREMENTS. SEE MEP DRAWINGS.

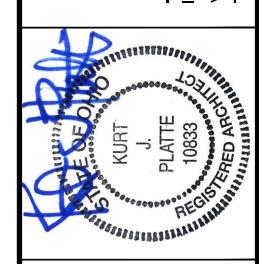



Progress Dates 08.15.2022 - BID SET

05.26.2022 - PERMIT REV I 06.15.2022 - PERMIT REV 2 08.19.2023 - ENG CHANGE I

Design Team: MR, TB, SO, MR Drawn by: TB, MR

Job No: 22005 02.25.2022

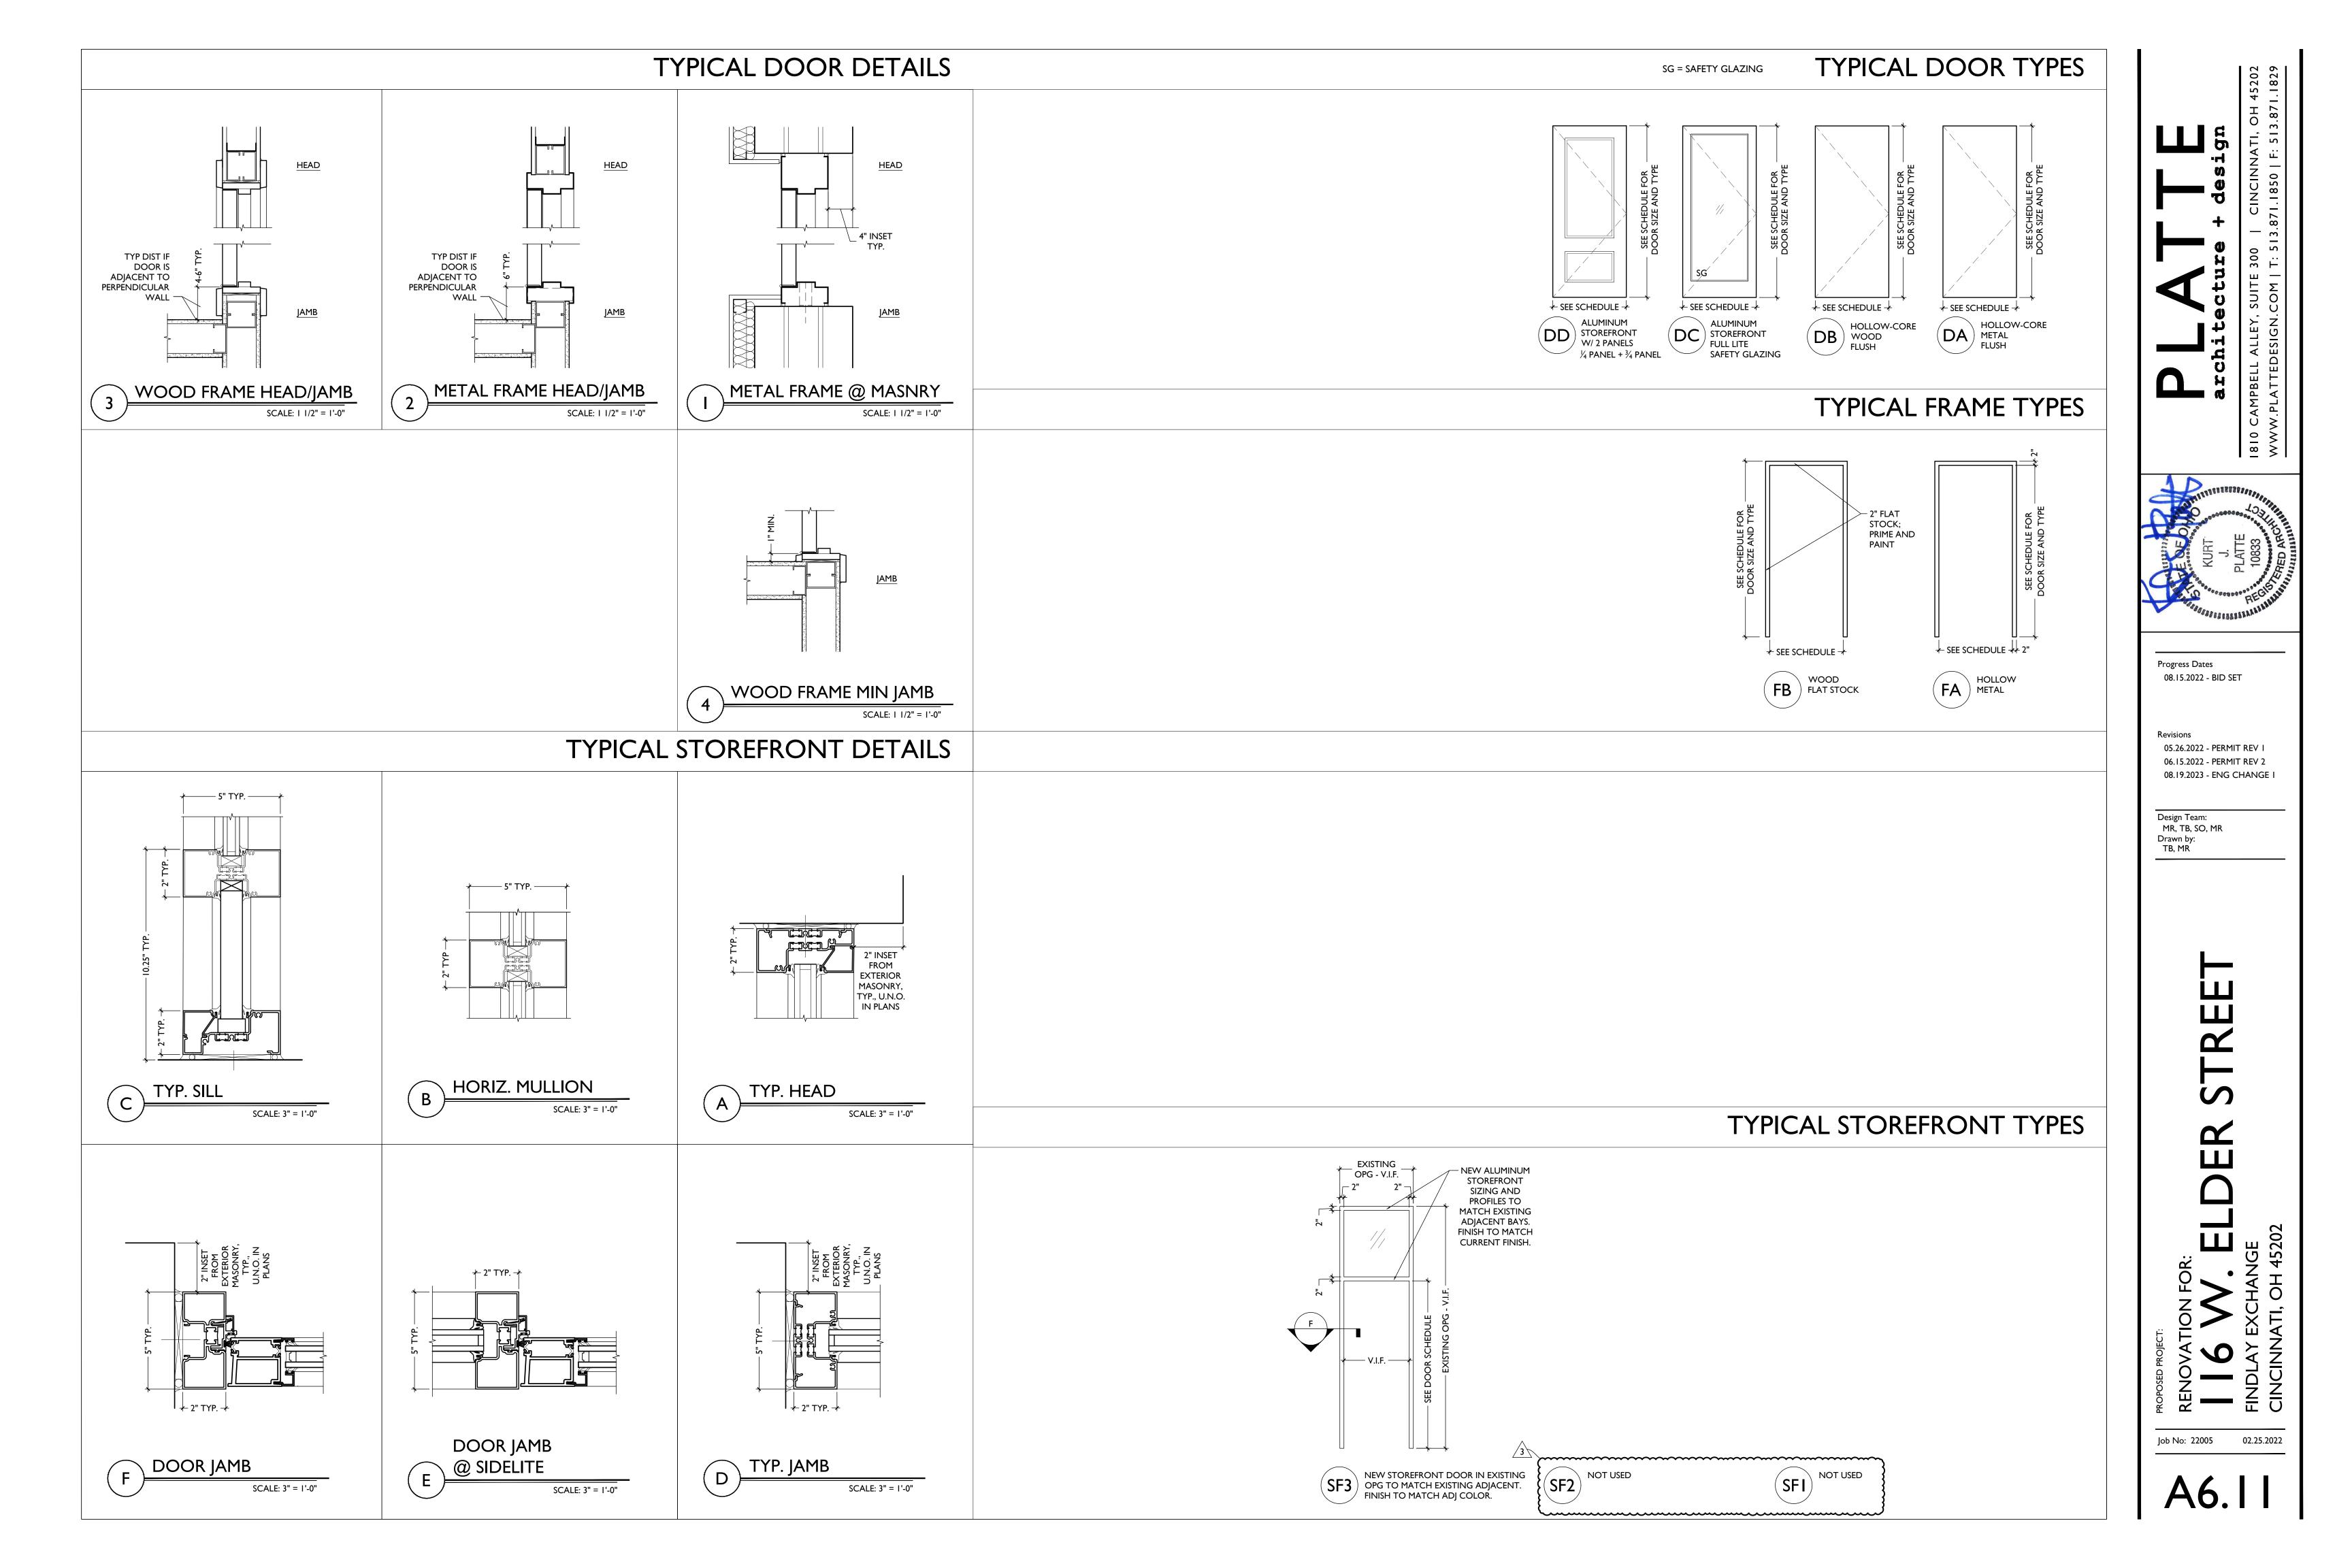

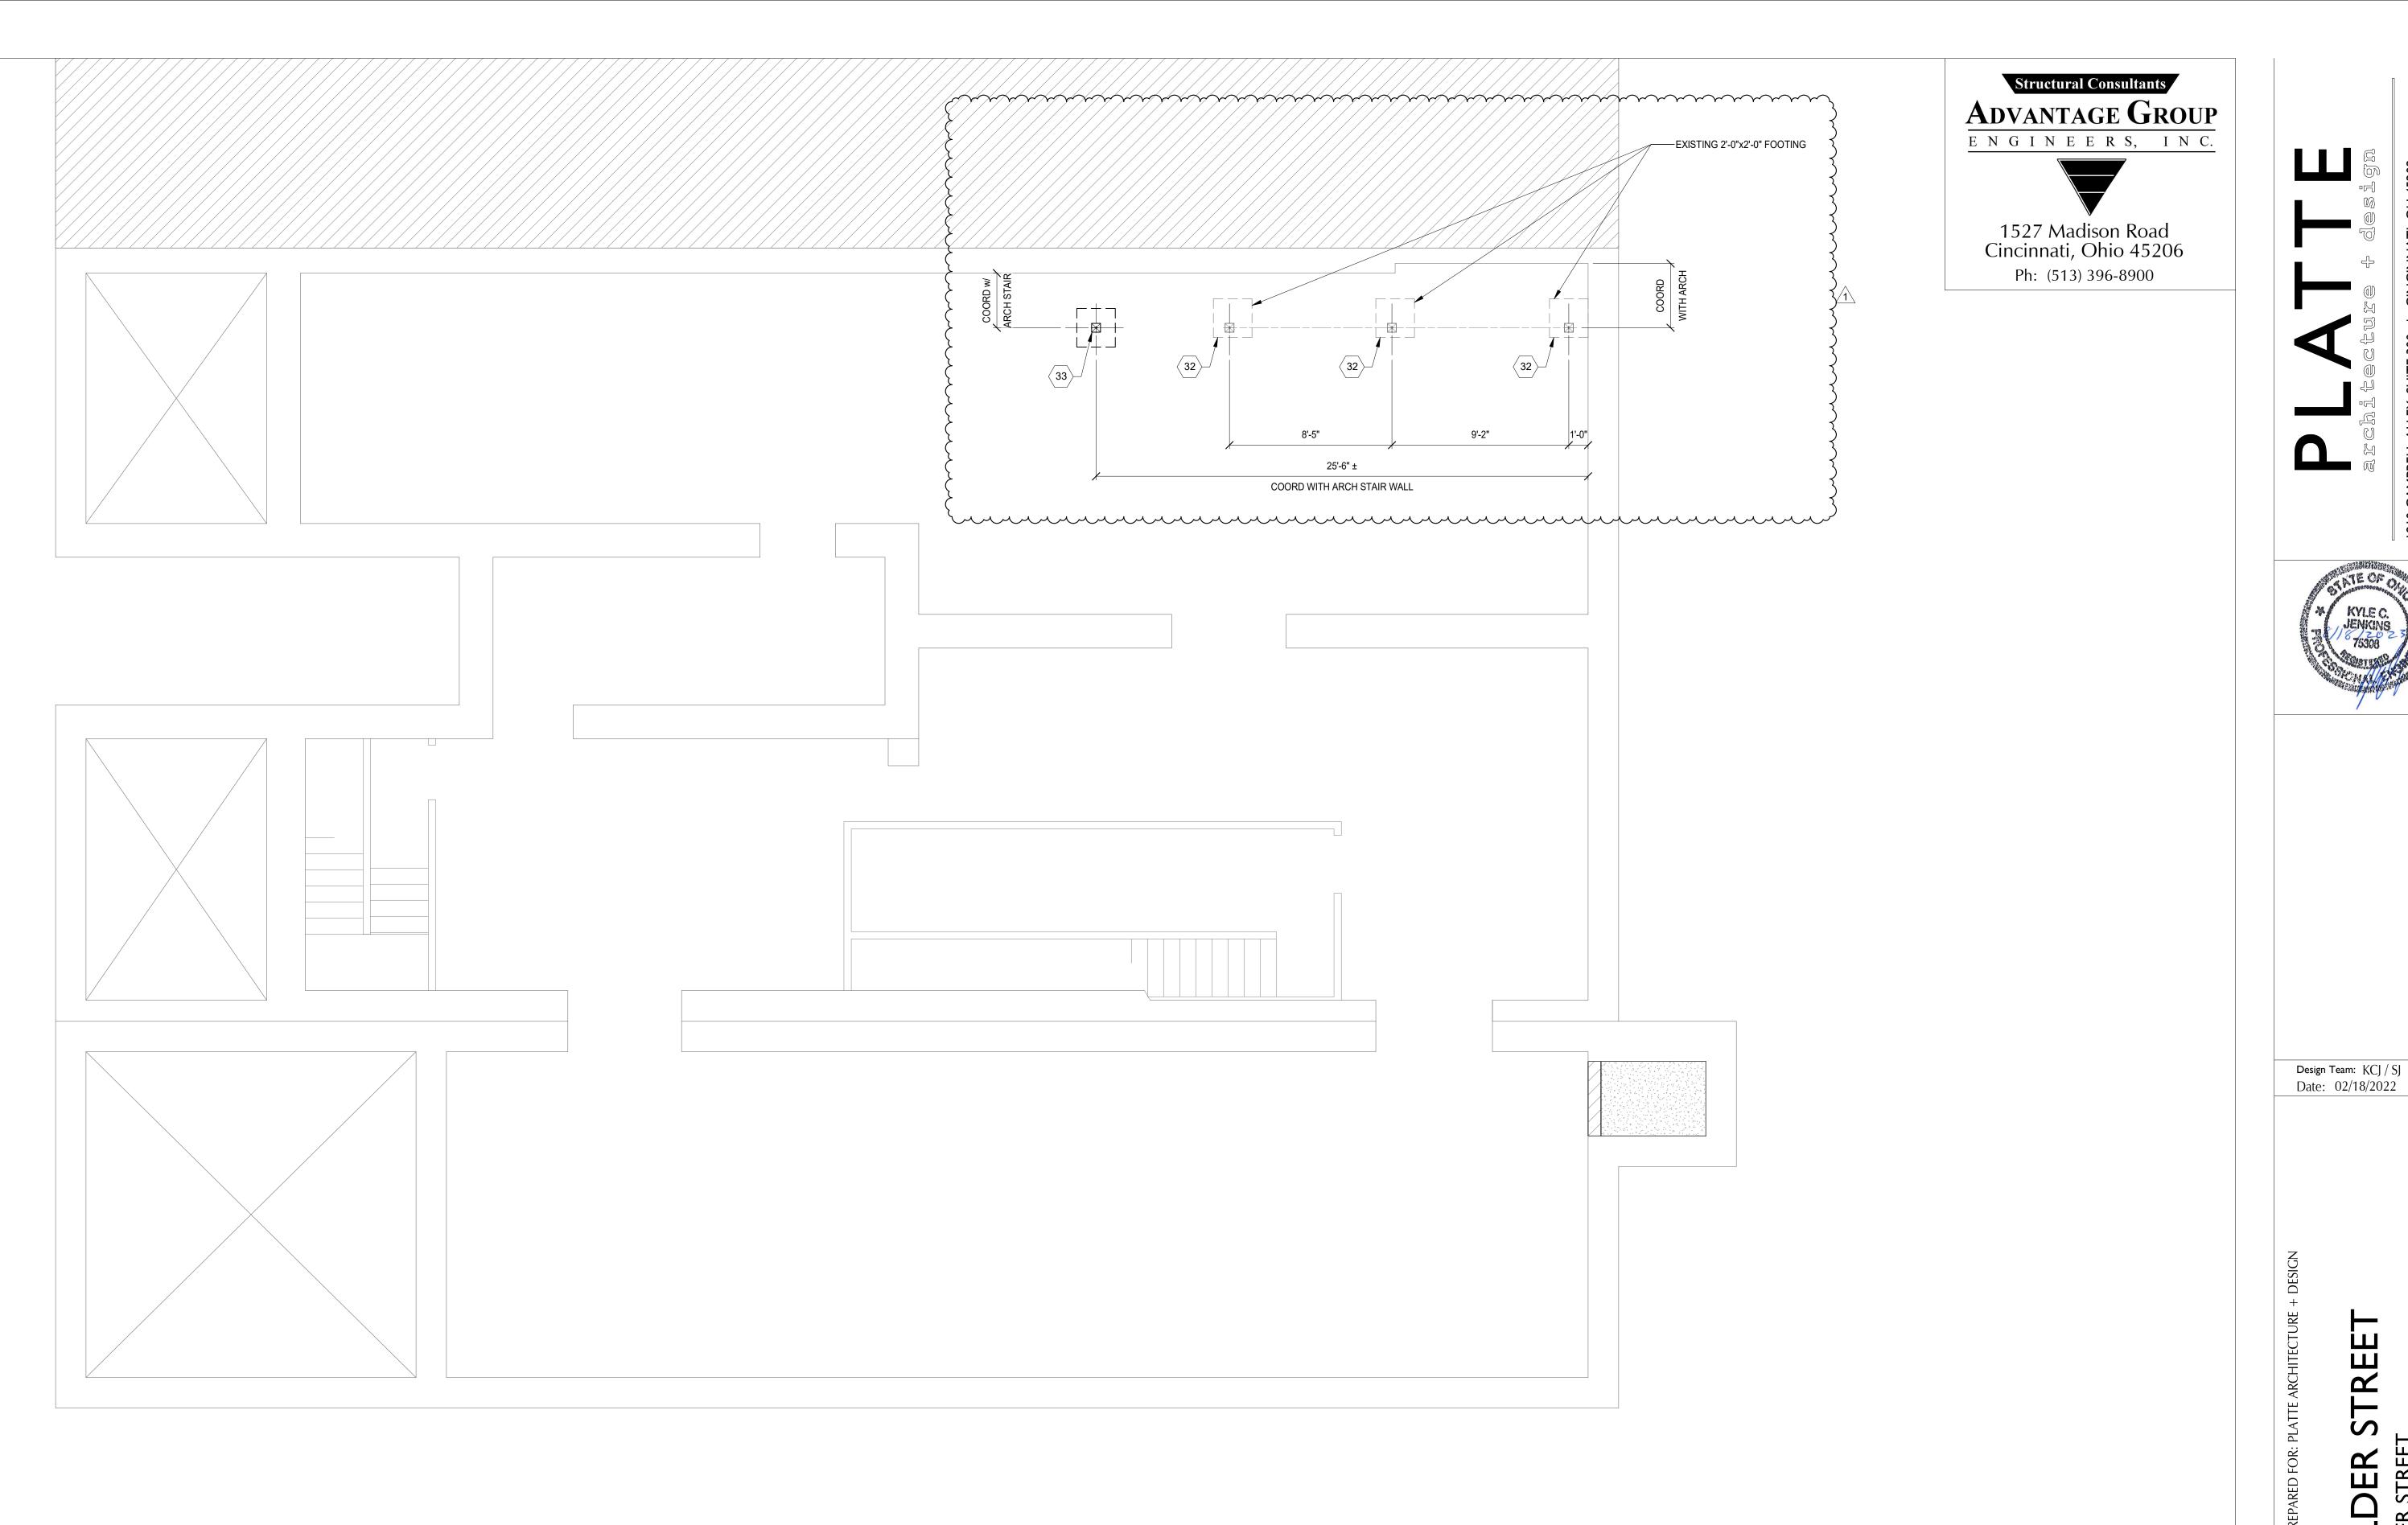


PLAN NOTES:

1. COORDINATE ALL DIMENSIONS, DOOR AND WINDOW LOCATIONS WITH ARCHITECTURAL DRAWINGS.




STRUCTURAL INFORMATION NOTED IS BASED ON ASSUMPTIONS OF CONDITION OF EXISTING FRAMING & FRAMING HIDDEN FROM VISUAL OBSERVATION. DETAILS OF PROPOSED FRAMING MODIFICATION/REPAIRS ARE SUBJECT TO CHANGE ONCE DEMOLITION IS UNDERWAY

Proj. No.: 22146.05 Drawing No.

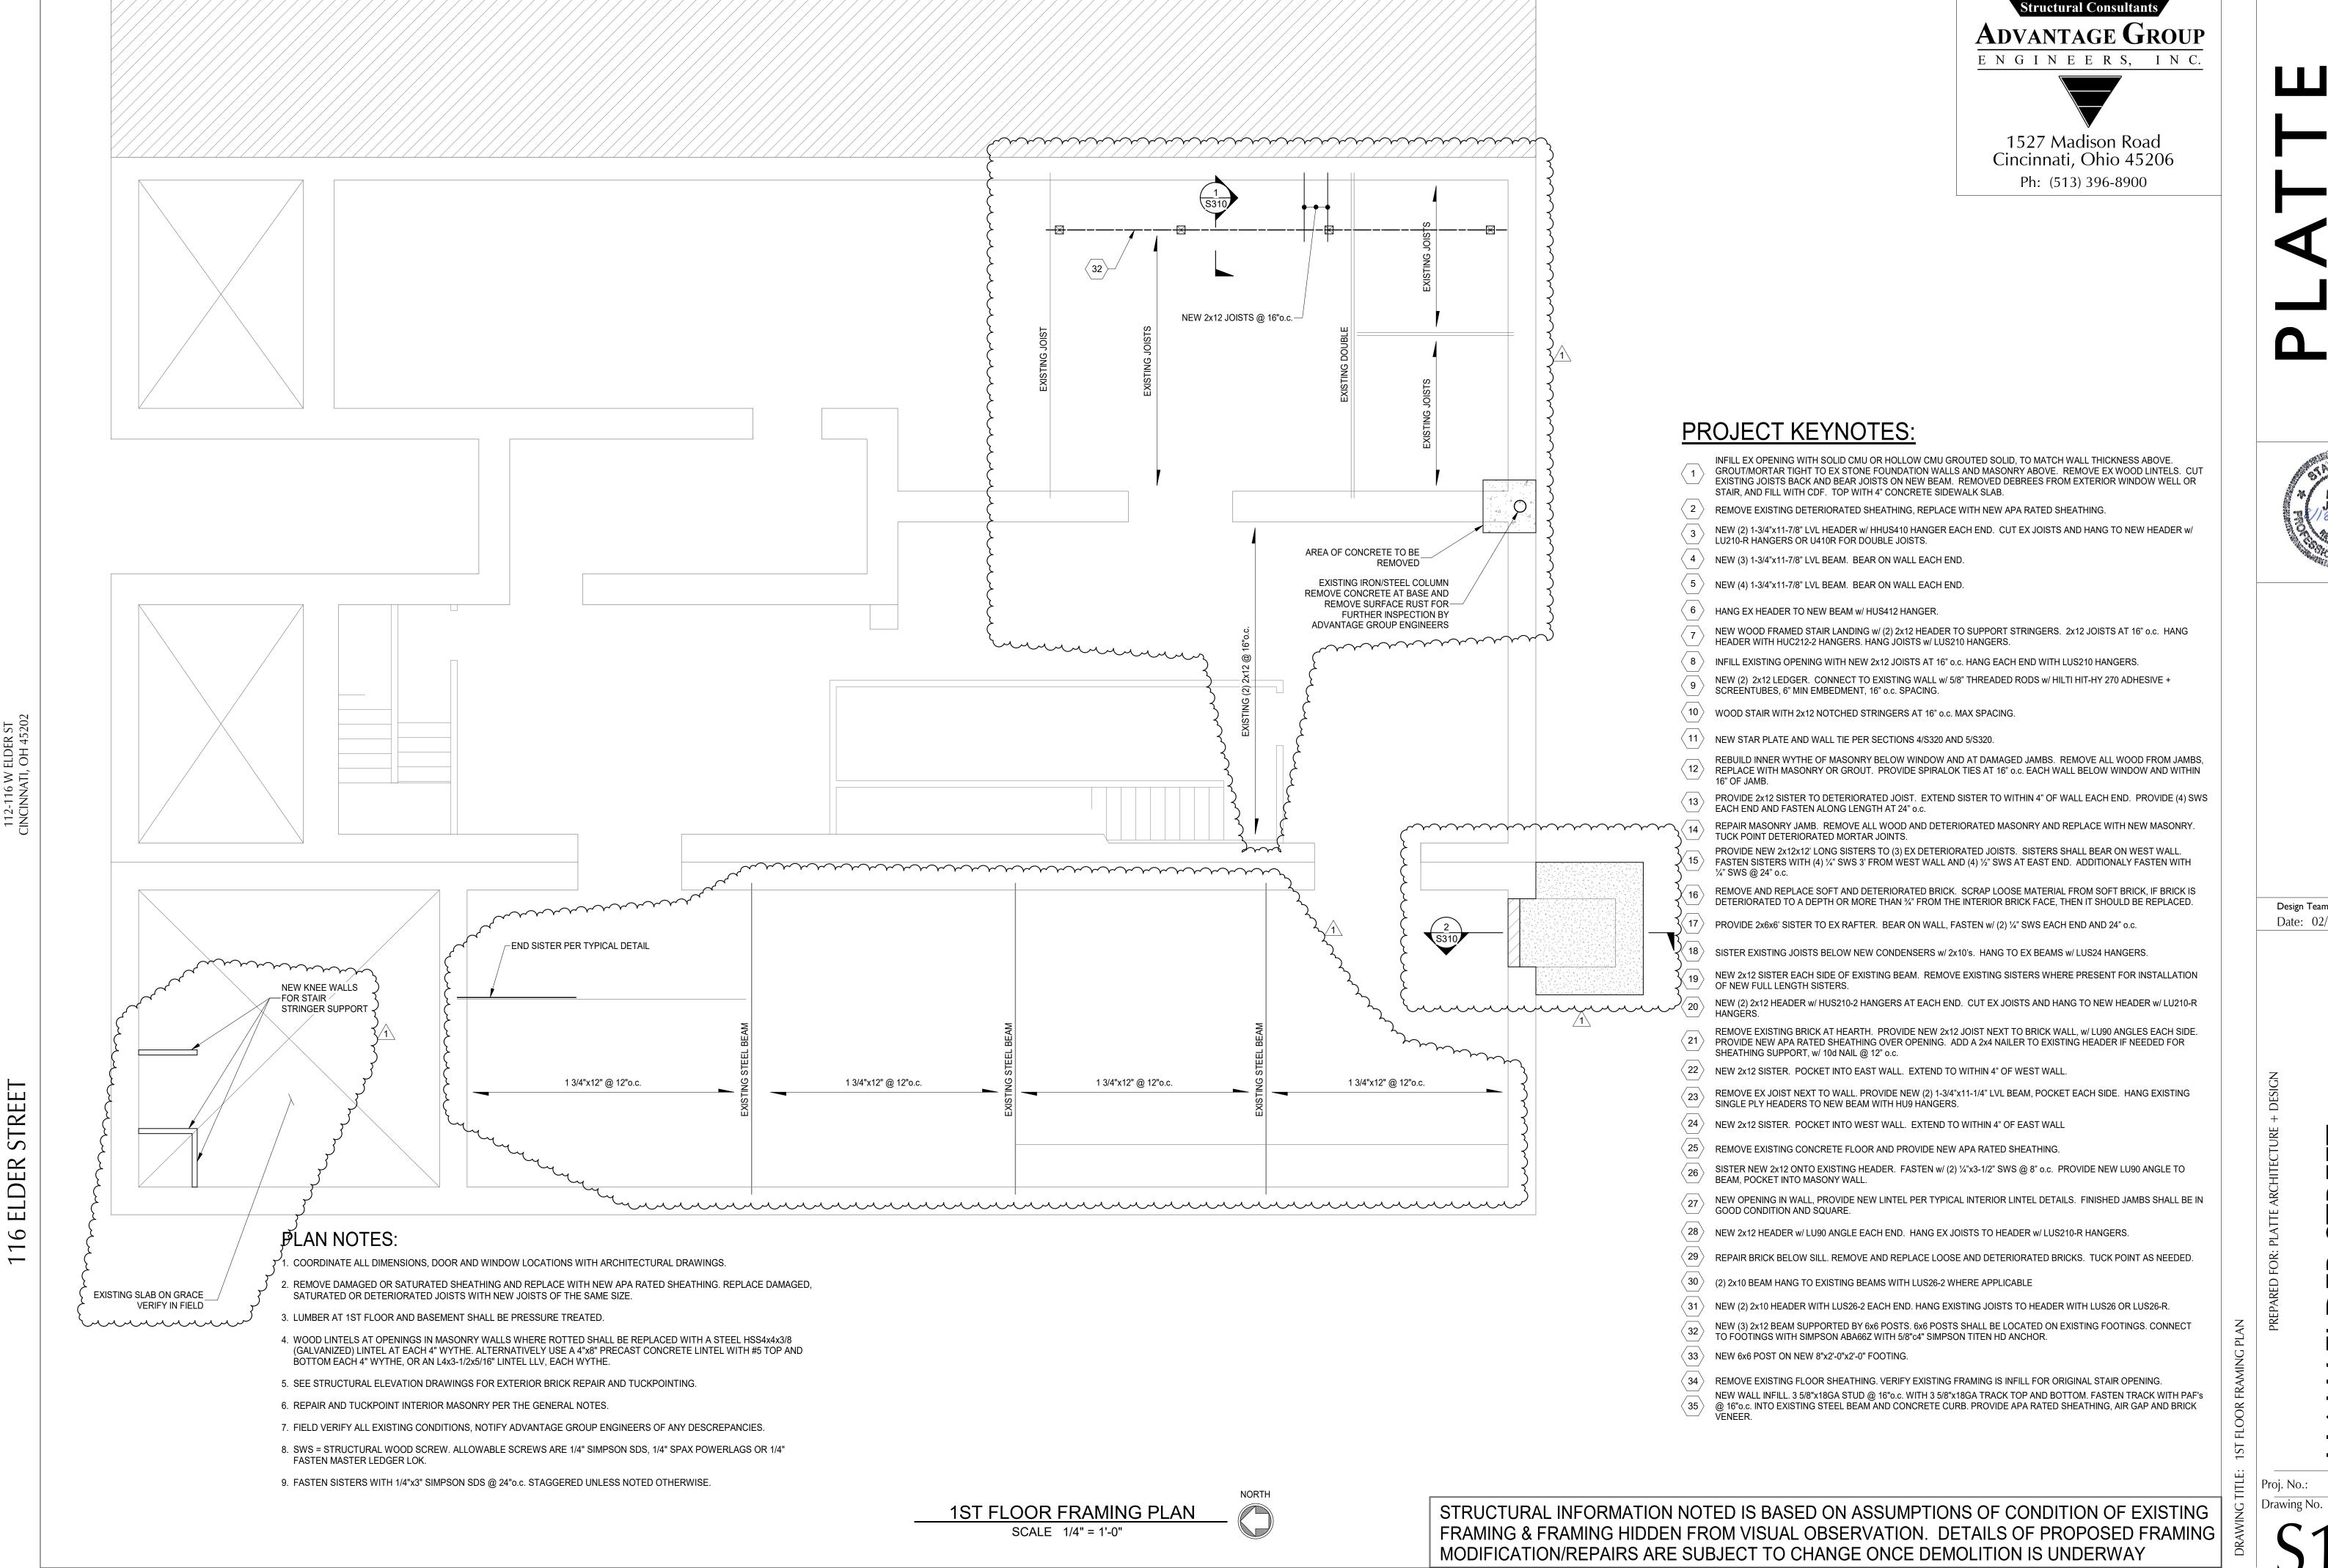


Design Team: KCJ / SJ Date: 02/18/2022

22146.05

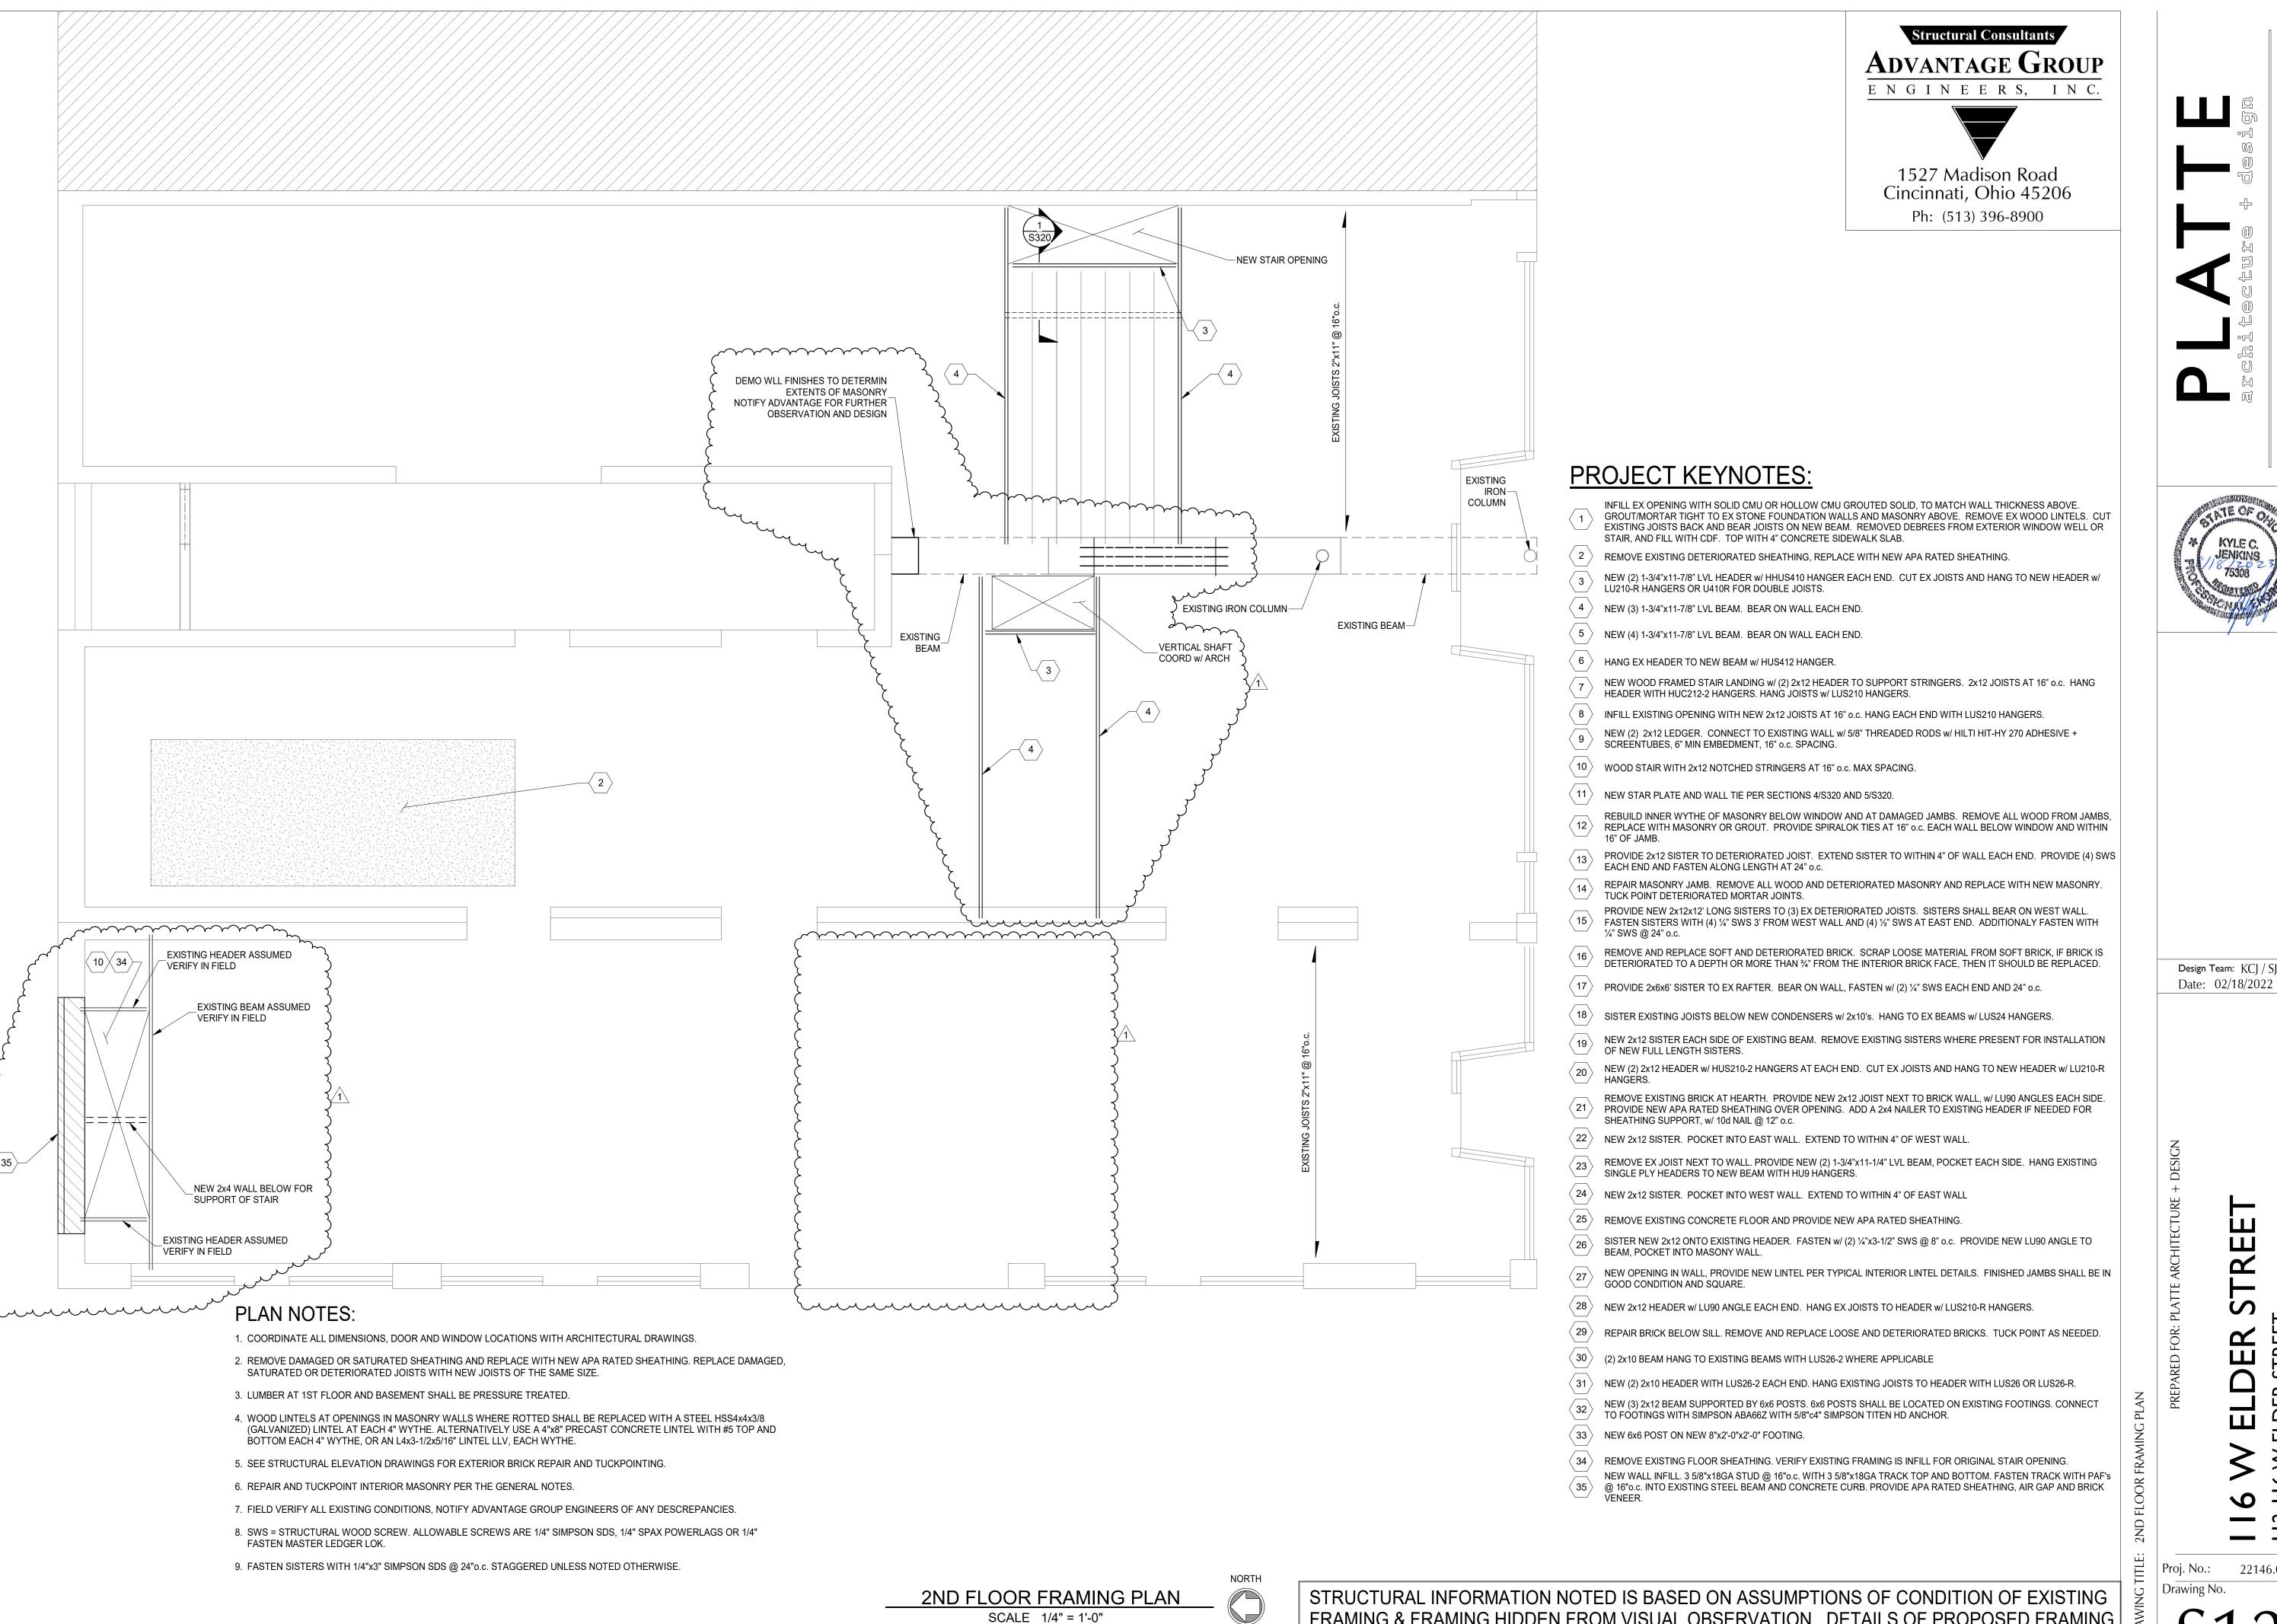

FRAMING & FRAMING HIDDEN FROM VISUAL OBSERVATION. DETAILS OF PROPOSED FRAMING MODIFICATION/REPAIRS ARE SUBJECT TO CHANGE ONCE DEMOLITION IS UNDERWAY


22146.05 Drawing No.

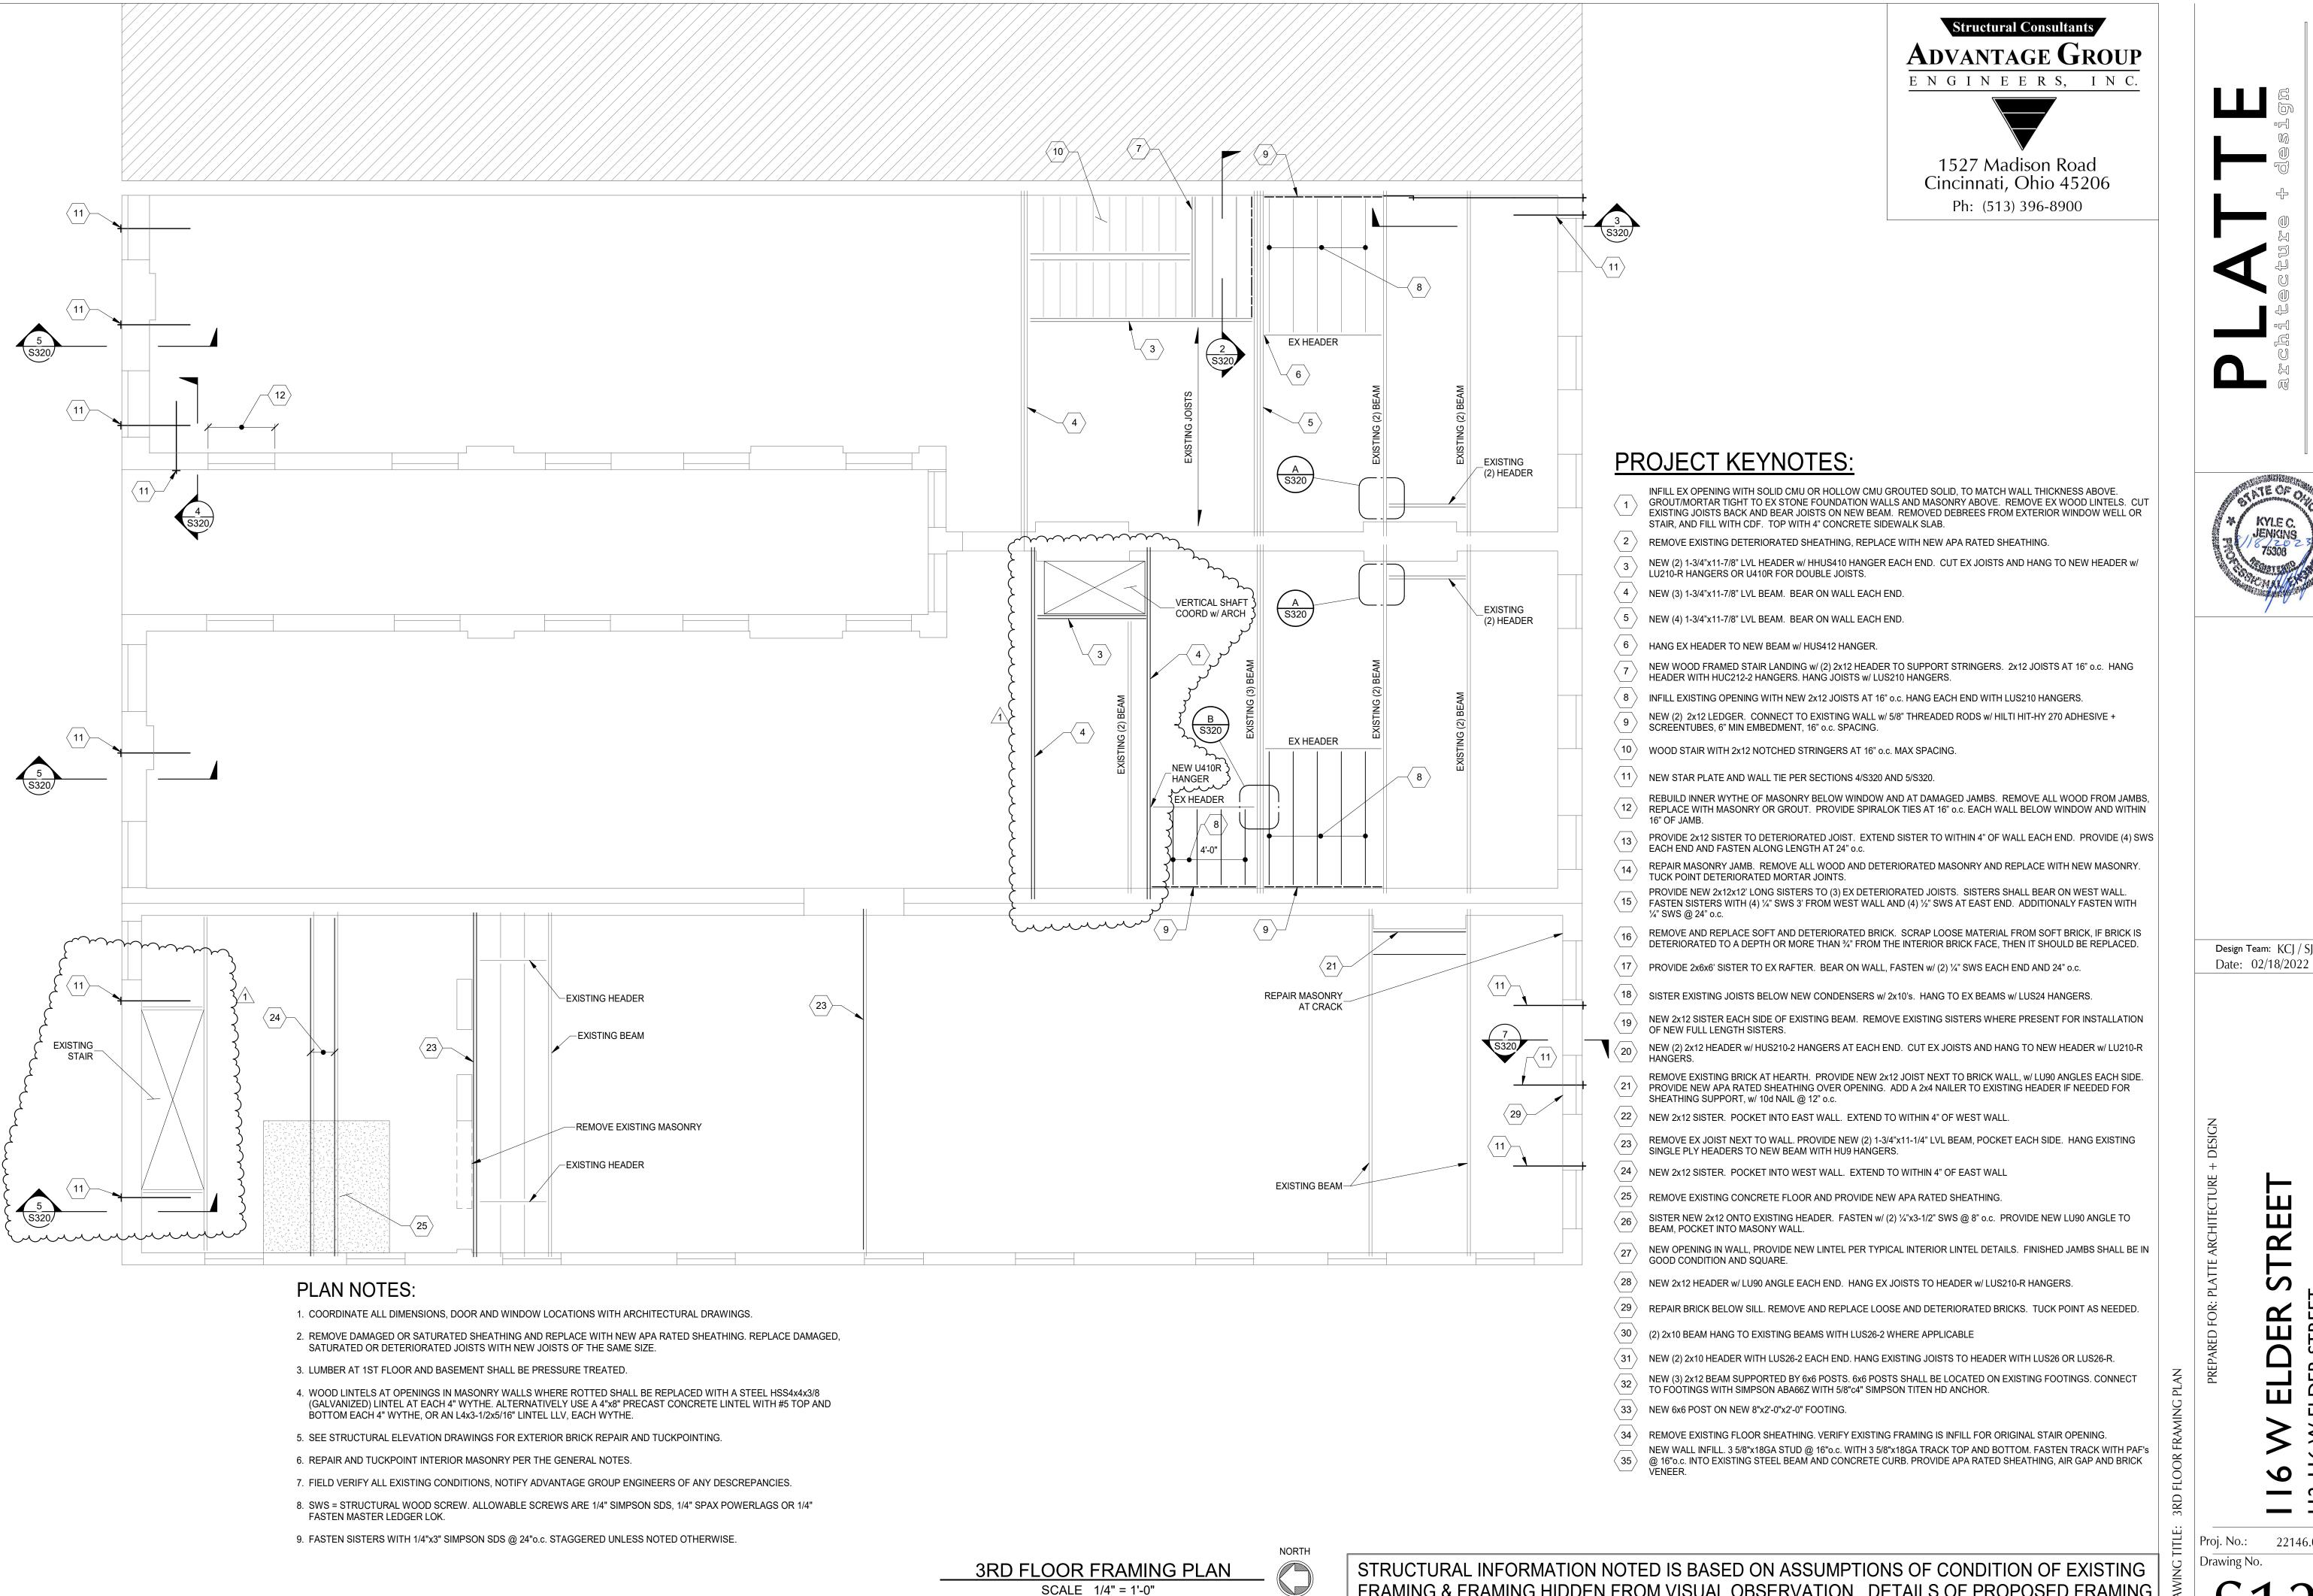

FRAMING & FRAMING HIDDEN FROM VISUAL OBSERVATION. DETAILS OF PROPOSED FRAMING MODIFICATION/REPAIRS ARE SUBJECT TO CHANGE ONCE DEMOLITION IS UNDERWAY

22146.05 Proj. No.: Drawing No.

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Design Team: KCJ / SJ

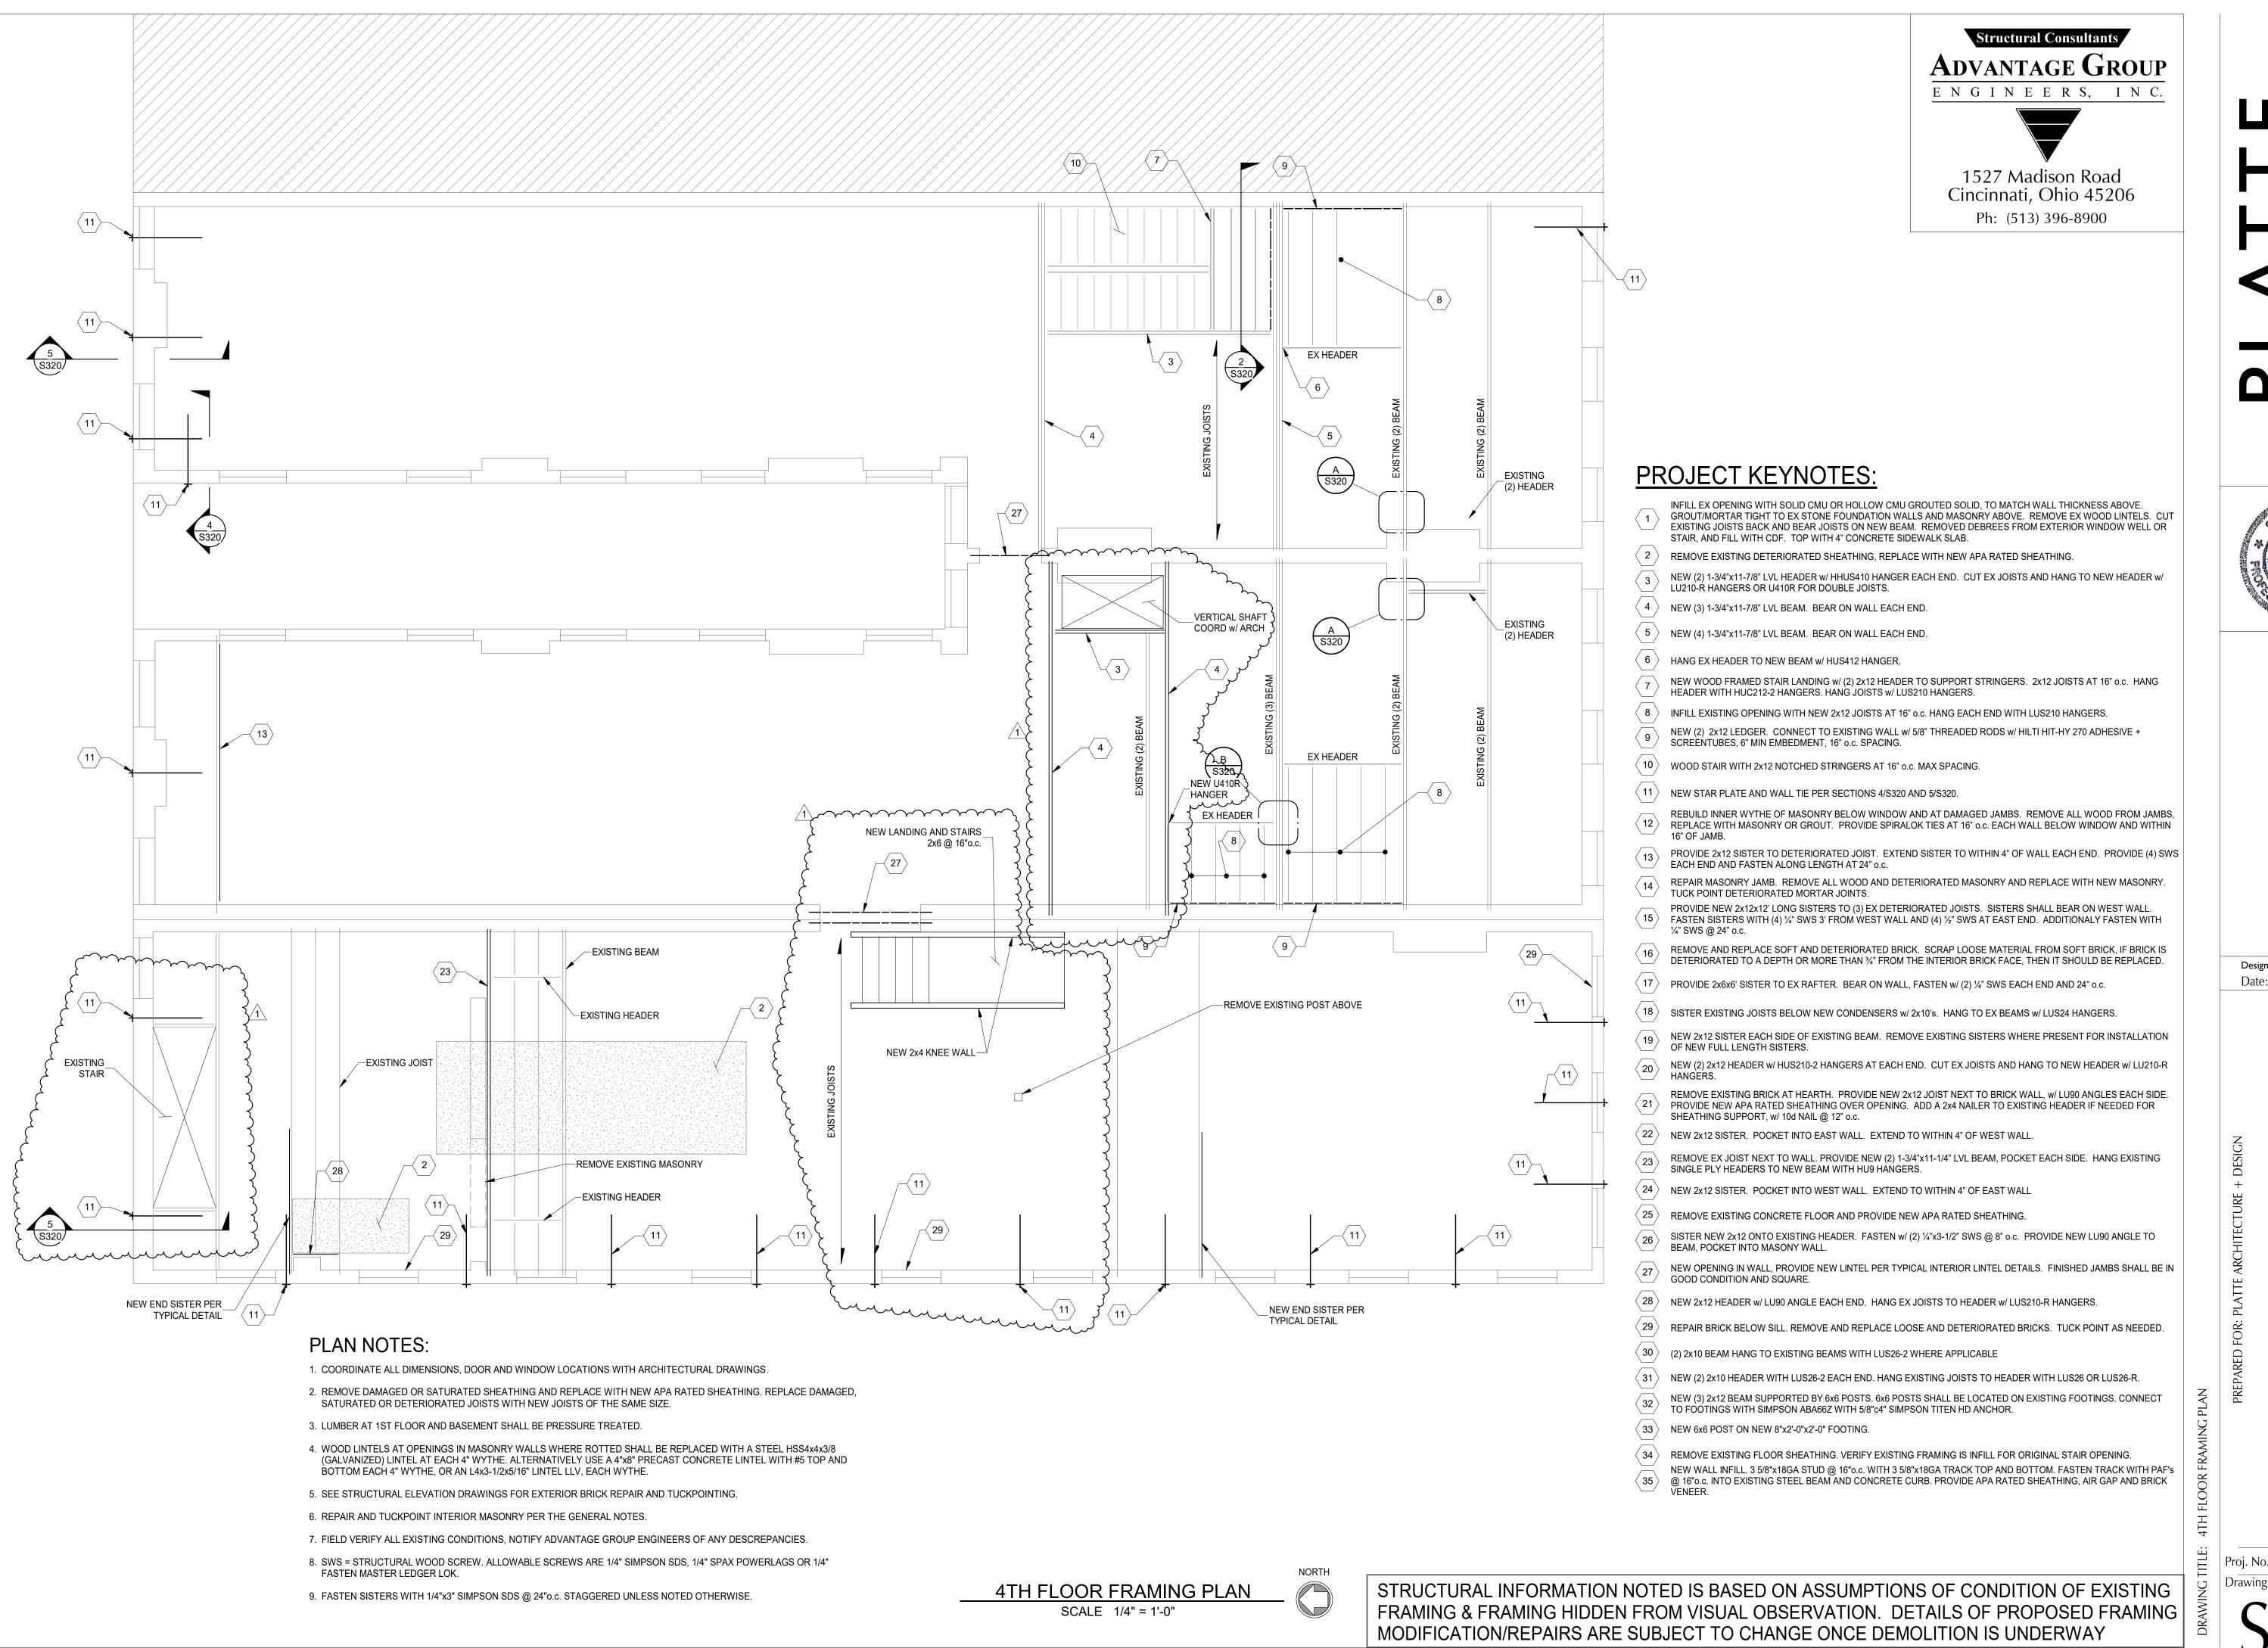Date: 02/18/2022

S

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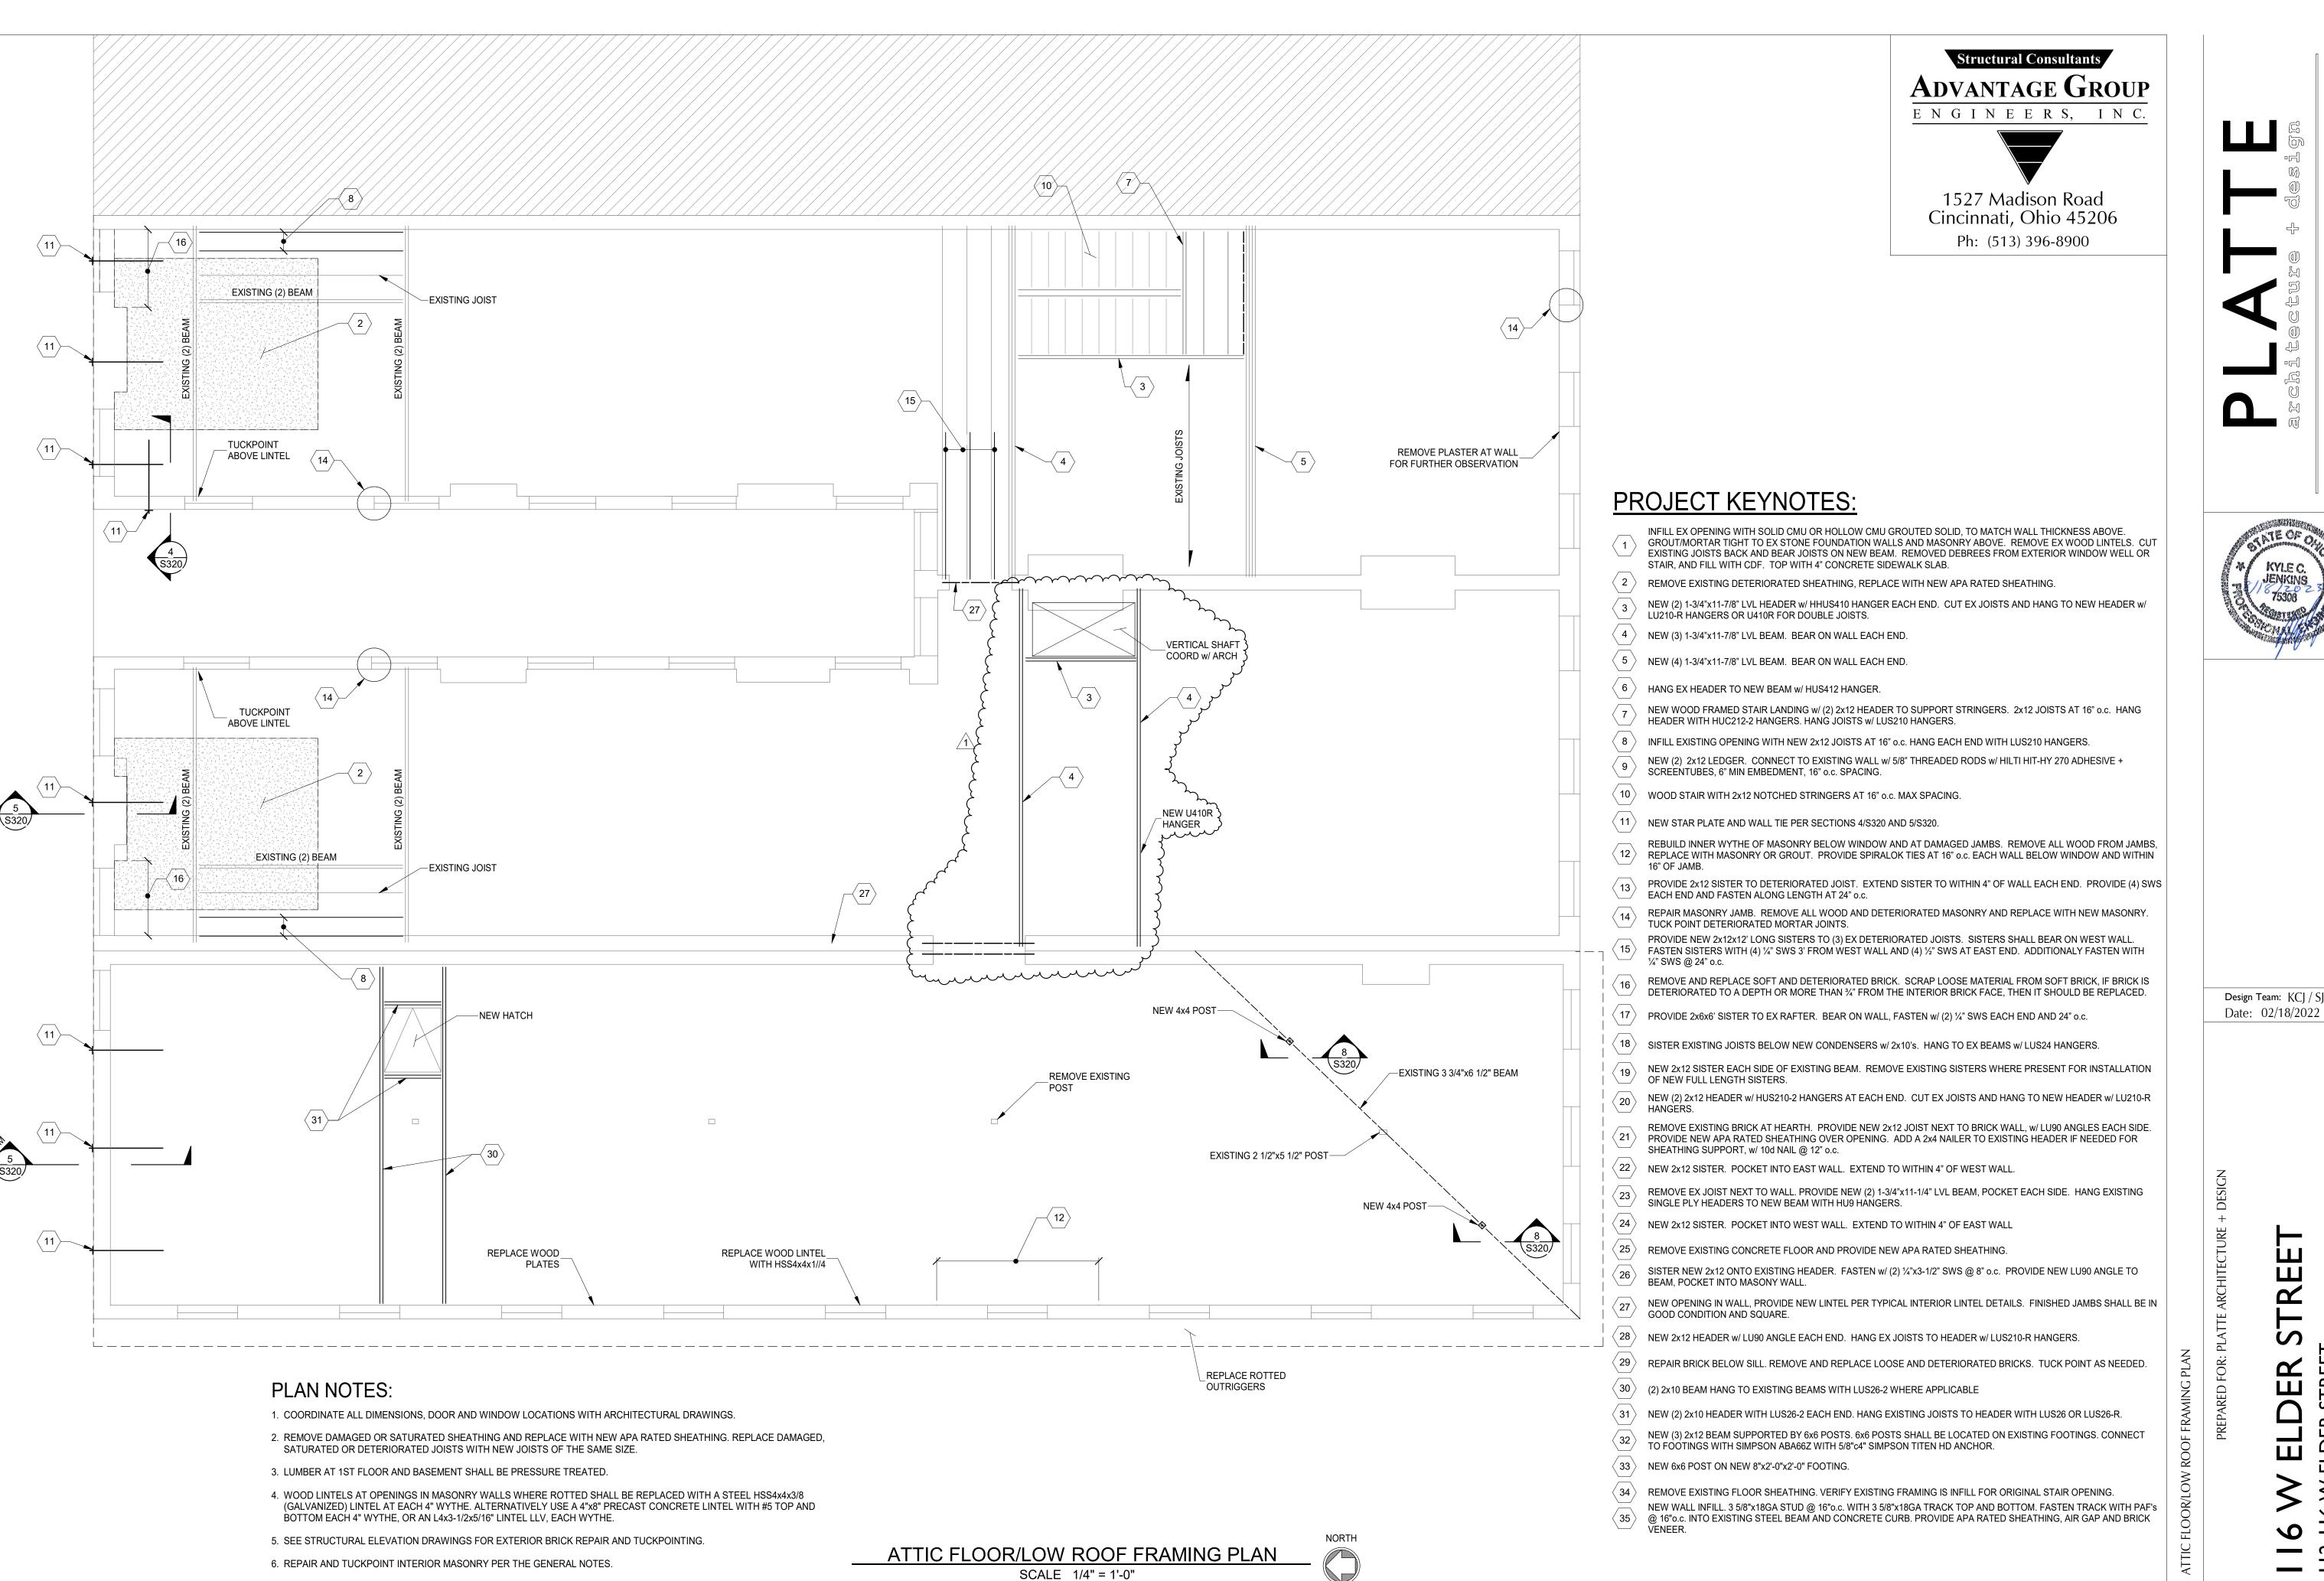
Drawing No.

7. FIELD VERIFY ALL EXISTING CONDITIONS, NOTIFY ADVANTAGE GROUP ENGINEERS OF ANY DESCREPANCIES.

9. FASTEN SISTERS WITH 1/4"x3" SIMPSON SDS @ 24"o.c. STAGGERED UNLESS NOTED OTHERWISE

FASTEN MASTER LEDGER LOK.

8. SWS = STRUCTURAL WOOD SCREW. ALLOWABLE SCREWS ARE 1/4" SIMPSON SDS, 1/4" SPAX POWERLAGS OR 1/4"




STRUCTURAL INFORMATION NOTED IS BASED ON ASSUMPTIONS OF CONDITION OF EXISTING MODIFICATION/REPAIRS ARE SUBJECT TO CHANGE ONCE DEMOLITION IS UNDERWAY

FRAMING & FRAMING HIDDEN FROM VISUAL OBSERVATION. DETAILS OF PROPOSED FRAMING

22146.05

Proj. No.: Drawing No.

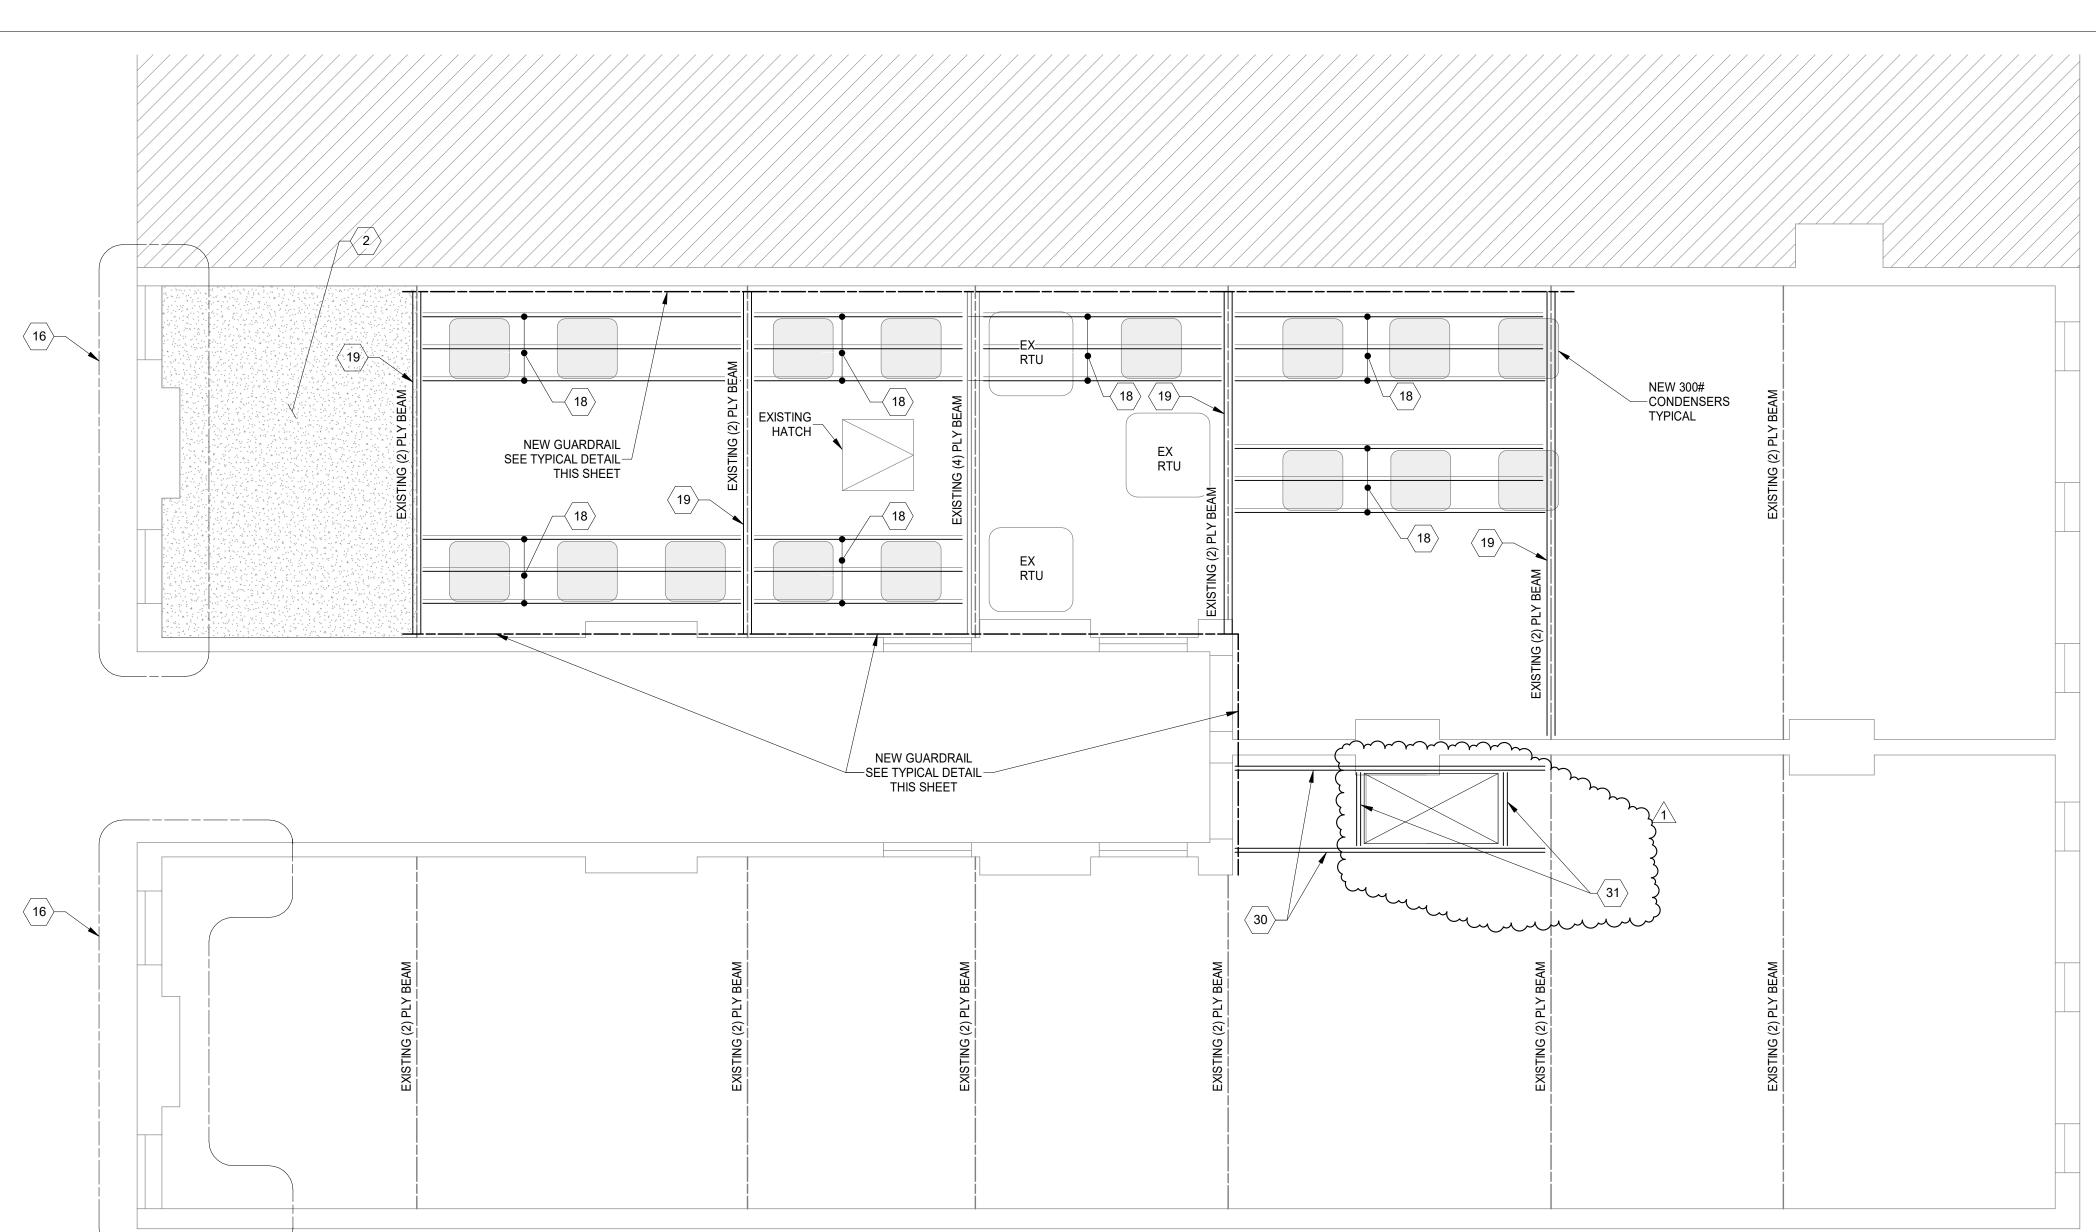

~1 1/2" STD PIPE @ 5'-0"o.c. MAX 2" STD PIPE SLEEVE WITH -(2) 1/4" SDS TO **EXISTING GUARDRAIL POST** SHEATHING -EXISTING JOIST SIMPSON ML24Z EACH END EXISTING BRICK EACH SIDE 1/4" PLATE WITH (4) 1/2"Ø THRU BOLTS (2) 2x8 BLOCKING -EXISTING JOIST

PLAN NOTES:

- COORDINATE ALL DIMENSIONS, DOOR AND WINDOW LOCATIONS WITH ARCHITECTURAL DRAWINGS.
- 2. REMOVE DAMAGED OR SATURATED SHEATHING AND REPLACE WITH NEW APA RATED SHEATHING. REPLACE DAMAGED, SATURATED OR DETERIORATED JOISTS WITH NEW JOISTS OF THE SAME SIZE.
- 3. LUMBER AT 1ST FLOOR AND BASEMENT SHALL BE PRESSURE TREATED.
- 4. WOOD LINTELS AT OPENINGS IN MASONRY WALLS WHERE ROTTED SHALL BE REPLACED WITH A STEEL HSS4x4x3/8 (GALVANIZED) LINTEL AT EACH 4" WYTHE. ALTERNATIVELY USE A 4"x8" PRECAST CONCRETE LINTEL WITH #5 TOP AND BOTTOM EACH 4" WYTHE, OR AN L4x3-1/2x5/16" LINTEL LLV, EACH WYTHE.
- 5. SEE STRUCTURAL ELEVATION DRAWINGS FOR EXTERIOR BRICK REPAIR AND TUCKPOINTING.
- 6. REPAIR AND TUCKPOINT INTERIOR MASONRY PER THE GENERAL NOTES.
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- 9. FASTEN SISTERS WITH 1/4"x3" SIMPSON SDS @ 24"o.c. STAGGERED UNLESS NOTED OTHERWISE

TYPICAL ROOF GUARDRAIL CONNECTION DETAIL SCALE 3/4" = 1'-0"



STRUCTURAL INFORMATION NOTED IS BASED ON ASSUMPTIONS OF CONDITION OF EXISTING FRAMING & FRAMING HIDDEN FROM VISUAL OBSERVATION. DETAILS OF PROPOSED FRAMING MODIFICATION/REPAIRS ARE SUBJECT TO CHANGE ONCE DEMOLITION IS UNDERWAY



PROJECT KEYNOTES:

- INFILL EX OPENING WITH SOLID CMU OR HOLLOW CMU GROUTED SOLID, TO MATCH WALL THICKNESS ABOVE. GROUT/MORTAR TIGHT TO EX STONE FOUNDATION WALLS AND MASONRY ABOVE. REMOVE EX WOOD LINTELS. CUT EXISTING JOISTS BACK AND BEAR JOISTS ON NEW BEAM. REMOVED DEBREES FROM EXTERIOR WINDOW WELL OR STAIR, AND FILL WITH CDF. TOP WITH 4" CONCRETE SIDEWALK SLAB.
- REMOVE EXISTING DETERIORATED SHEATHING, REPLACE WITH NEW APA RATED SHEATHING.
- NEW (2) 1-3/4"x11-7/8" LVL HEADER w/ HHUS410 HANGER EACH END. CUT EX JOISTS AND HANG TO NEW HEADER w/ LU210-R HANGERS OR U410R FOR DOUBLE JOISTS.
- \langle 4 \rangle NEW (3) 1-3/4"x11-7/8" LVL BEAM. BEAR ON WALL EACH END.
- \langle 5 angle NEW (4) 1-3/4"x11-7/8" LVL BEAM. BEAR ON WALL EACH END.
- \langle 6 angle HANG EX HEADER TO NEW BEAM w/ HUS412 HANGER.
- NEW WOOD FRAMED STAIR LANDING w/ (2) 2x12 HEADER TO SUPPORT STRINGERS. 2x12 JOISTS AT 16" o.c. HANG HEADER WITH HUC212-2 HANGERS. HANG JOISTS w/ LUS210 HANGERS.
- \langle 8 angle INFILL EXISTING OPENING WITH NEW 2x12 JOISTS AT 16" o.c. HANG EACH END WITH LUS210 HANGERS.
- NEW (2) 2x12 LEDGER. CONNECT TO EXISTING WALL w/ 5/8" THREADED RODS w/ HILTI HIT-HY 270 ADHESIVE + SCREENTUBES, 6" MIN EMBEDMENT, 16" o.c. SPACING.
- \langle 10 \rangle WOOD STAIR WITH 2x12 NOTCHED STRINGERS AT 16" o.c. MAX SPACING.
- NEW STAR PLATE AND WALL TIE PER SECTIONS 4/S320 AND 5/S320.
- REBUILD INNER WYTHE OF MASONRY BELOW WINDOW AND AT DAMAGED JAMBS. REMOVE ALL WOOD FROM JAMBS, REPLACE WITH MASONRY OR GROUT. PROVIDE SPIRALOK TIES AT 16" o.c. EACH WALL BELOW WINDOW AND WITHIN
- PROVIDE 2x12 SISTER TO DETERIORATED JOIST. EXTEND SISTER TO WITHIN 4" OF WALL EACH END. PROVIDE (4) SWS
- REPAIR MASONRY JAMB. REMOVE ALL WOOD AND DETERIORATED MASONRY AND REPLACE WITH NEW MASONRY. TUCK POINT DETERIORATED MORTAR JOINTS. PROVIDE NEW 2x12x12' LONG SISTERS TO (3) EX DETERIORATED JOISTS. SISTERS SHALL BEAR ON WEST WALL.
- FASTEN SISTERS WITH (4) 1/4" SWS 3' FROM WEST WALL AND (4) 1/2" SWS AT EAST END. ADDITIONALY FASTEN WITH REMOVE AND REPLACE SOFT AND DETERIORATED BRICK. SCRAP LOOSE MATERIAL FROM SOFT BRICK, IF BRICK IS
- DETERIORATED TO A DEPTH OR MORE THAN 3/4" FROM THE INTERIOR BRICK FACE, THEN IT SHOULD BE REPLACED.
- PROVIDE 2x6x6' SISTER TO EX RAFTER. BEAR ON WALL, FASTEN w/ (2) 1/4" SWS EACH END AND 24" o.c.
- (18) SISTER EXISTING JOISTS BELOW NEW CONDENSERS w/ 2x10's. HANG TO EX BEAMS w/ LUS24 HANGERS. NEW 2x12 SISTER EACH SIDE OF EXISTING BEAM. REMOVE EXISTING SISTERS WHERE PRESENT FOR INSTALLATION
- OF NEW FULL LENGTH SISTERS. NEW (2) 2x12 HEADER w/ HUS210-2 HANGERS AT EACH END. CUT EX JOISTS AND HANG TO NEW HEADER w/ LU210-R
- REMOVE EXISTING BRICK AT HEARTH. PROVIDE NEW 2x12 JOIST NEXT TO BRICK WALL, w/ LU90 ANGLES EACH SIDE. PROVIDE NEW APA RATED SHEATHING OVER OPENING. ADD A 2x4 NAILER TO EXISTING HEADER IF NEEDED FOR
- SHEATHING SUPPORT, w/ 10d NAIL @ 12" o.c. NEW 2x12 SISTER. POCKET INTO EAST WALL. EXTEND TO WITHIN 4" OF WEST WALL.
- REMOVE EX JOIST NEXT TO WALL. PROVIDE NEW (2) 1-3/4"x11-1/4" LVL BEAM, POCKET EACH SIDE. HANG EXISTING SINGLE PLY HEADERS TO NEW BEAM WITH HU9 HANGERS.
- NEW 2x12 SISTER. POCKET INTO WEST WALL. EXTEND TO WITHIN 4" OF EAST WALL
- REMOVE EXISTING CONCRETE FLOOR AND PROVIDE NEW APA RATED SHEATHING.
- SISTER NEW 2x12 ONTO EXISTING HEADER. FASTEN w/ (2) 1/4"x3-1/2" SWS @ 8" o.c. PROVIDE NEW LU90 ANGLE TO BEAM, POCKET INTO MASONY WALL.
- NEW OPENING IN WALL, PROVIDE NEW LINTEL PER TYPICAL INTERIOR LINTEL DETAILS. FINISHED JAMBS SHALL BE IN
- GOOD CONDITION AND SQUARE.
- NEW 2x12 HEADER w/ LU90 ANGLE EACH END. HANG EX JOISTS TO HEADER w/ LUS210-R HANGERS.
- REPAIR BRICK BELOW SILL. REMOVE AND REPLACE LOOSE AND DETERIORATED BRICKS. TUCK POINT AS NEEDED.
- \langle 30 \rangle (2) 2x10 BEAM HANG TO EXISTING BEAMS WITH LUS26-2 WHERE APPLICABLE
- NEW (2) 2x10 HEADER WITH LUS26-2 EACH END. HANG EXISTING JOISTS TO HEADER WITH LUS26 OR LUS26-R. NEW (3) 2x12 BEAM SUPPORTED BY 6x6 POSTS. 6x6 POSTS SHALL BE LOCATED ON EXISTING FOOTINGS. CONNECT
- TO FOOTINGS WITH SIMPSON ABA66Z WITH 5/8"c4" SIMPSON TITEN HD ANCHOR. NEW 6x6 POST ON NEW 8"x2'-0"x2'-0" FOOTING
- REMOVE EXISTING FLOOR SHEATHING. VERIFY EXISTING FRAMING IS INFILL FOR ORIGINAL STAIR OPENING.
- NEW WALL INFILL. 3 5/8"x18GA STUD @ 16"o.c. WITH 3 5/8"x18GA TRACK TOP AND BOTTOM. FASTEN TRACK WITH PAF's @ 16"o.c. INTO EXISTING STEEL BEAM AND CONCRETE CURB. PROVIDE APA RATED SHEATHING, AIR GAP AND BRICK

Proj. No.:

Drawing No.

Design Team: KCJ / SJ Date: 02/18/2022


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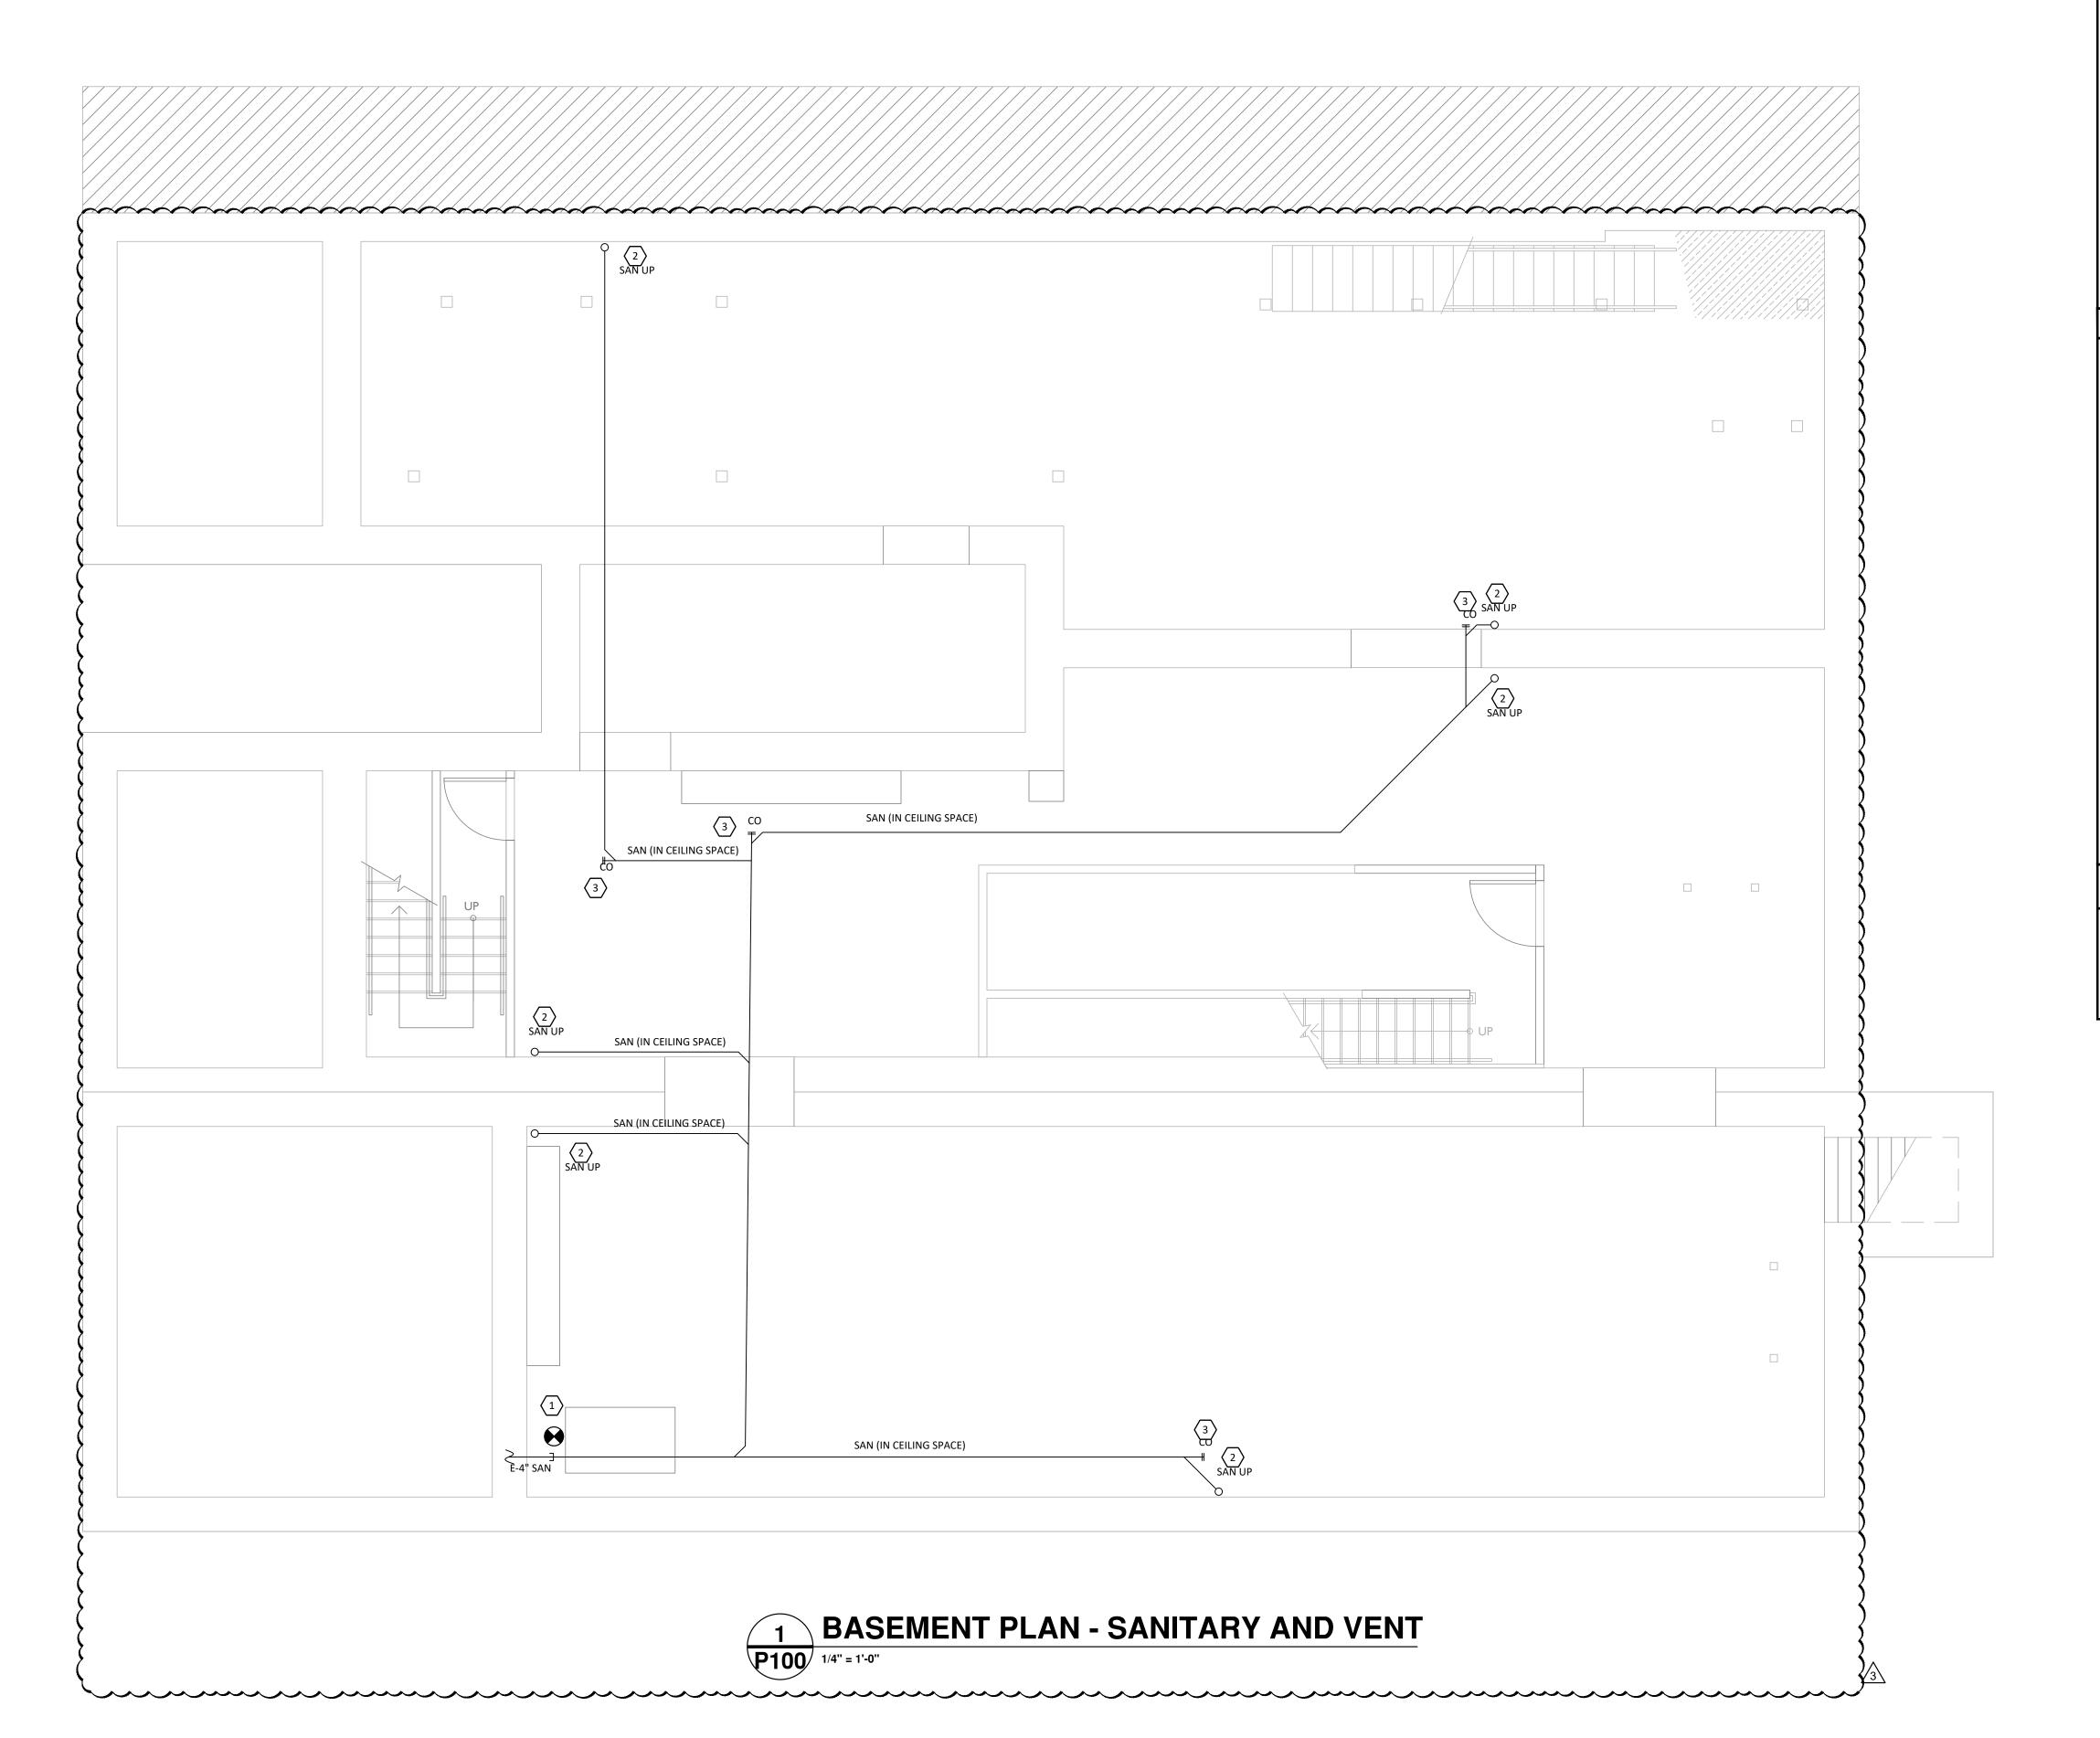






Design Team: KCJ / SJ Date: 02/18/2022



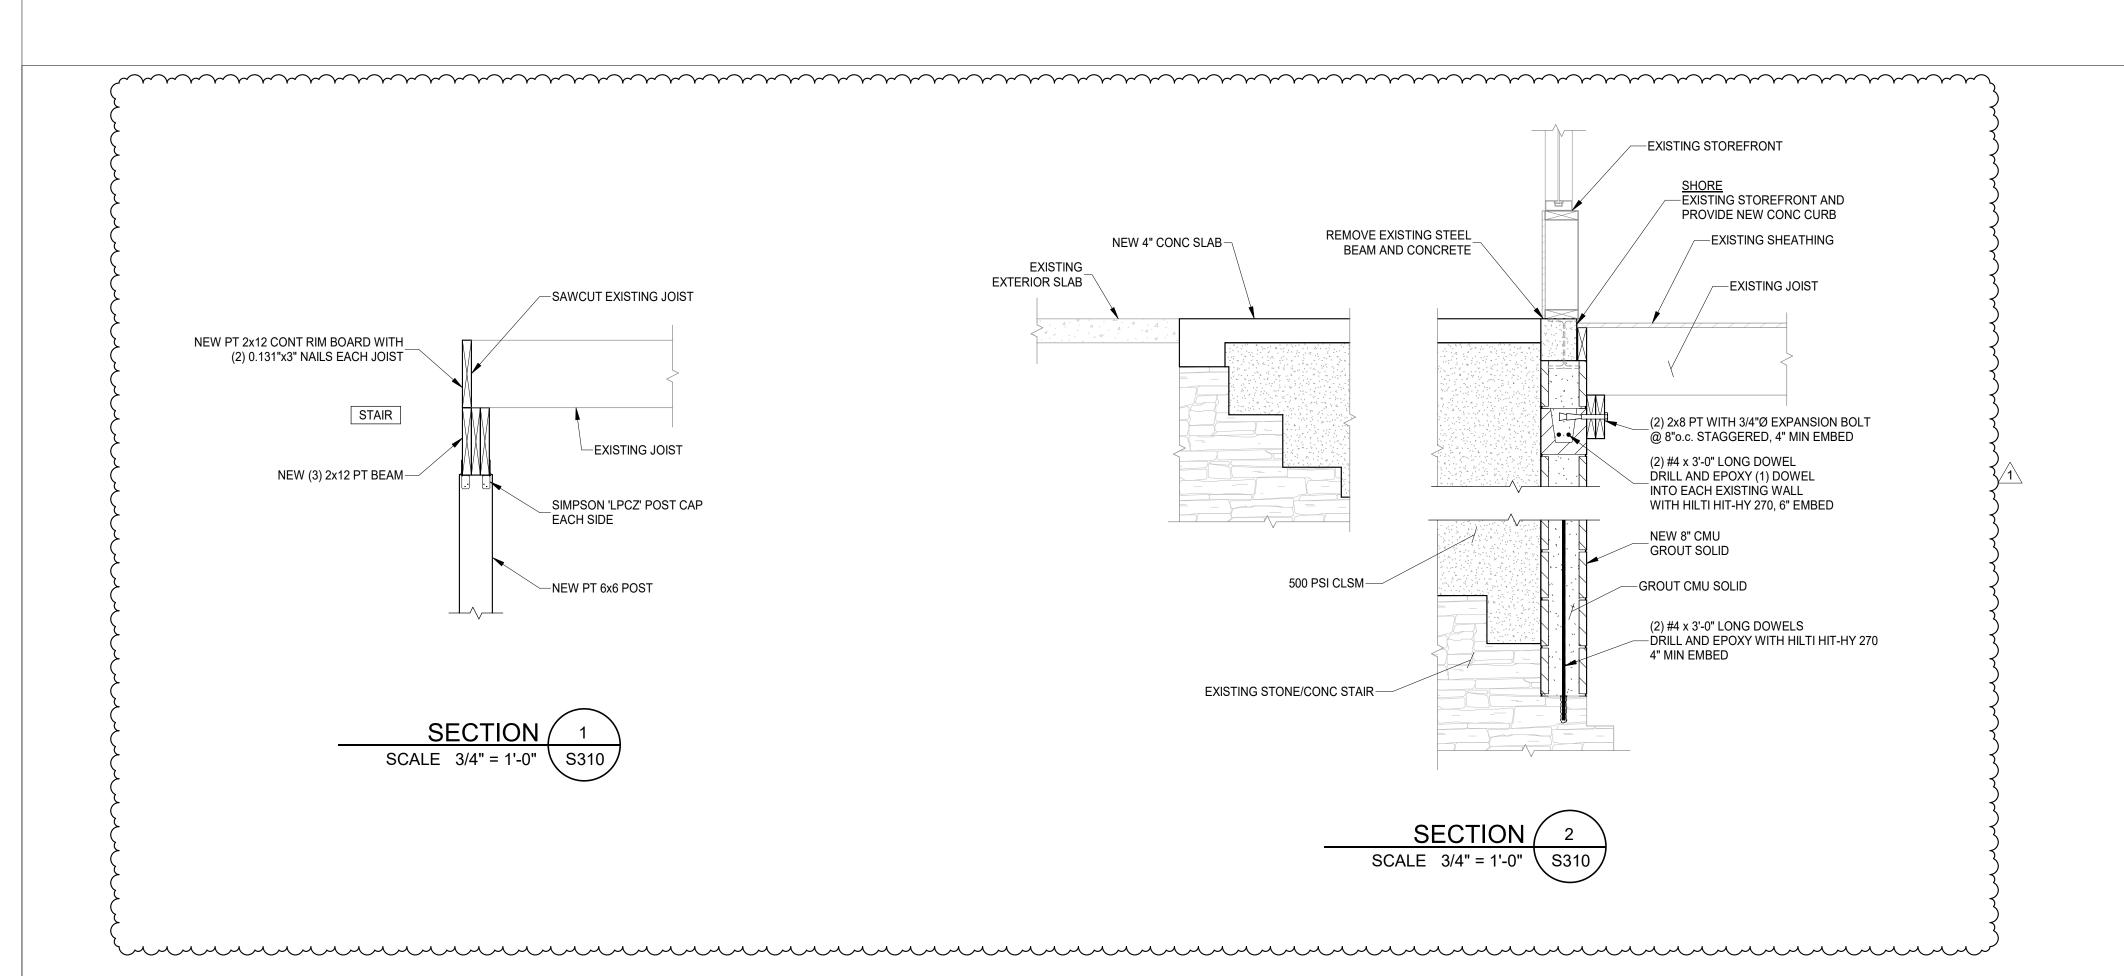

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PLUMBING LEGEND

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KEYED NOTES

EXISTING

- 1. CONNECT TO EXISTING SANITARY TIE-IN LOCATION. FIELD VERIFY EXACT LOCATION, INVERT, AND SIZE PRIOR TO CONSTRUCTION.
- SANITARY ROUTED FROM ABOVE. VERIFY ALL HEAD HEIGHTS AND EXACT ROUTING BEFORE CONSTRUCTION.
- . PROVIDE CLEAN OUTS AT ALL CHANGE OF DIRECTIONS PER LOCAL REQUIREMENTS (TYP).

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OH COA #4715



Progress Dates 08.15.2022 - BID SET

Revisions

05.27.2022 - REVISION #1

08.18.2023 - REVISION #3

Design Team:

MARQUE ENGINEERING

Drawn by:

MARQUE ENGINEERING

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ob No: 11920 04.26.

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KEYED NOTES

CONNECT TO EXISTING

EXISTING

- .. SANITARY FROM ABOVE AND CONTINUING TO BASEMENT BELOW. IF EXISTING CONDITIONS ALLOW FOR IT, ROUTE IN AND CONCEAL IN WALL. COORDINATE WITH ARCHITECT BEFORE INSTALLATION.
- EXISTING FIXTURE TO REMAIN. PROTECT DURING CONSTRUCTION.

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OH COA #4715

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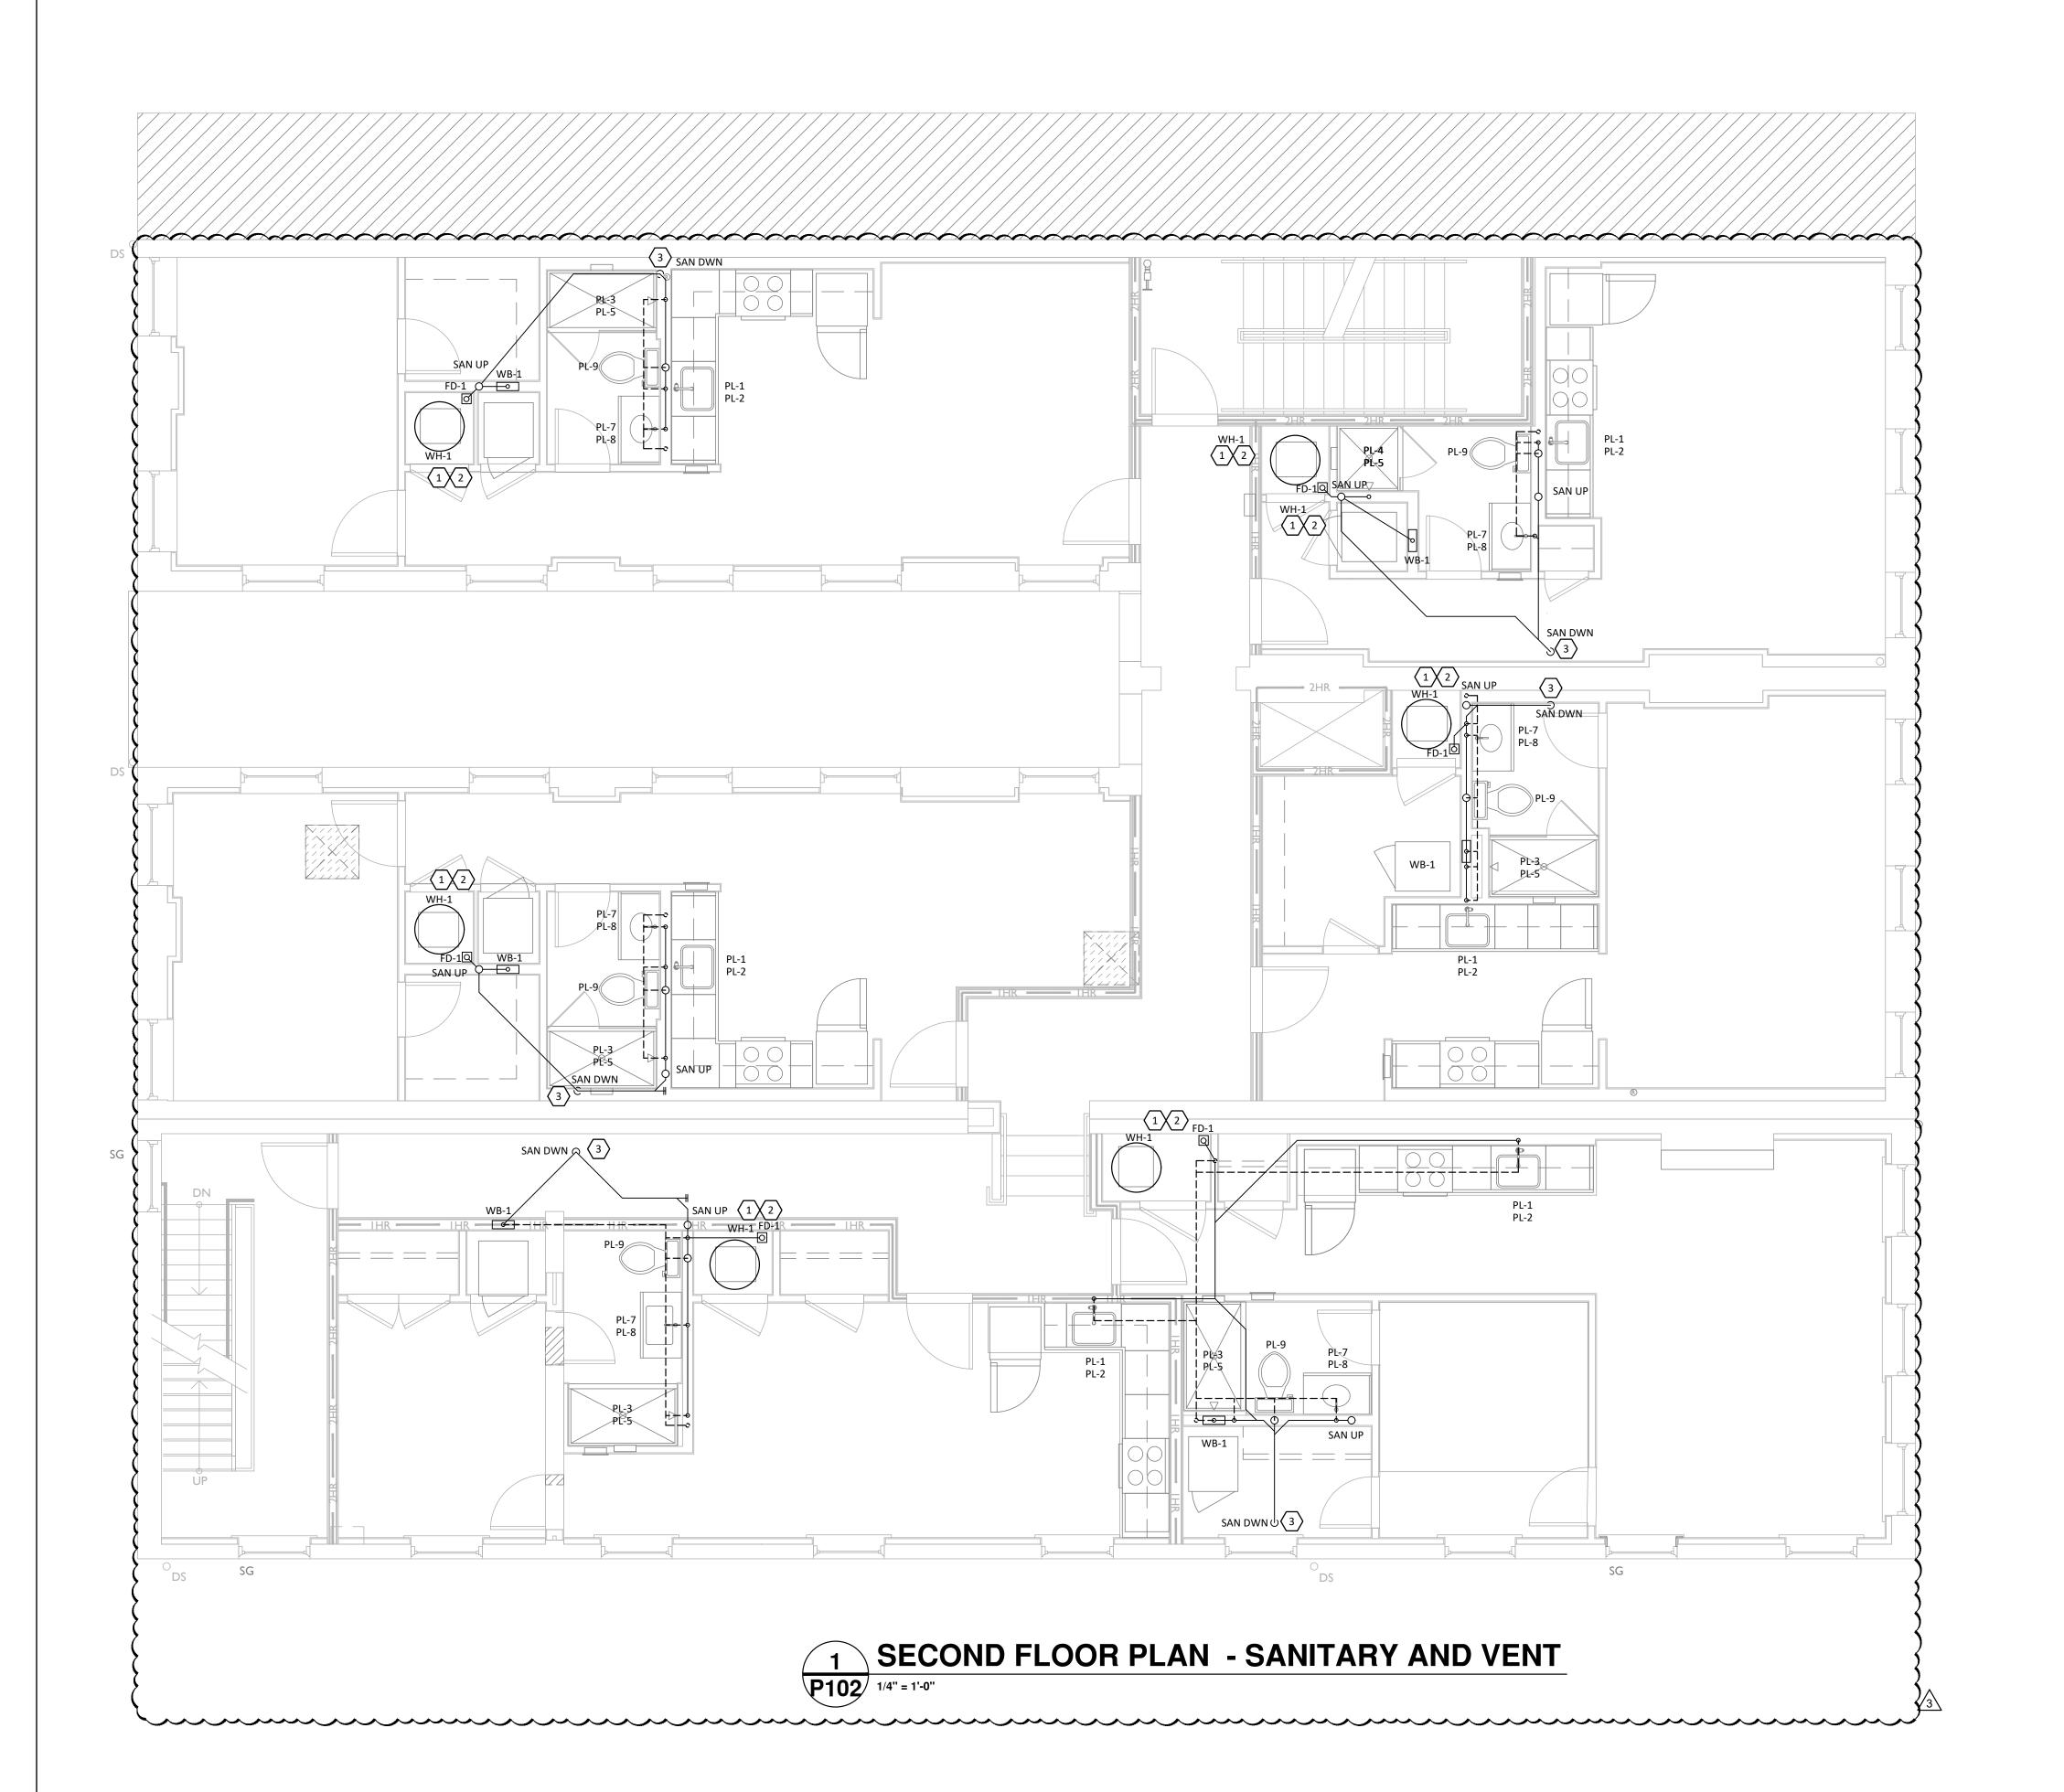
Design Team:
MARQUE ENGINEERING
Drawn by:
MARQUE ENGINEERING

A. ELDER STREET

| 6 W. ELDER 8

ob No: 11920 04.26.

P101



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KEYED NOTES

RECEPTACLE. TERMINATE WITH AIR GAP.

. ROUTE CONDENSATE DRAIN LINE FROM AIR HANDLING UNIT TO FLOOR DRAIN OR NEAREST APPROVED

EXISTING

- ROUTE CONDENSATE DRAIN LINE FROM WATER HEATER TO FLOOR DRAIN OR NEAREST APPROVED RECEPTACLE. TERMINATE WITH AIR GAP.
- . SANITARY PIPING DOWN THROUGH (OR ALONG) WALL TO FLOOR BELOW. COORDINATE WITH EXISTING CONDITIONS PRIOR TO INSTALLATION.

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MARQUE ENGINEERING
Drawn by:

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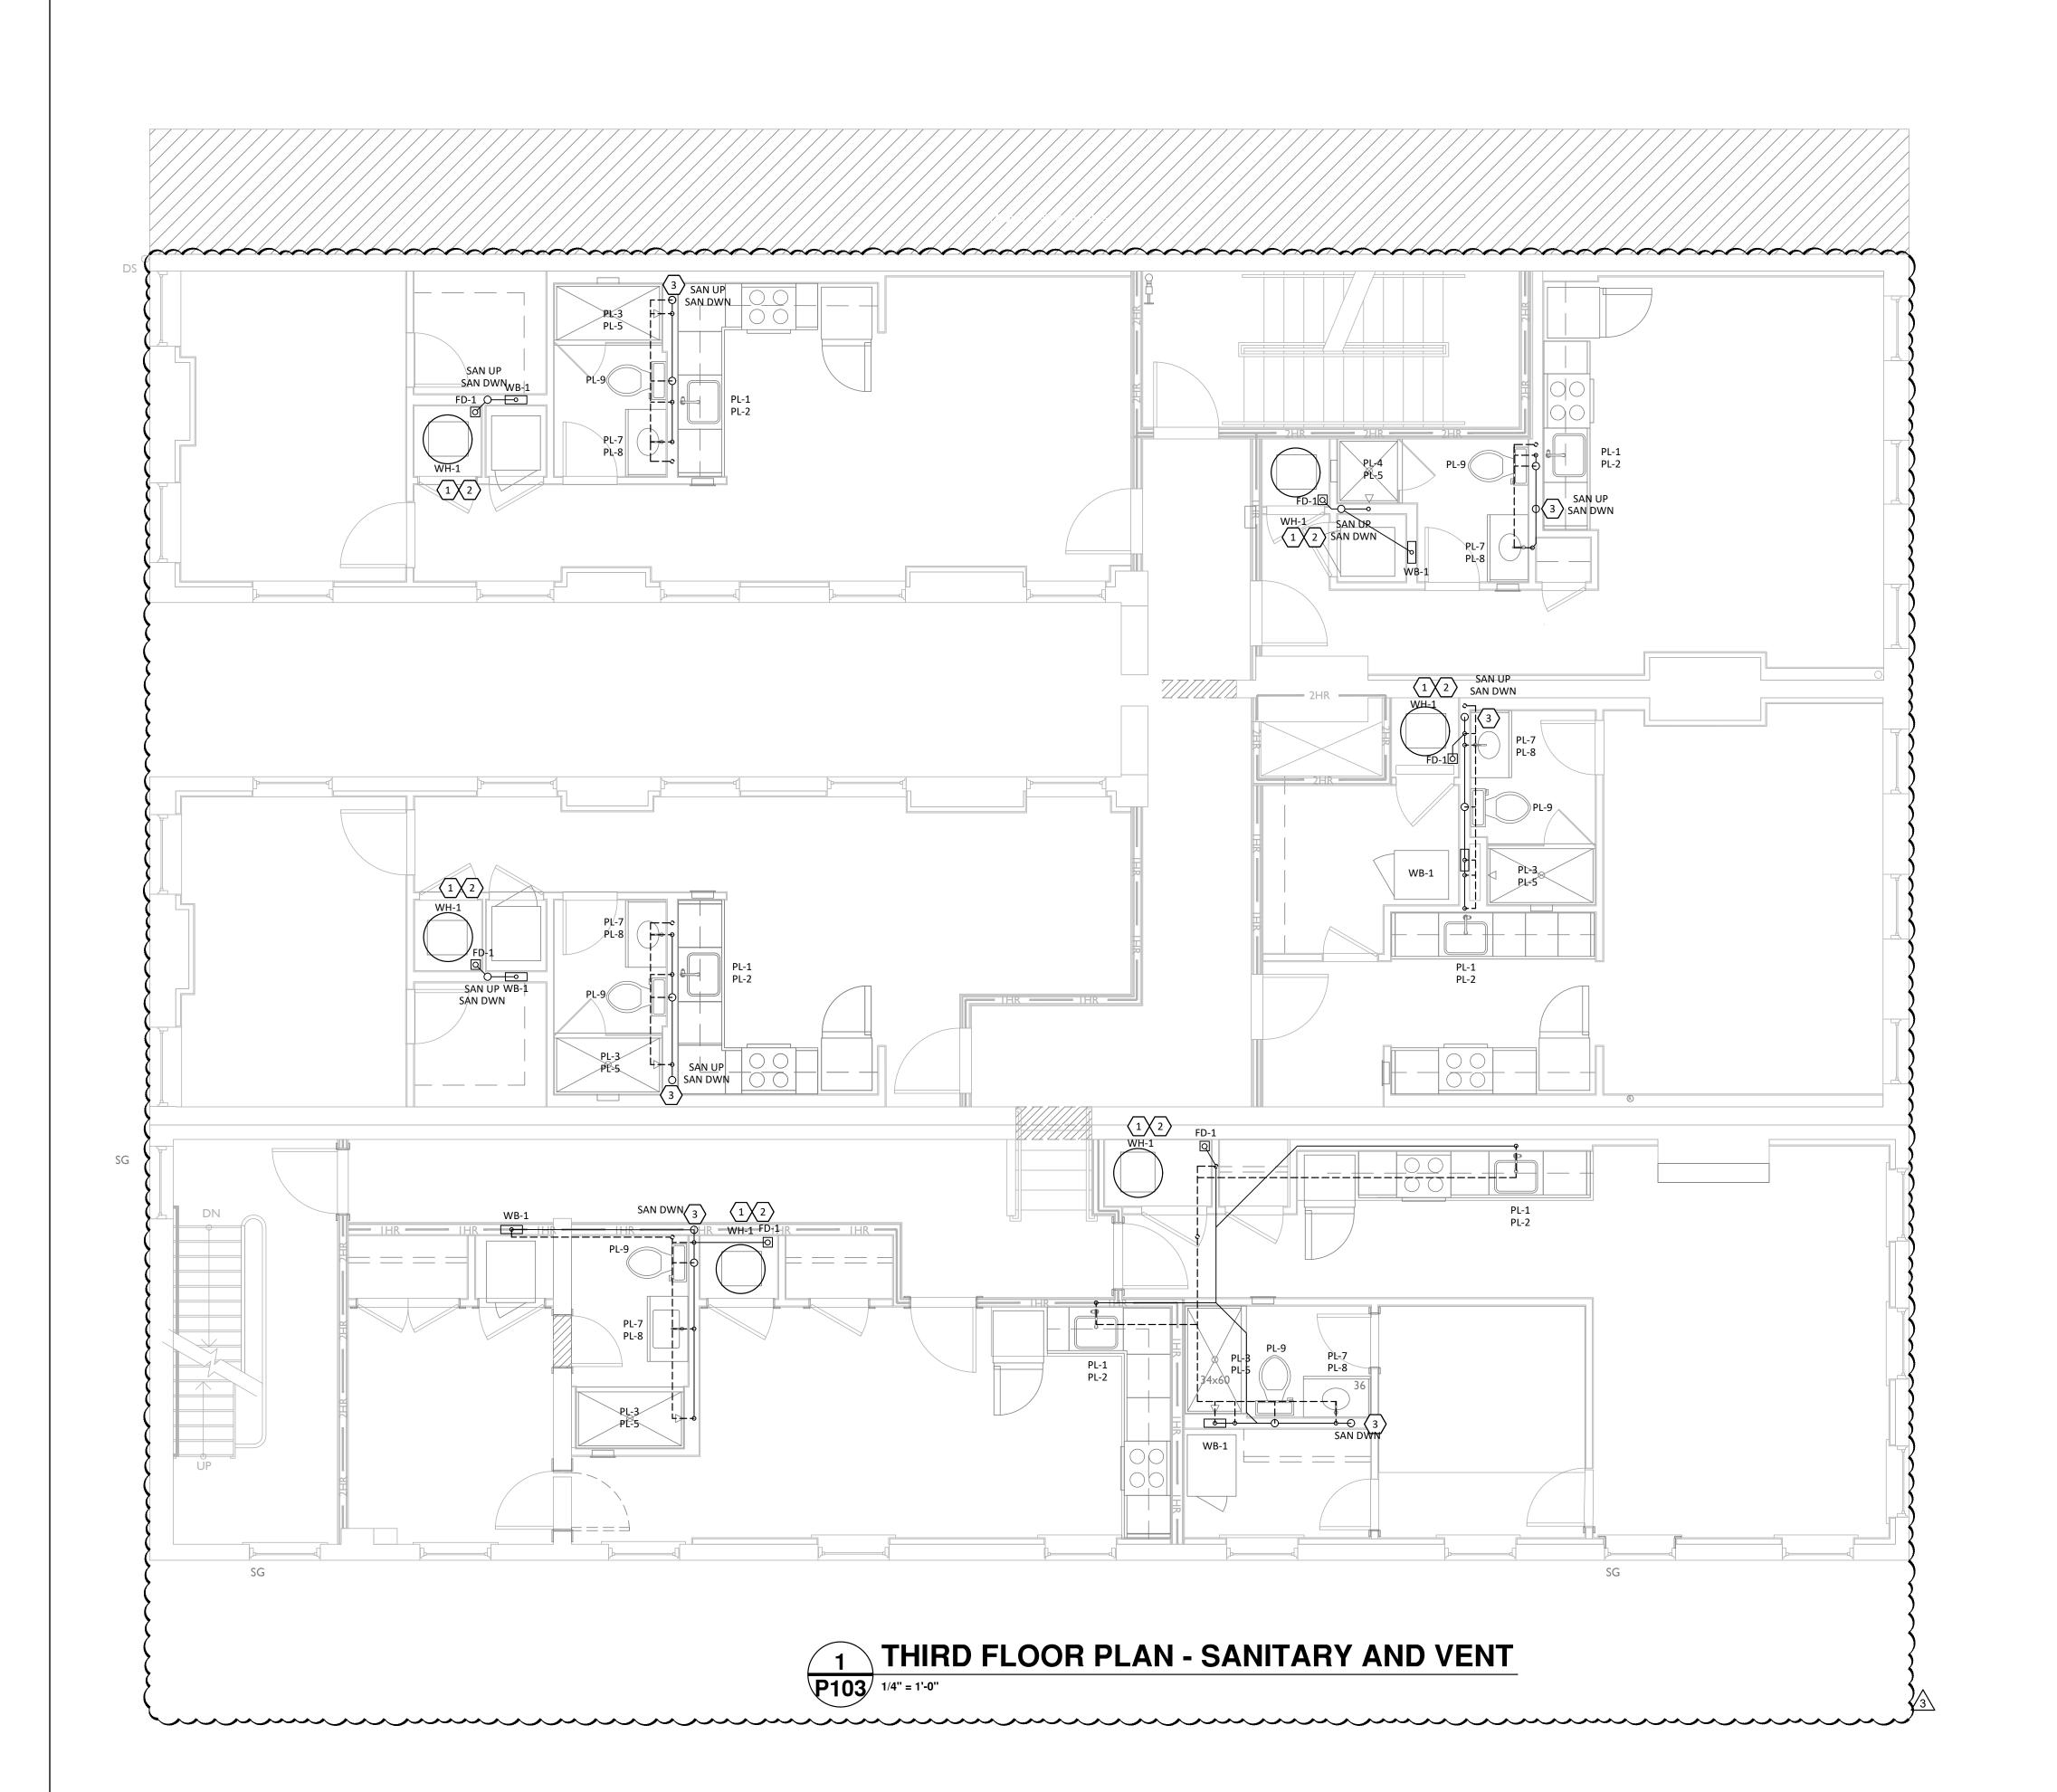
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W. ELDER STREET

B. STREET

Job No: 11920 04.26.2022

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EXISTING


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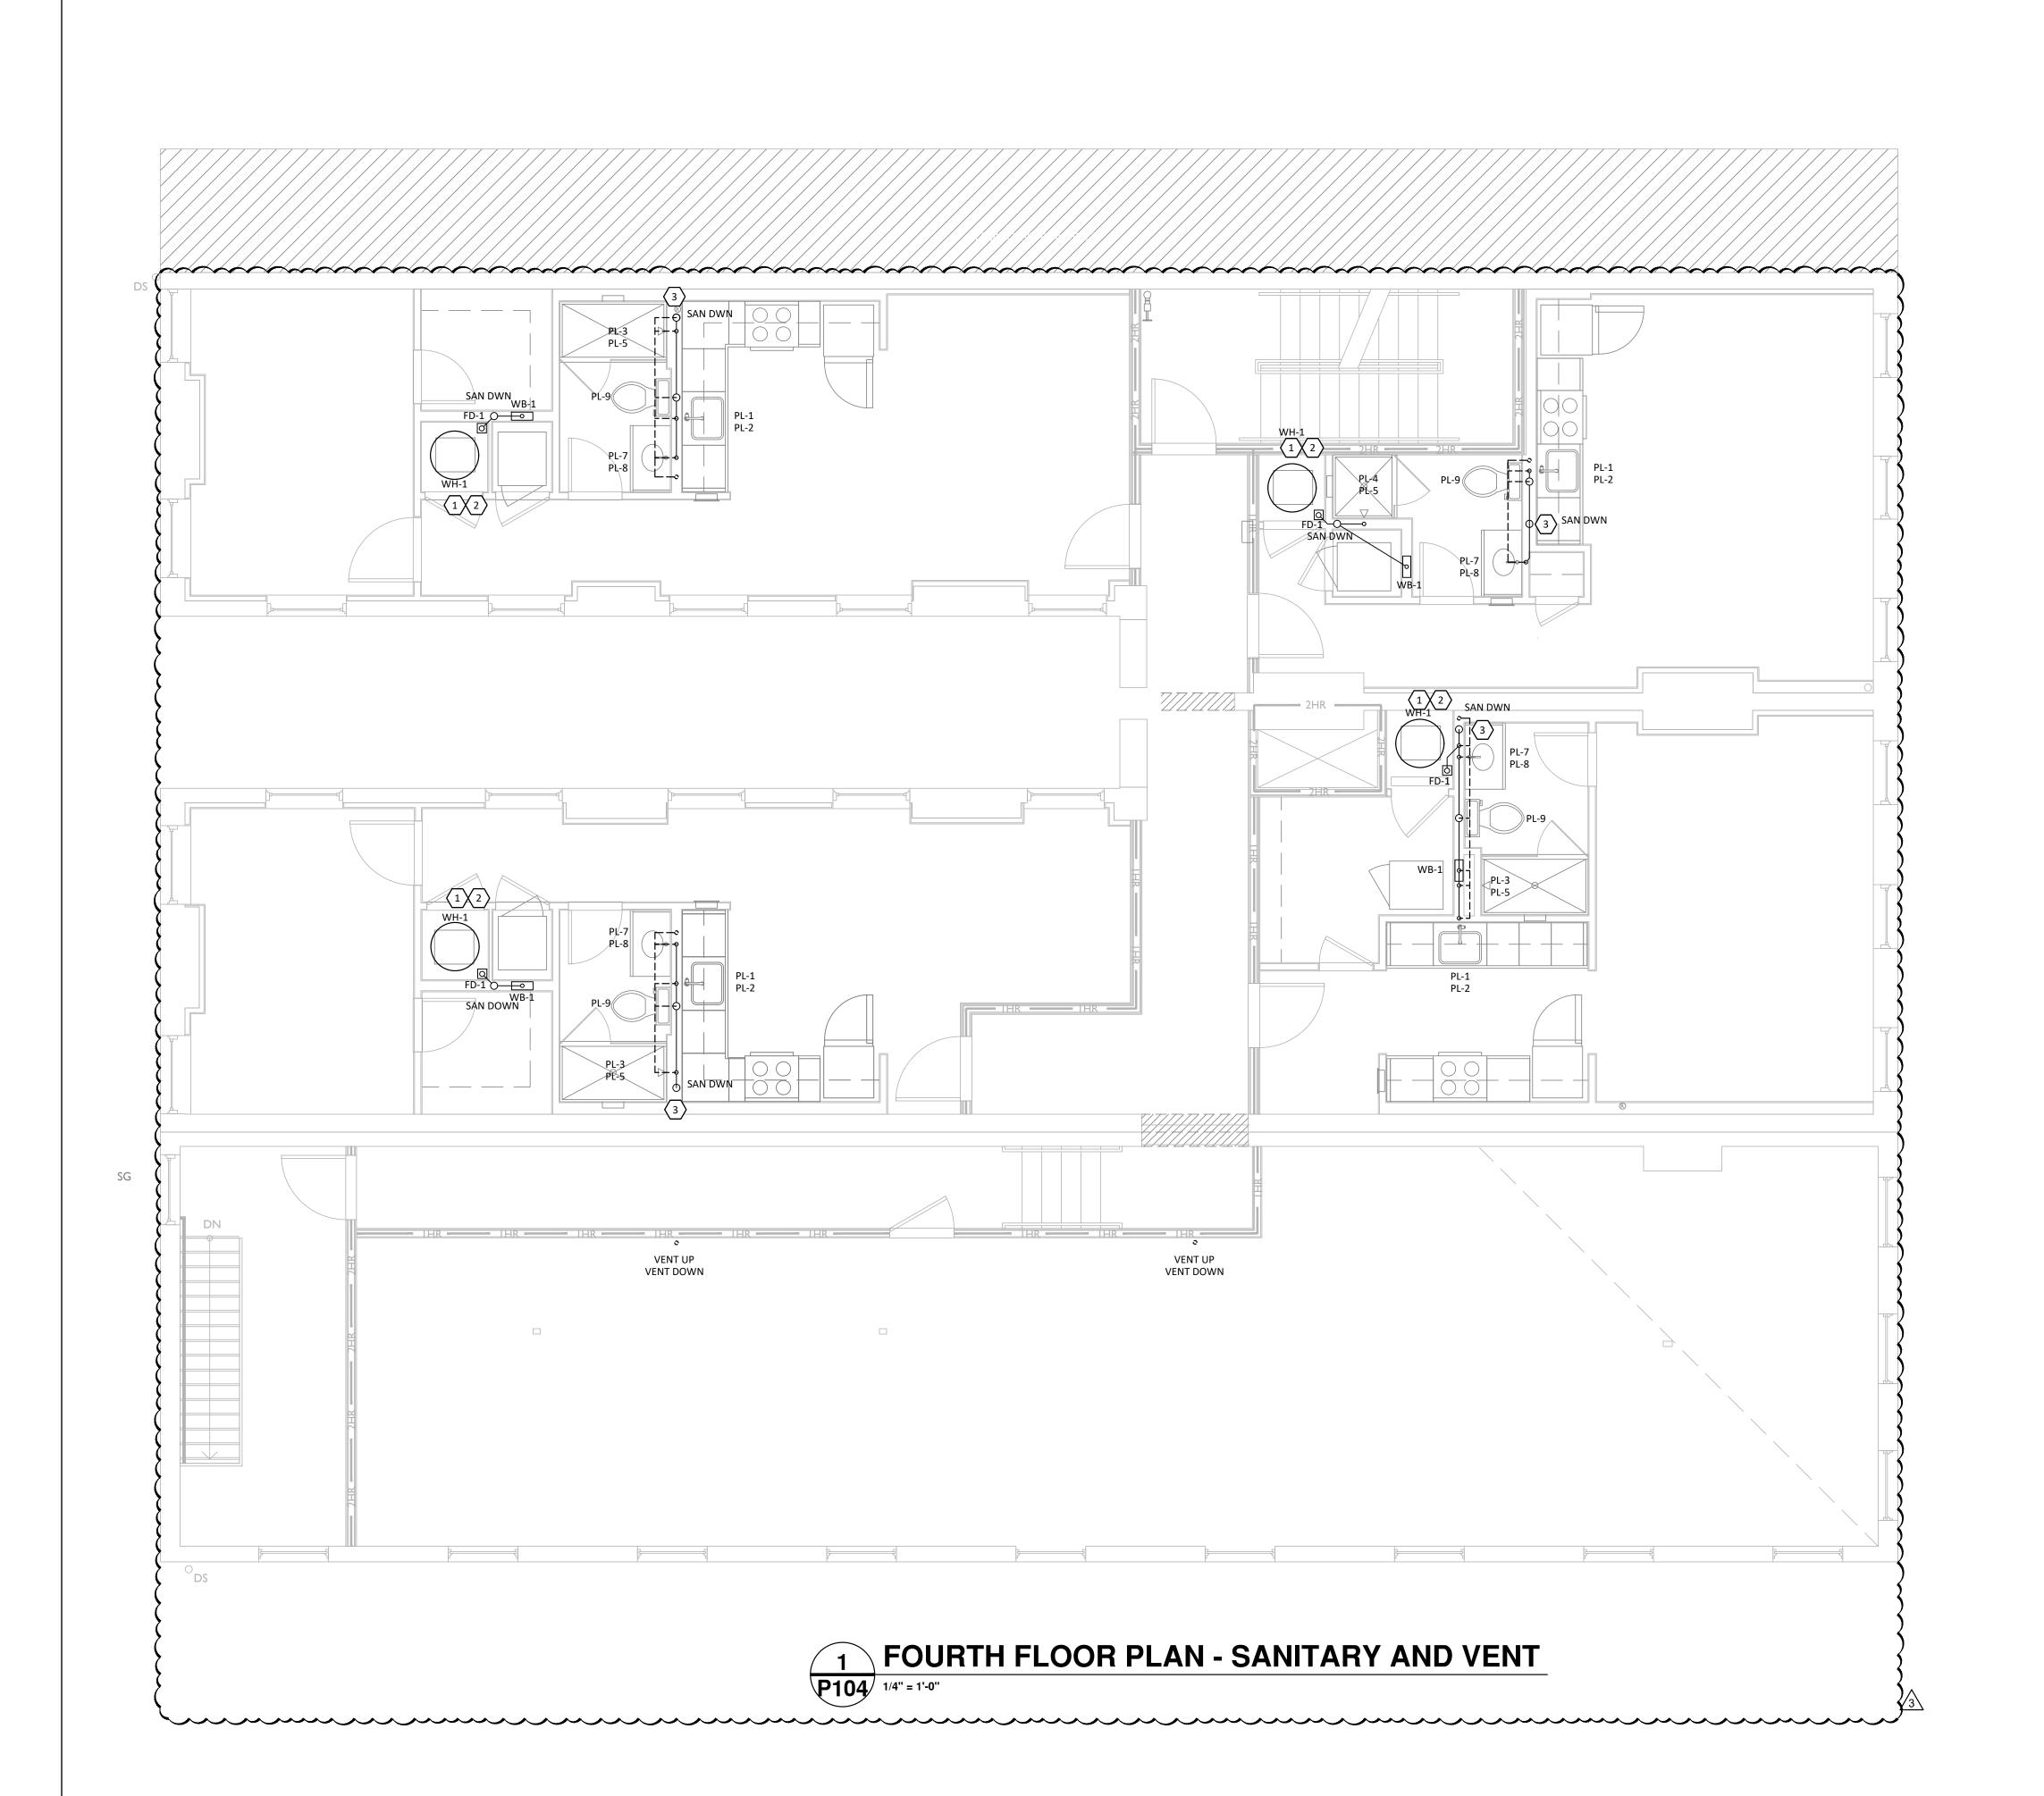
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Design Team:
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Job No: 11920 04.26.2022



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- OBTAIN WRITTEN APPROVAL FROM THE ENGINEER BEFORE REUSING ANY EXISTING EQUIPMENT, COMPONENTS OR OPENINGS.
- . INSULATE PLUMBING LINES IN EXTERIOR WALLS TO PREVENT FREEZING.
- COORDINATE ROOF WORK WITH ROOFING CONTRACTOR TO ASSURE THAT THE ROOF WARRANTY IS NOT VOIDED.

PLUMBING LEGEND

---- SANITARY VENT PIPING — — — — — — UNDERGROUND WATER PIPING DOMESTIC COLD WATER PIPING DOMESTIC HOT WATER PIPING —--- DOMESTIC HOT WATER RETURN PIPING — ST— STORM DRAINAGE PIPING ——— NATURAL GAS CHECK VALVE CO o CLEAN OUT wco T WALL CLEAN OUT FD 🖸 FLOOR DRAIN FWH 😽 FROSTPROOF WALL HYDRANT VTR ٥ VENT THROUGH ROOF DRAWING NOTE SYMBOL ELBOW DOWN EWH ELECTRIC WATER HEATER NN BFP BACKFLOW PREVENTER

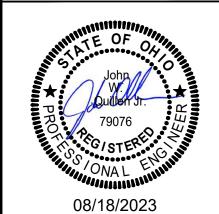RECEPTACLE. TERMINATE WITH AIR GAP.

KEYED NOTES

CONNECT TO EXISTING

EXISTING

- ROUTE CONDENSATE DRAIN LINE FROM AIR HANDLING UNIT TO FLOOR DRAIN OR NEAREST APPROVED
- ROUTE CONDENSATE DRAIN LINE FROM WATER HEATER TO FLOOR DRAIN OR NEAREST APPROVED RECEPTACLE. TERMINATE WITH AIR GAP.
- SANITARY PIPING DOWN THROUGH (OR ALONG) WALL TO FLOOR BELOW. COORDINATE WITH EXISTING CONDITIONS PRIOR TO INSTALLATION.

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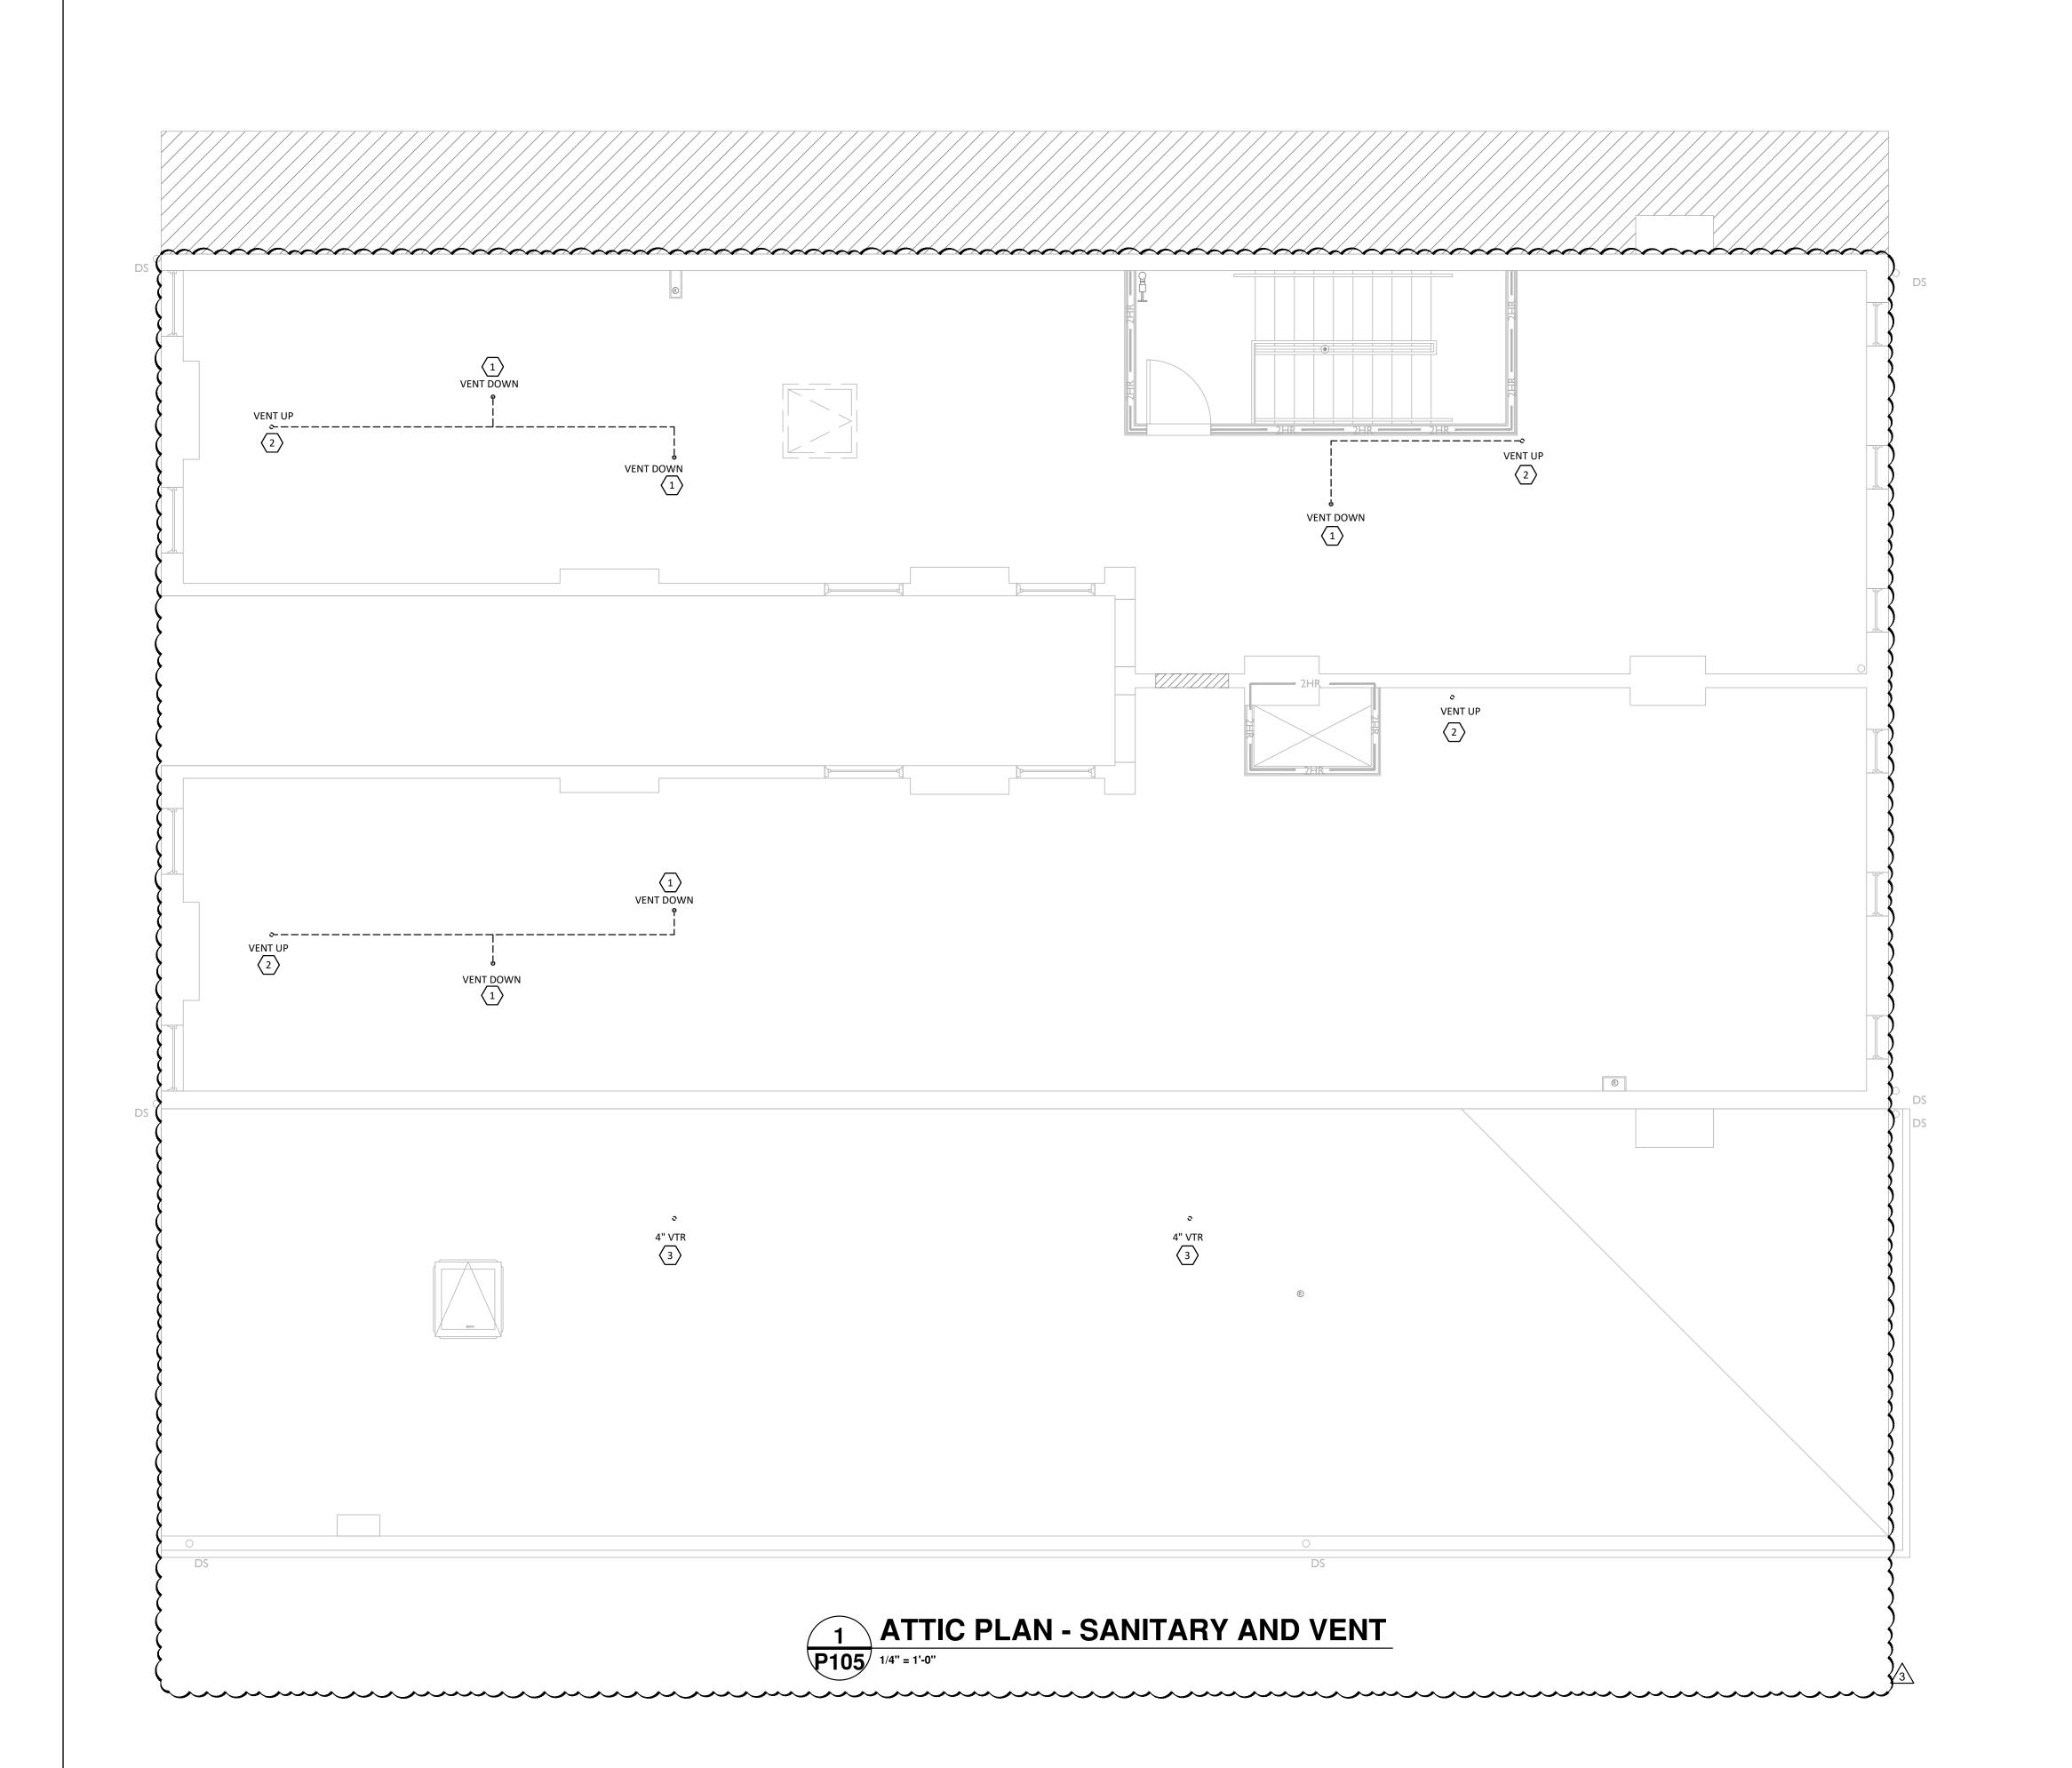
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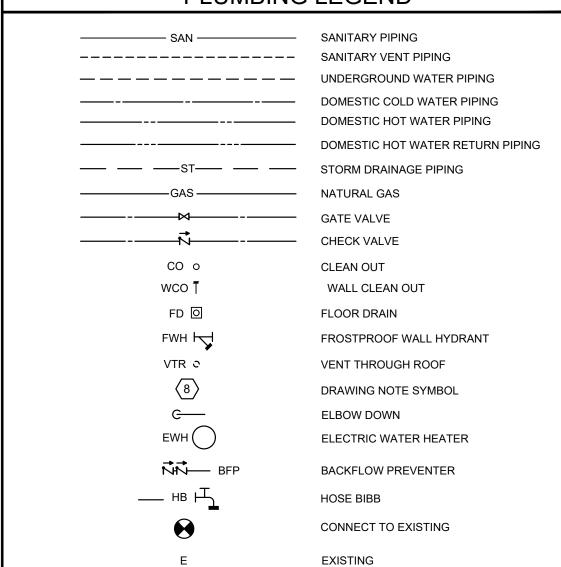
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- COMPONENTS OR OPENINGS. . INSULATE PLUMBING LINES IN EXTERIOR WALLS TO PREVENT FREEZING.
- COORDINATE ROOF WORK WITH ROOFING CONTRACTOR TO ASSURE THAT THE ROOF WARRANTY
- IS NOT VOIDED.

PLUMBING LEGEND



KEYED NOTES

- VENT PIPING FROM BELOW.
- ROUTE VENTING THROUGH ATTIC TO ROOF.
- 4" VENT THROUGH ROOF. MAINTAIN 10' MINIMUM FROM ANY AIR INTAKE. PAINT TO MATCH ROOF

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PLUMBING LEGEND

---- SANITARY VENT PIPING — — — — — — UNDERGROUND WATER PIPING DOMESTIC HOT WATER PIPING DOMESTIC HOT WATER RETURN PIPING —GAS — NATURAL GAS CHECK VALVE CO o CLEAN OUT wco T WALL CLEAN OUT FD 🖸 FLOOR DRAIN FROSTPROOF WALL HYDRANT FWH 😽 VENT THROUGH ROOF VTR ٥ DRAWING NOTE SYMBOL ELBOW DOWN EWH ELECTRIC WATER HEATER NN BFP BACKFLOW PREVENTER CONNECT TO EXISTING

KEYED NOTES

- 4" VENT THROUGH ROOF. MAINTAIN 10' MINIMUM FROM ANY AIR INTAKE. PAINT TO MATCH ROOF
- MAINTAIN EXISTING DOWNSPOUT FROM ROOF. PROVIDE MAINTENANCE ON DOWNSPOUT TO CONFIRM GOOD OPERATING CONDITION. IF IN POOR CONDITION, COORDINATE WITH OWNER AND ARCHITECT ON REPLACEMENT. CONNECT TO EXISTING.

EXISTING


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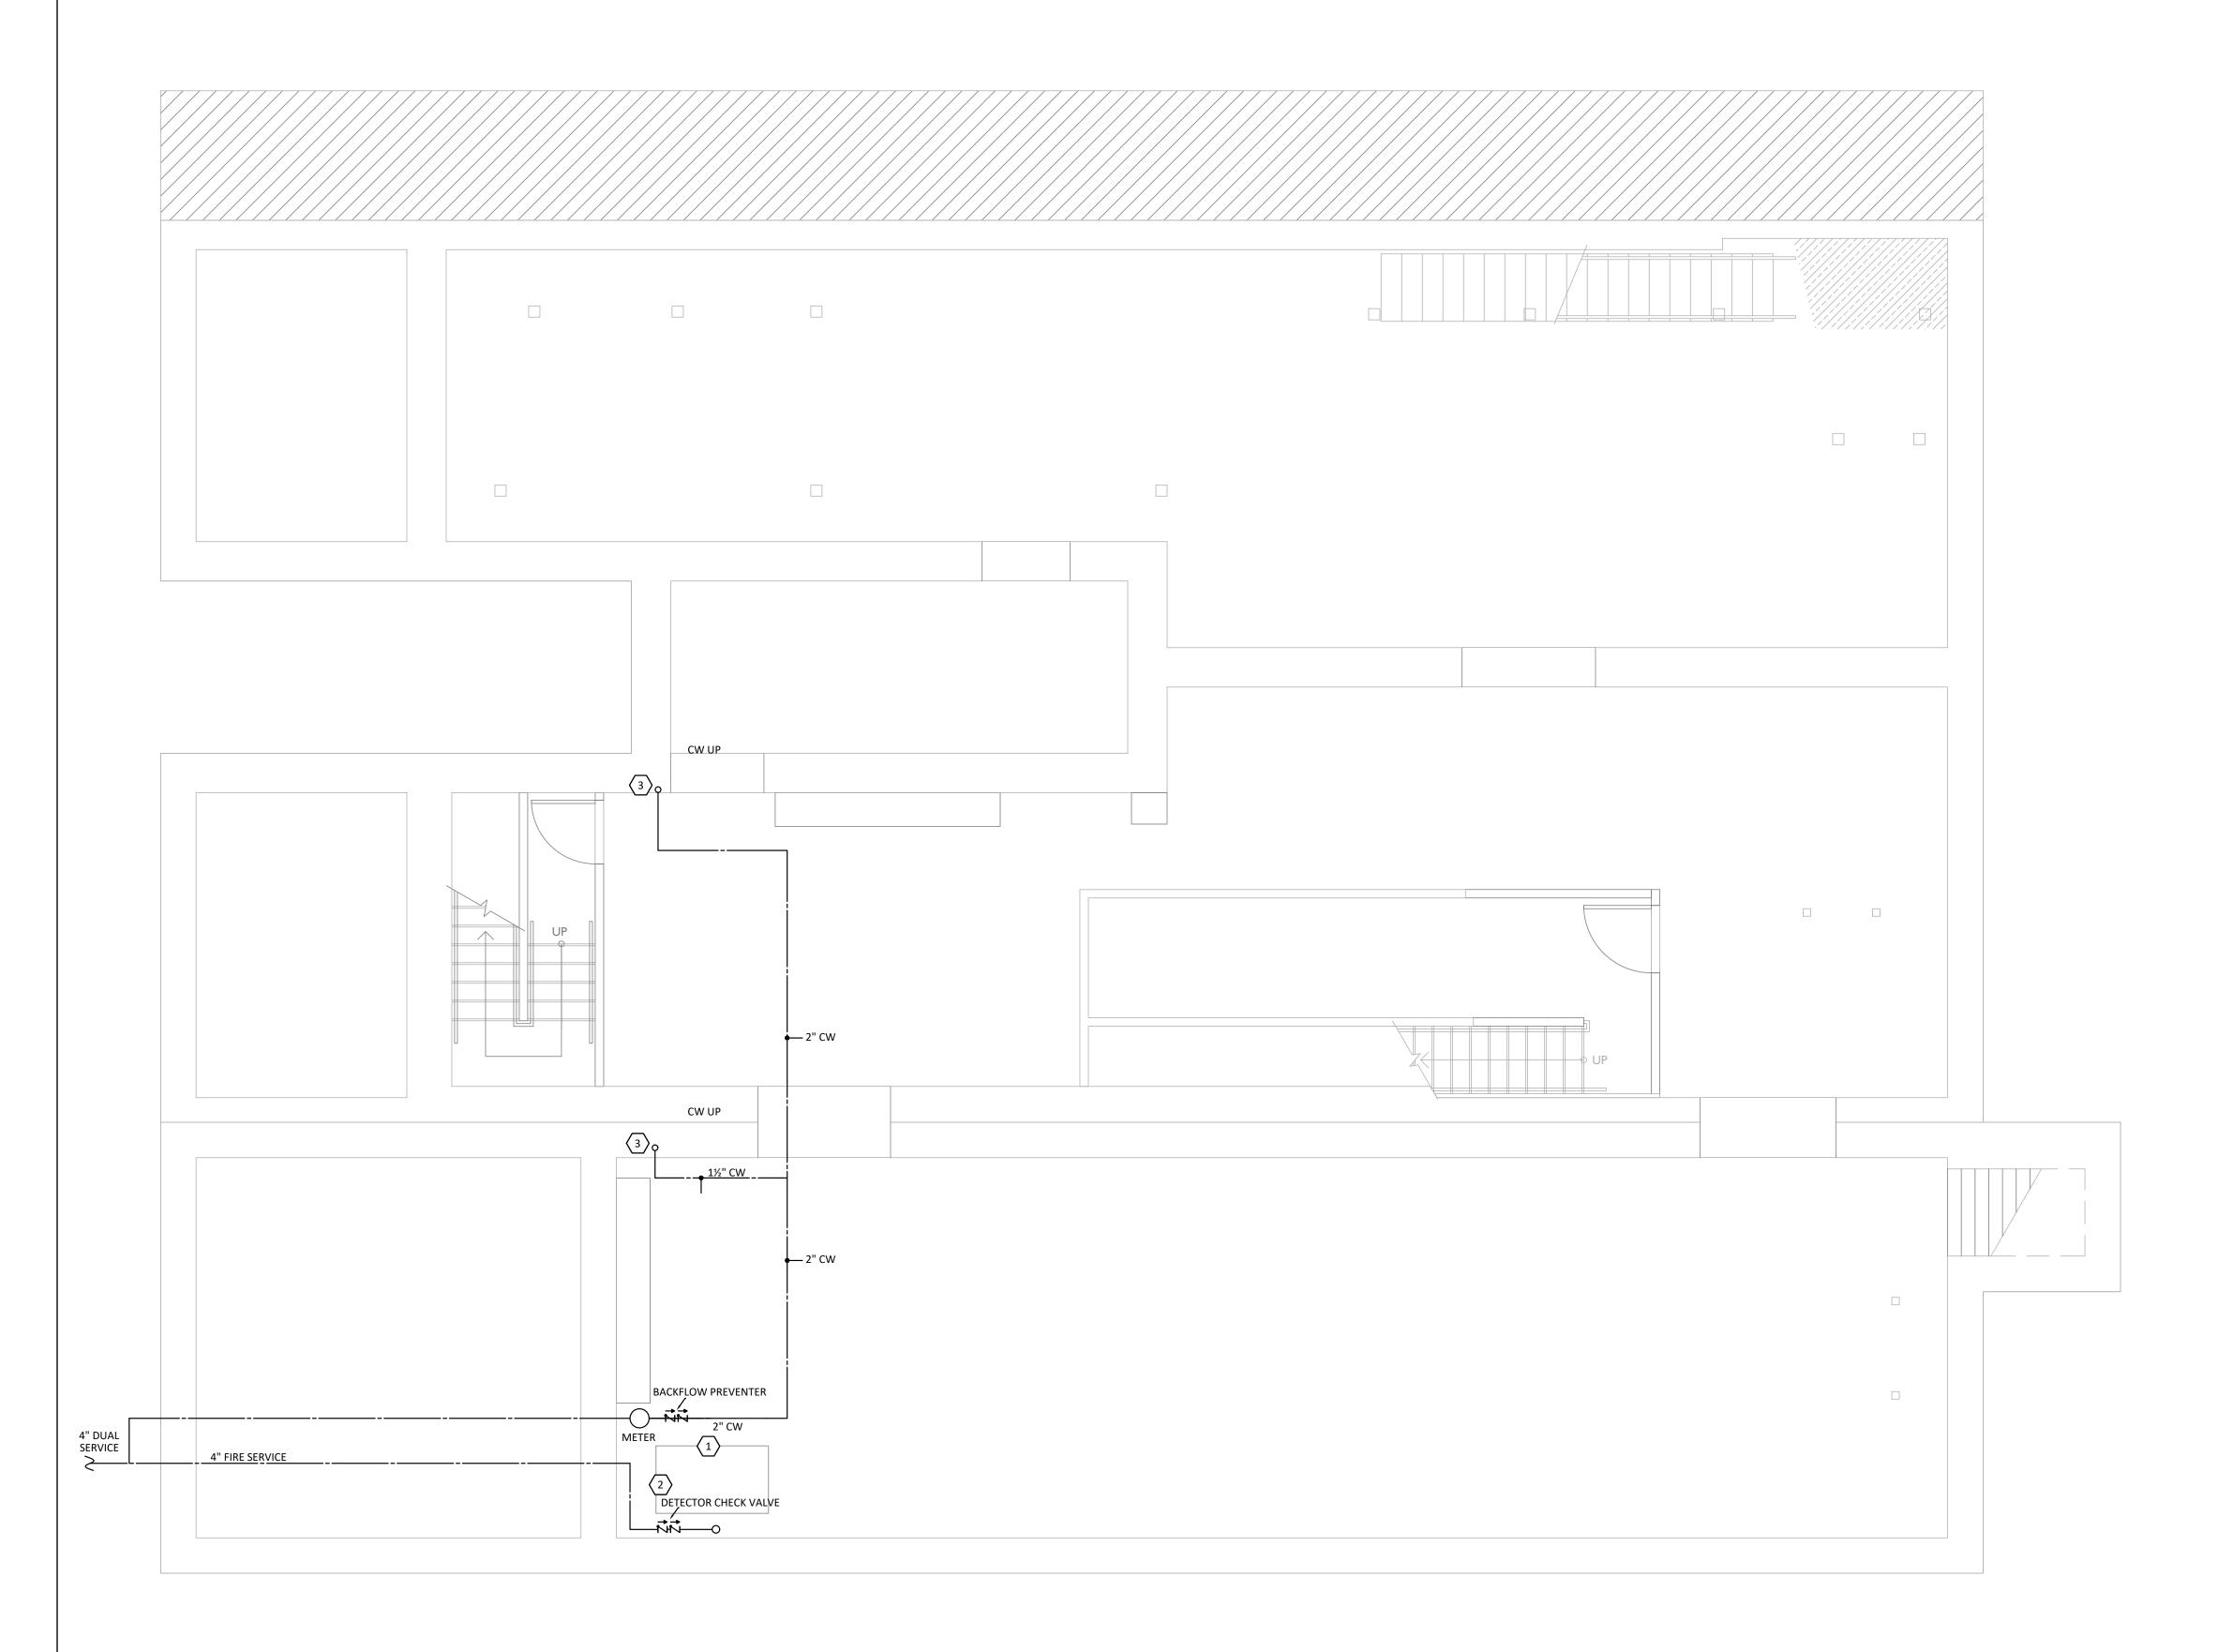
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Drawn by:
MARQUE ENGINEERING

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V. ELDER STREET

Job No: 11920 04.26.2022




BASEMENT PLAN - WATER AND GAS

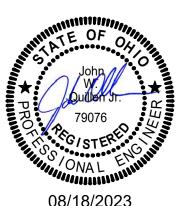P107 1/4" = 1'-0"

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- I. COORDINATE ROOF WORK WITH ROOFING CONTRACTOR TO ASSURE THAT THE ROOF WARRANTY IS NOT VOIDED.

PLUMBING LEGEND

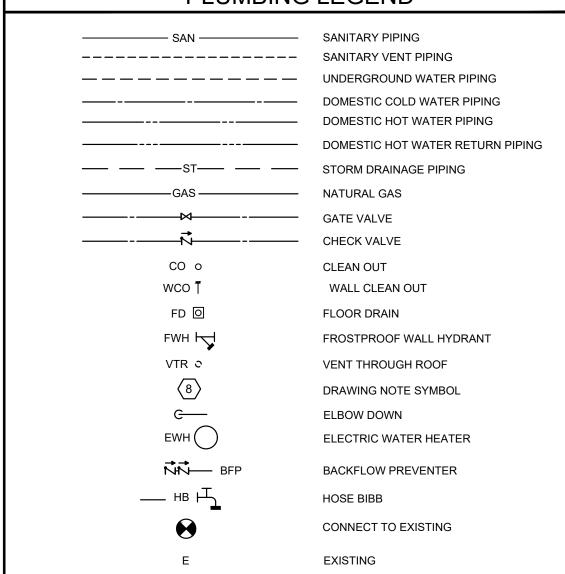

KEYED NOTES

- . NEW DUAL FIRE AND DOMESTIC WATER SERVICE BY OTHERS. PLUMBING CONTRACTOR TO CONNECT TO AND EXTEND DOMESTIC WATER SERVICE INTO BUILDING. COORDINATE WATER SERVICE WITH CIVIL PLANS. FIRE SUPPRESSION ENGINEER TO CONFIRM 4" FIRE LINE.
- 2. NEW DUAL FIRE AND DOMESTIC WATER SERVICE BY OTHERS. PLUMBING CONTRACTOR TO CONNECT TO AND EXTEND DOMESTIC WATER SERVICE INTO BUILDING. PROVIDE OVERALL WATER METERS (COMMERCIAL AND RESIDENTIAL AS NOTED) AND BACKFLOW PREVENTER. COORDINATE WATER SERVICE WITH CIVIL PLANS.
- ROUTE COLD WATER LINE FROM BASEMENT CEILING UP TO FIRST FLOOR. SEE FIRST FLOOR PLAN FOR CONTINUATION.

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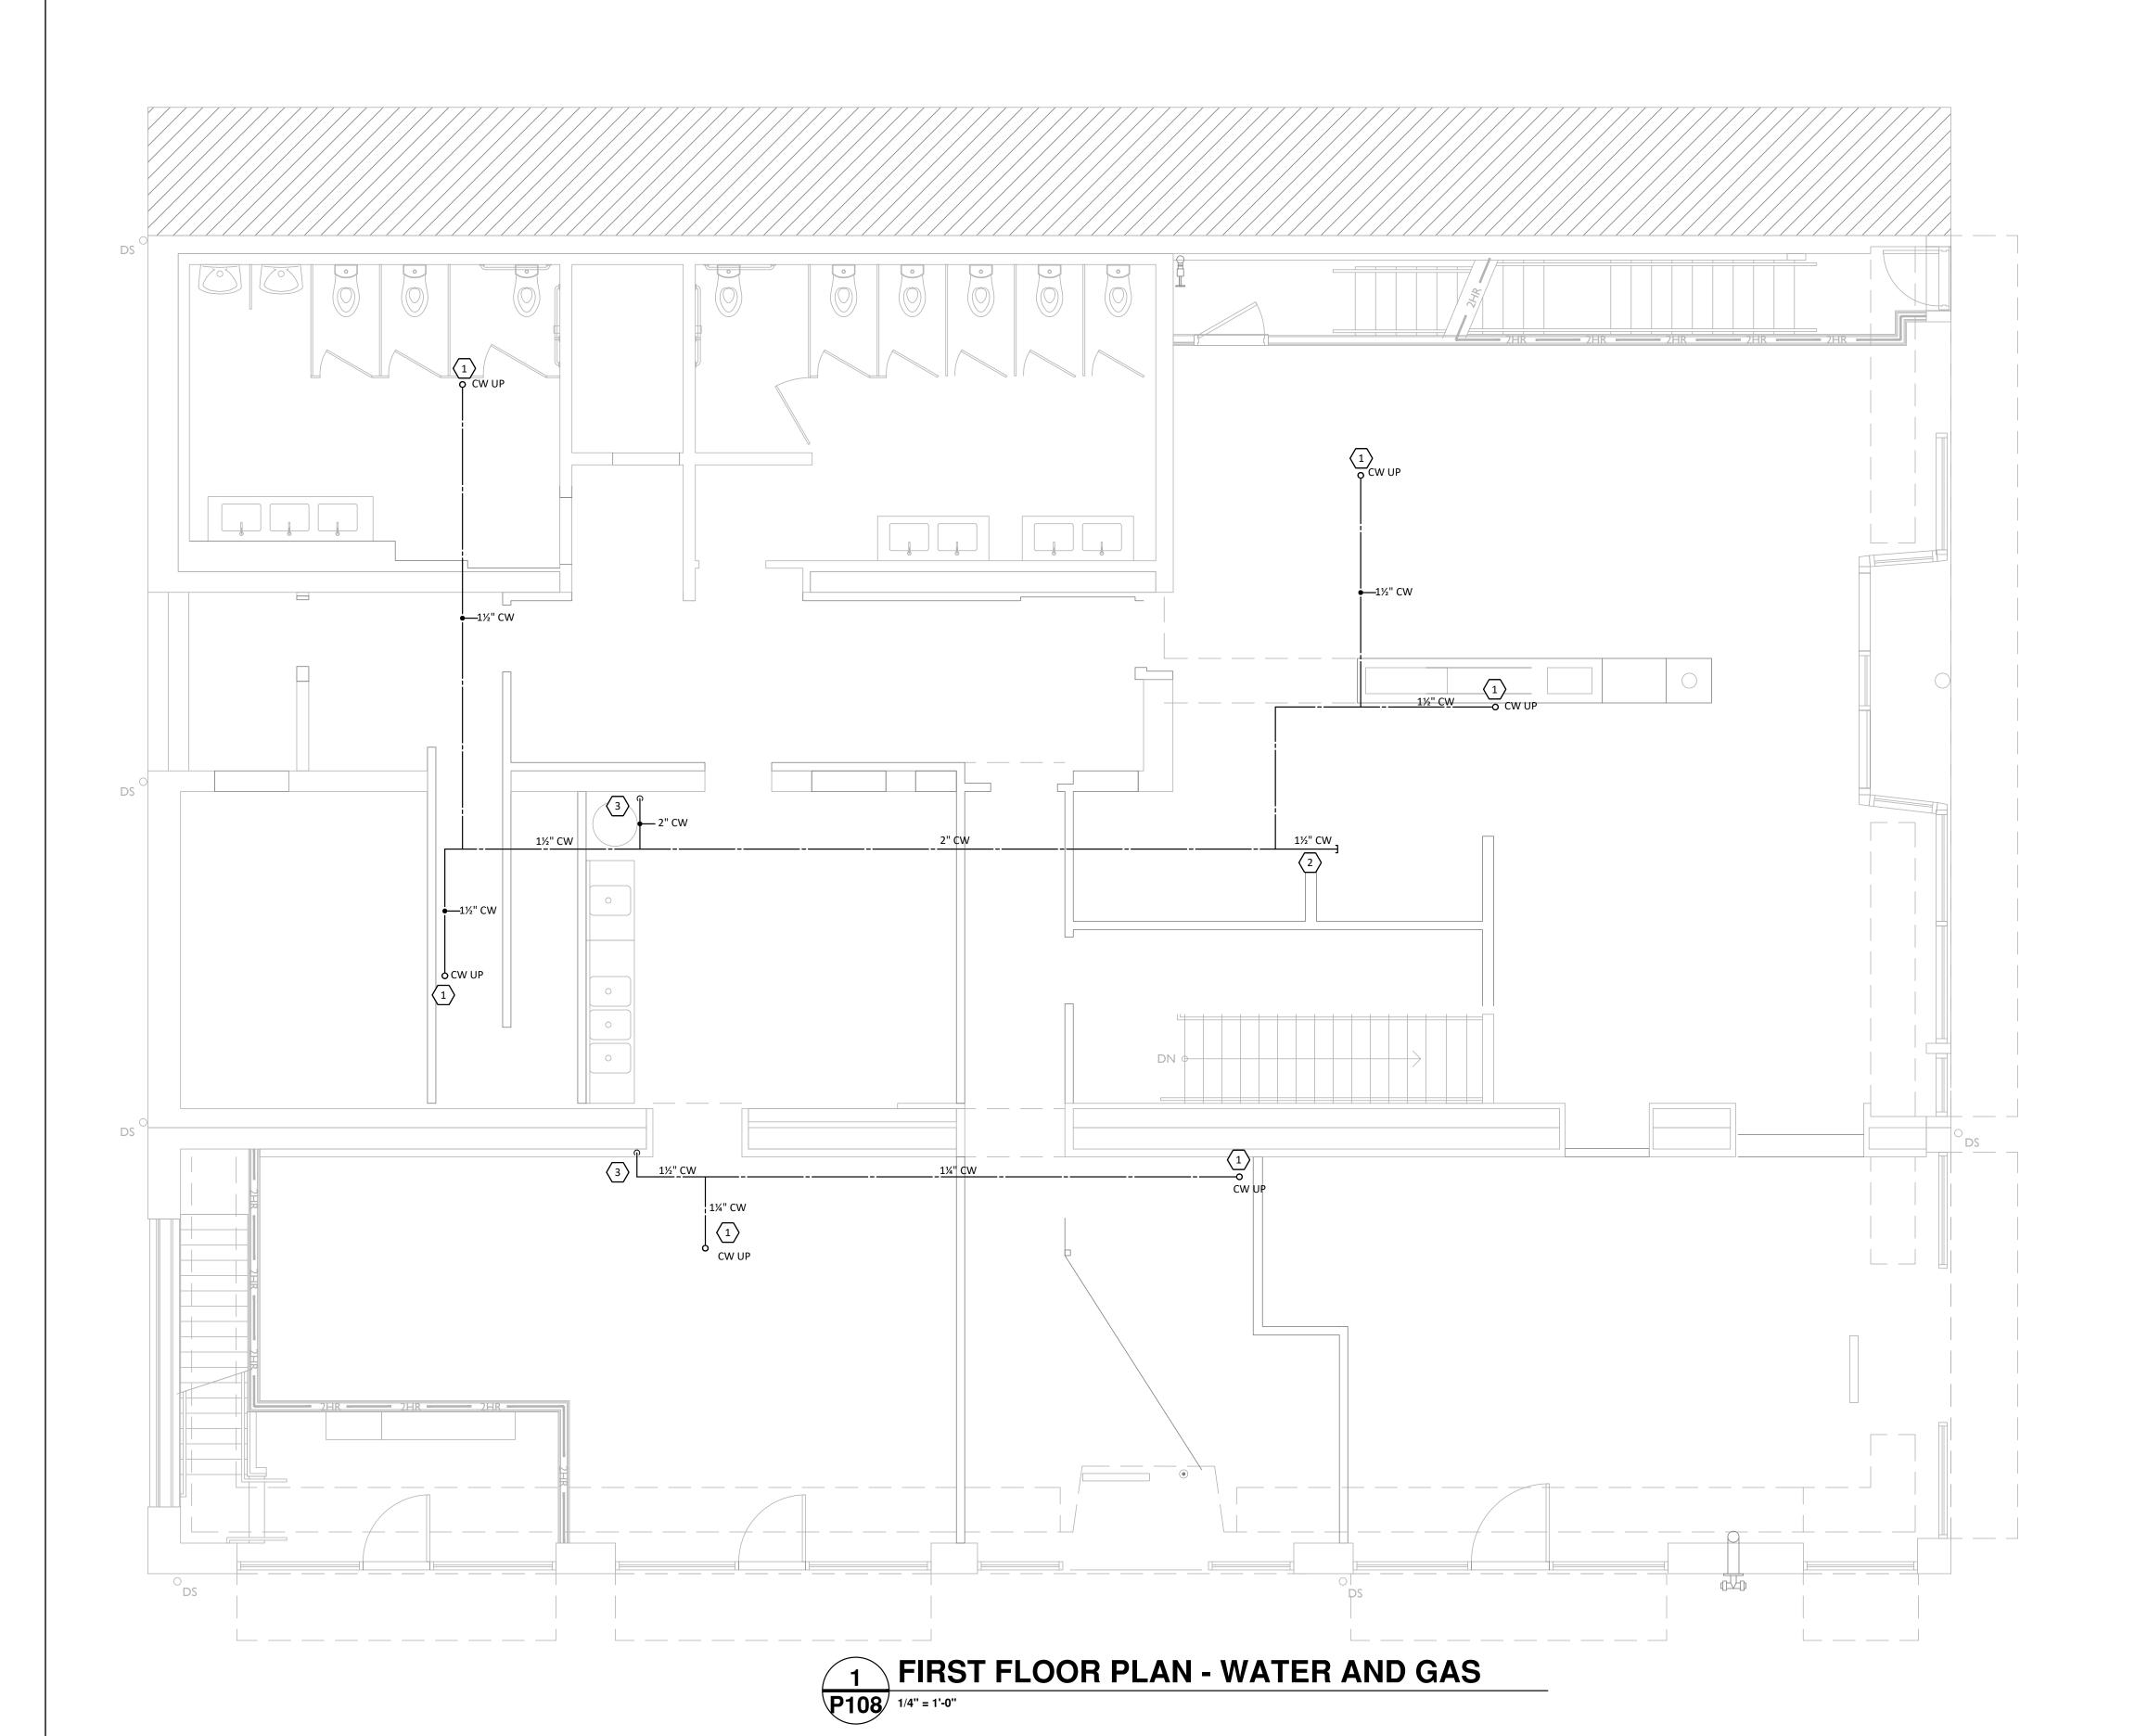
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PLUMBING LEGEND

——— SAN ————— SANITARY PIPING ---- SANITARY VENT PIPING — — — — — — UNDERGROUND WATER PIPING DOMESTIC HOT WATER PIPING DOMESTIC HOT WATER RETURN PIPING — ST— STORM DRAINAGE PIPING —— NATURAL GAS GATE VALVE CHECK VALVE CO o CLEAN OUT wco T WALL CLEAN OUT FD 🖸 FLOOR DRAIN FWH 😽 FROSTPROOF WALL HYDRANT VTR ٥ VENT THROUGH ROOF DRAWING NOTE SYMBOL C---- **ELBOW DOWN** EWH ELECTRIC WATER HEATER **N**→ BFP BACKFLOW PREVENTER HOSE BIBB

KEYED NOTES

CONNECT TO EXISTING

EXISTING

- .. ROUTE COLD WATER LINE FROM FIRST FLOOR CEILING UP TO SECOND FLOOR. SEE SECOND FLOOR PLAN FOR CONTINUATION.
- CAP 1½" COLD WATER LINE AND PROVIDE NEPTUNE T-10 TAB METER FOR FUTURE TENANT.
- 3. COLD WATER ROUTED FROM BASEMENT BELOW. CONCEAL WATERLINES IN WALL IF EXISTING CONDITIONS ALLOW. IF EXPOSED, COORDINATE WITH ARCHITECT ON EXACT LOCATIONS.

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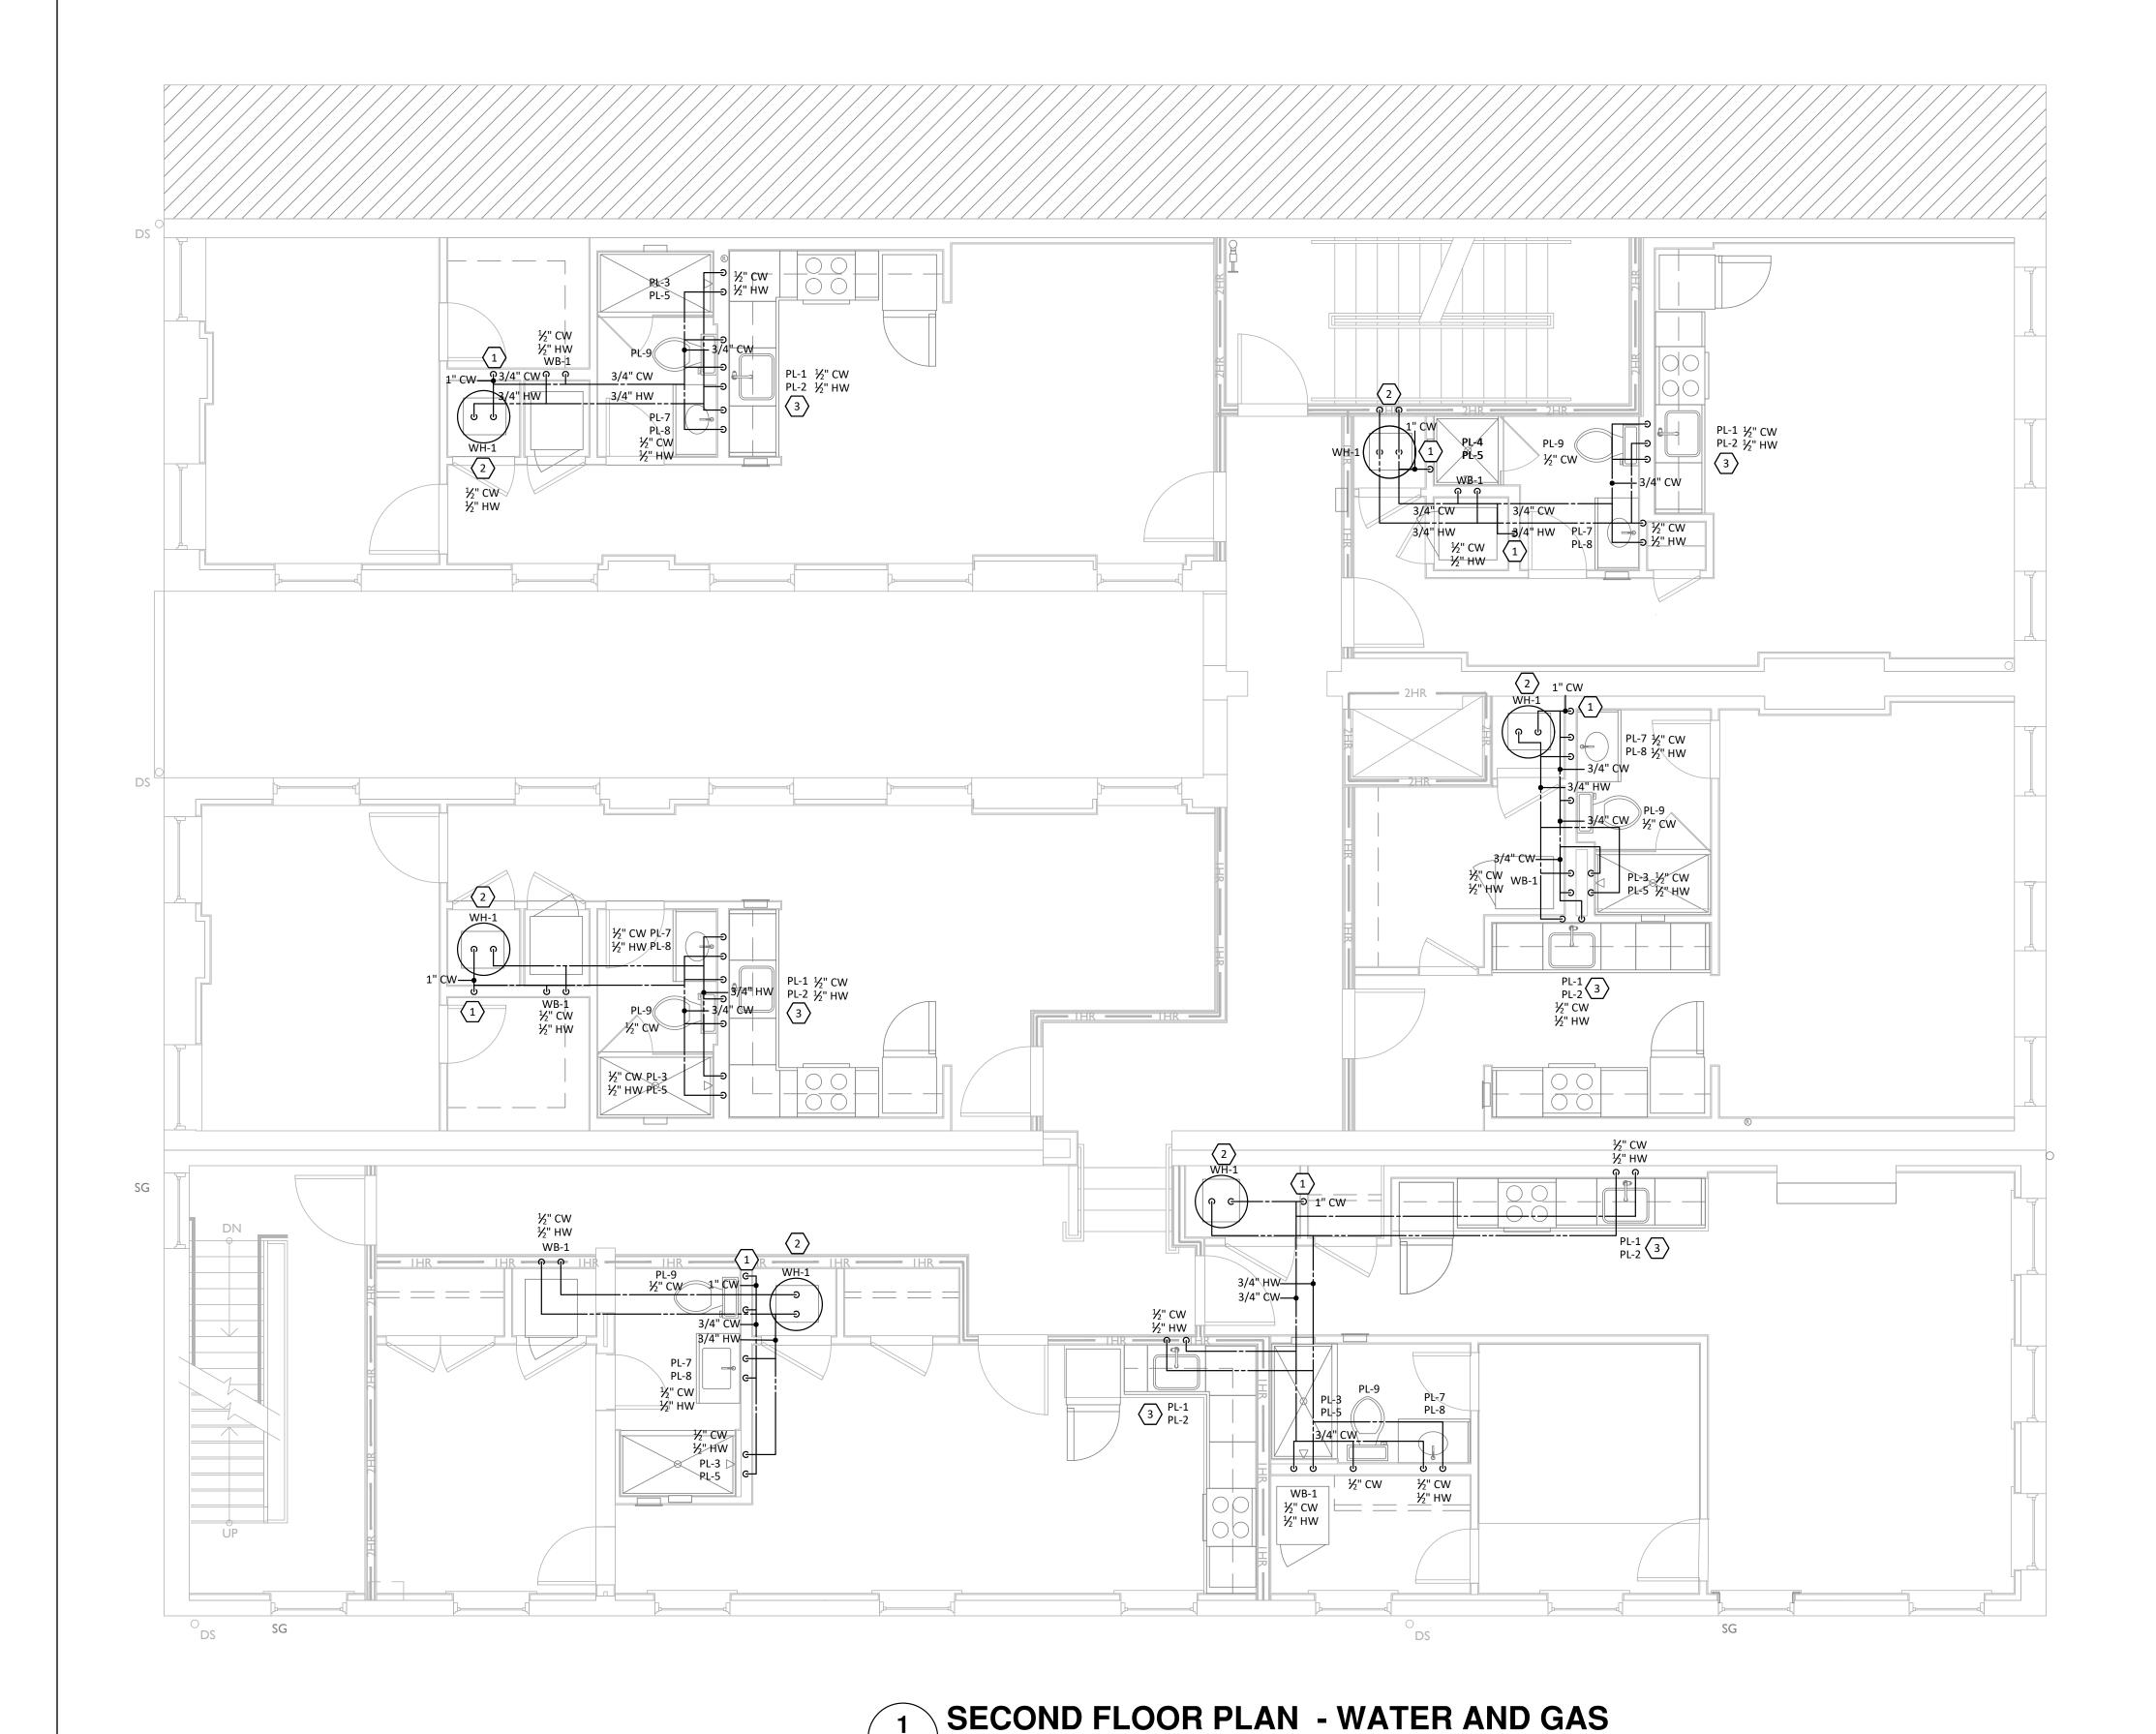
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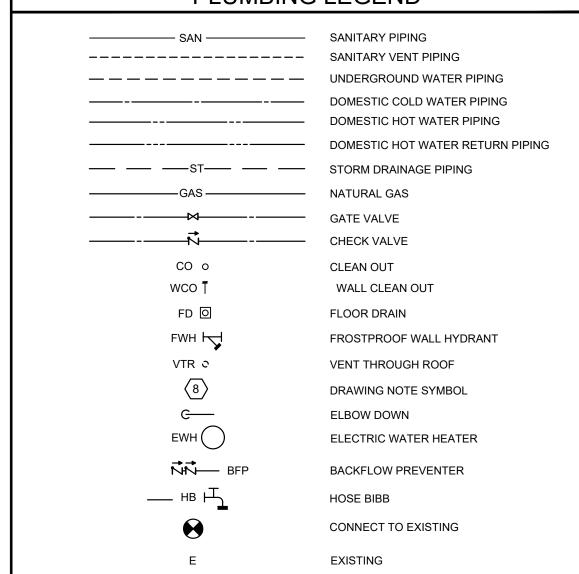


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PLUMBING LEGEND



KEYED NOTES

- DOMESTIC COLD WATER FROM BELOW AND ROUTED TO THE FLOOR ABOVE ROUTE THROUGH WALL.
- 2. PROVIDE NEW ELECTRIC WATER HEATER PER MANUFACTURER'S INSTRUCTIONS. ROUTE RELIEF AND DRAIN PAN PIPING TO FLOOR DRAIN.
- 3. ROUTE HOT WATER LINE AND DRAIN LINE WITH DISHWASHER TEE FROM SINK.

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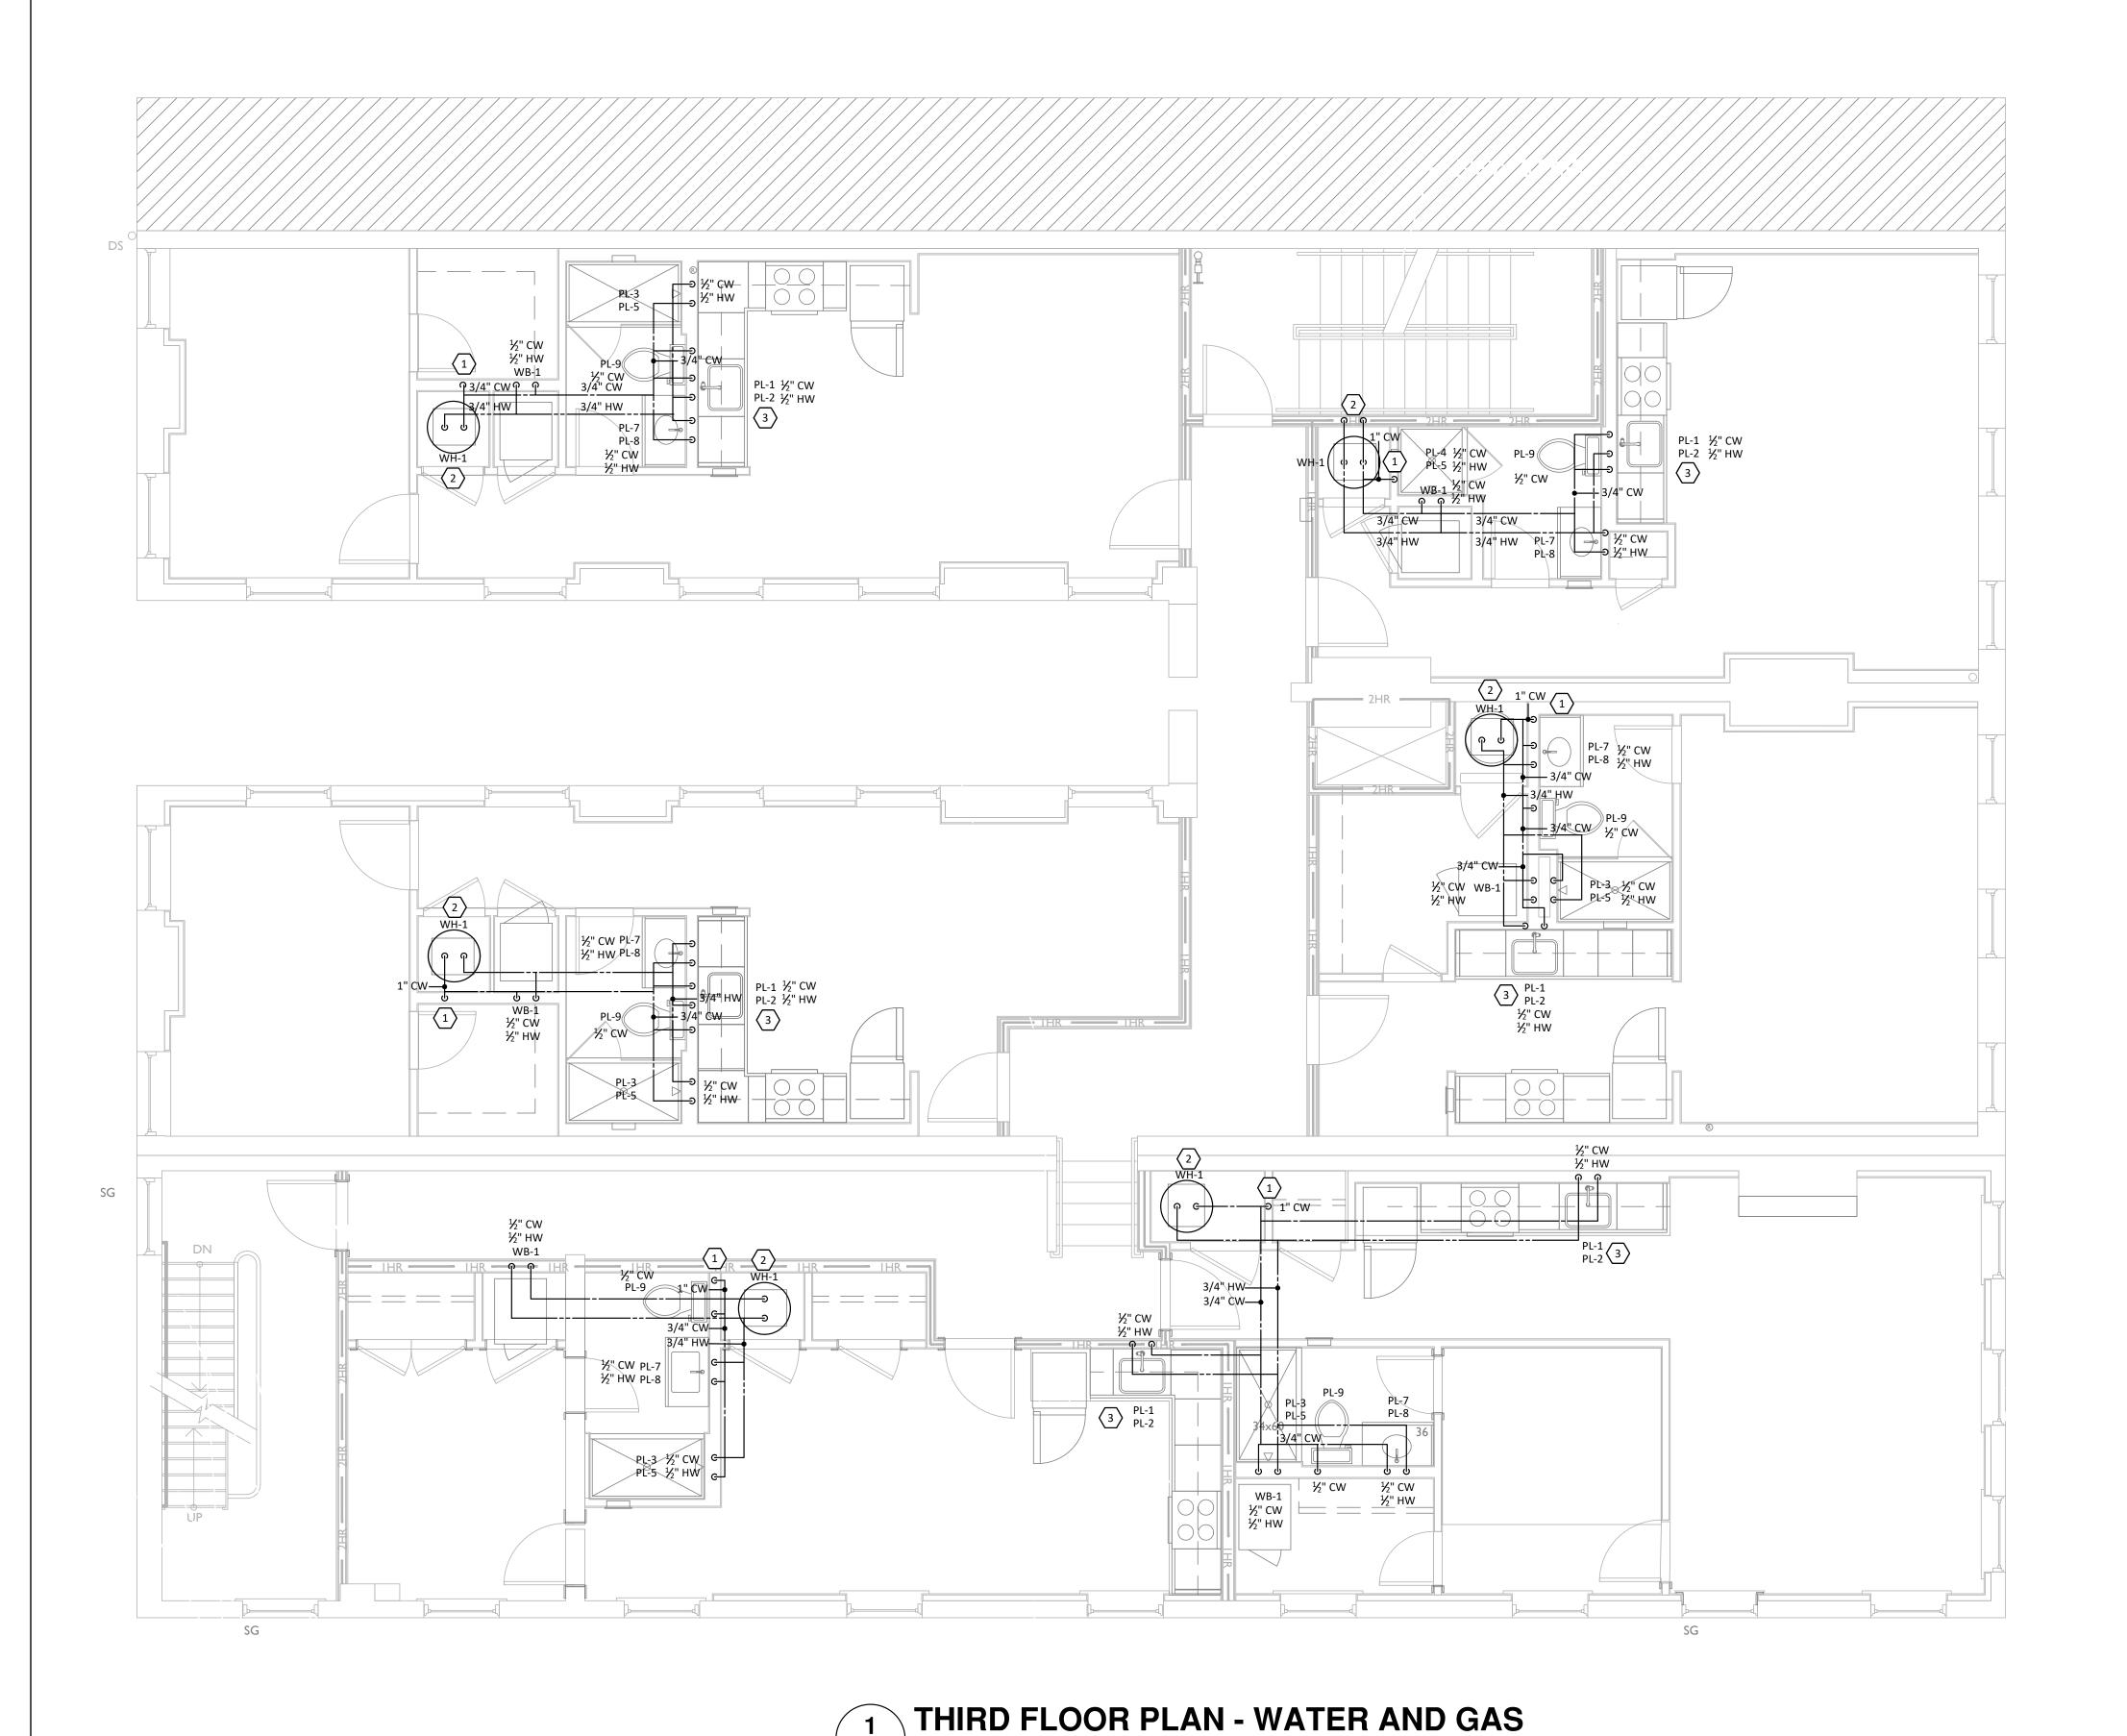
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Drawn by:
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- G. OBTAIN WRITTEN APPROVAL FROM THE ENGINEER BEFORE REUSING ANY EXISTING EQUIPMENT, COMPONENTS OR OPENINGS.
- H. INSULATE PLUMBING LINES IN EXTERIOR WALLS TO PREVENT FREEZING.
- I. COORDINATE ROOF WORK WITH ROOFING CONTRACTOR TO ASSURE THAT THE ROOF WARRANTY IS NOT VOIDED.

PLUMBING LEGEND

---- SANITARY VENT PIPING — — — — — — UNDERGROUND WATER PIPING DOMESTIC COLD WATER PIPING ———————— DOMESTIC HOT WATER PIPING —--- DOMESTIC HOT WATER RETURN PIPING — ST— STORM DRAINAGE PIPING ——— NATURAL GAS CHECK VALVE CO o CLEAN OUT wco T WALL CLEAN OUT FD 🖸 FLOOR DRAIN FWH 😽 FROSTPROOF WALL HYDRANT VTR ٥ VENT THROUGH ROOF DRAWING NOTE SYMBOL ELBOW DOWN EWH ELECTRIC WATER HEATER NN BFP BACKFLOW PREVENTER CONNECT TO EXISTING **EXISTING**

KEYED NOTES

- DOMESTIC COLD WATER FROM BELOW AND ROUTED TO THE FLOOR ABOVE ROUTE THROUGH WALL.
- 2. PROVIDE NEW ELECTRIC WATER HEATER PER MANUFACTURER'S INSTRUCTIONS. ROUTE RELIEF AND DRAIN PAN PIPING TO FLOOR DRAIN.
- 3. ROUTE HOT WATER LINE AND DRAIN LINE WITH DISHWASHER TEE FROM SINK.

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UPDATED BY THE ENGINEER OF RECORD.



John John Tr. 79076

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Progress Dates 08.15.2022 - BID SET

Revisions

05.27.2022 - REVISION #1


3 08.18.2023 - REVISION #3

Design Team:
MARQUE ENGINEERING
Drawn by:
MARQUE ENGINEERING

ANGE

V. ELDER STREET

STREET

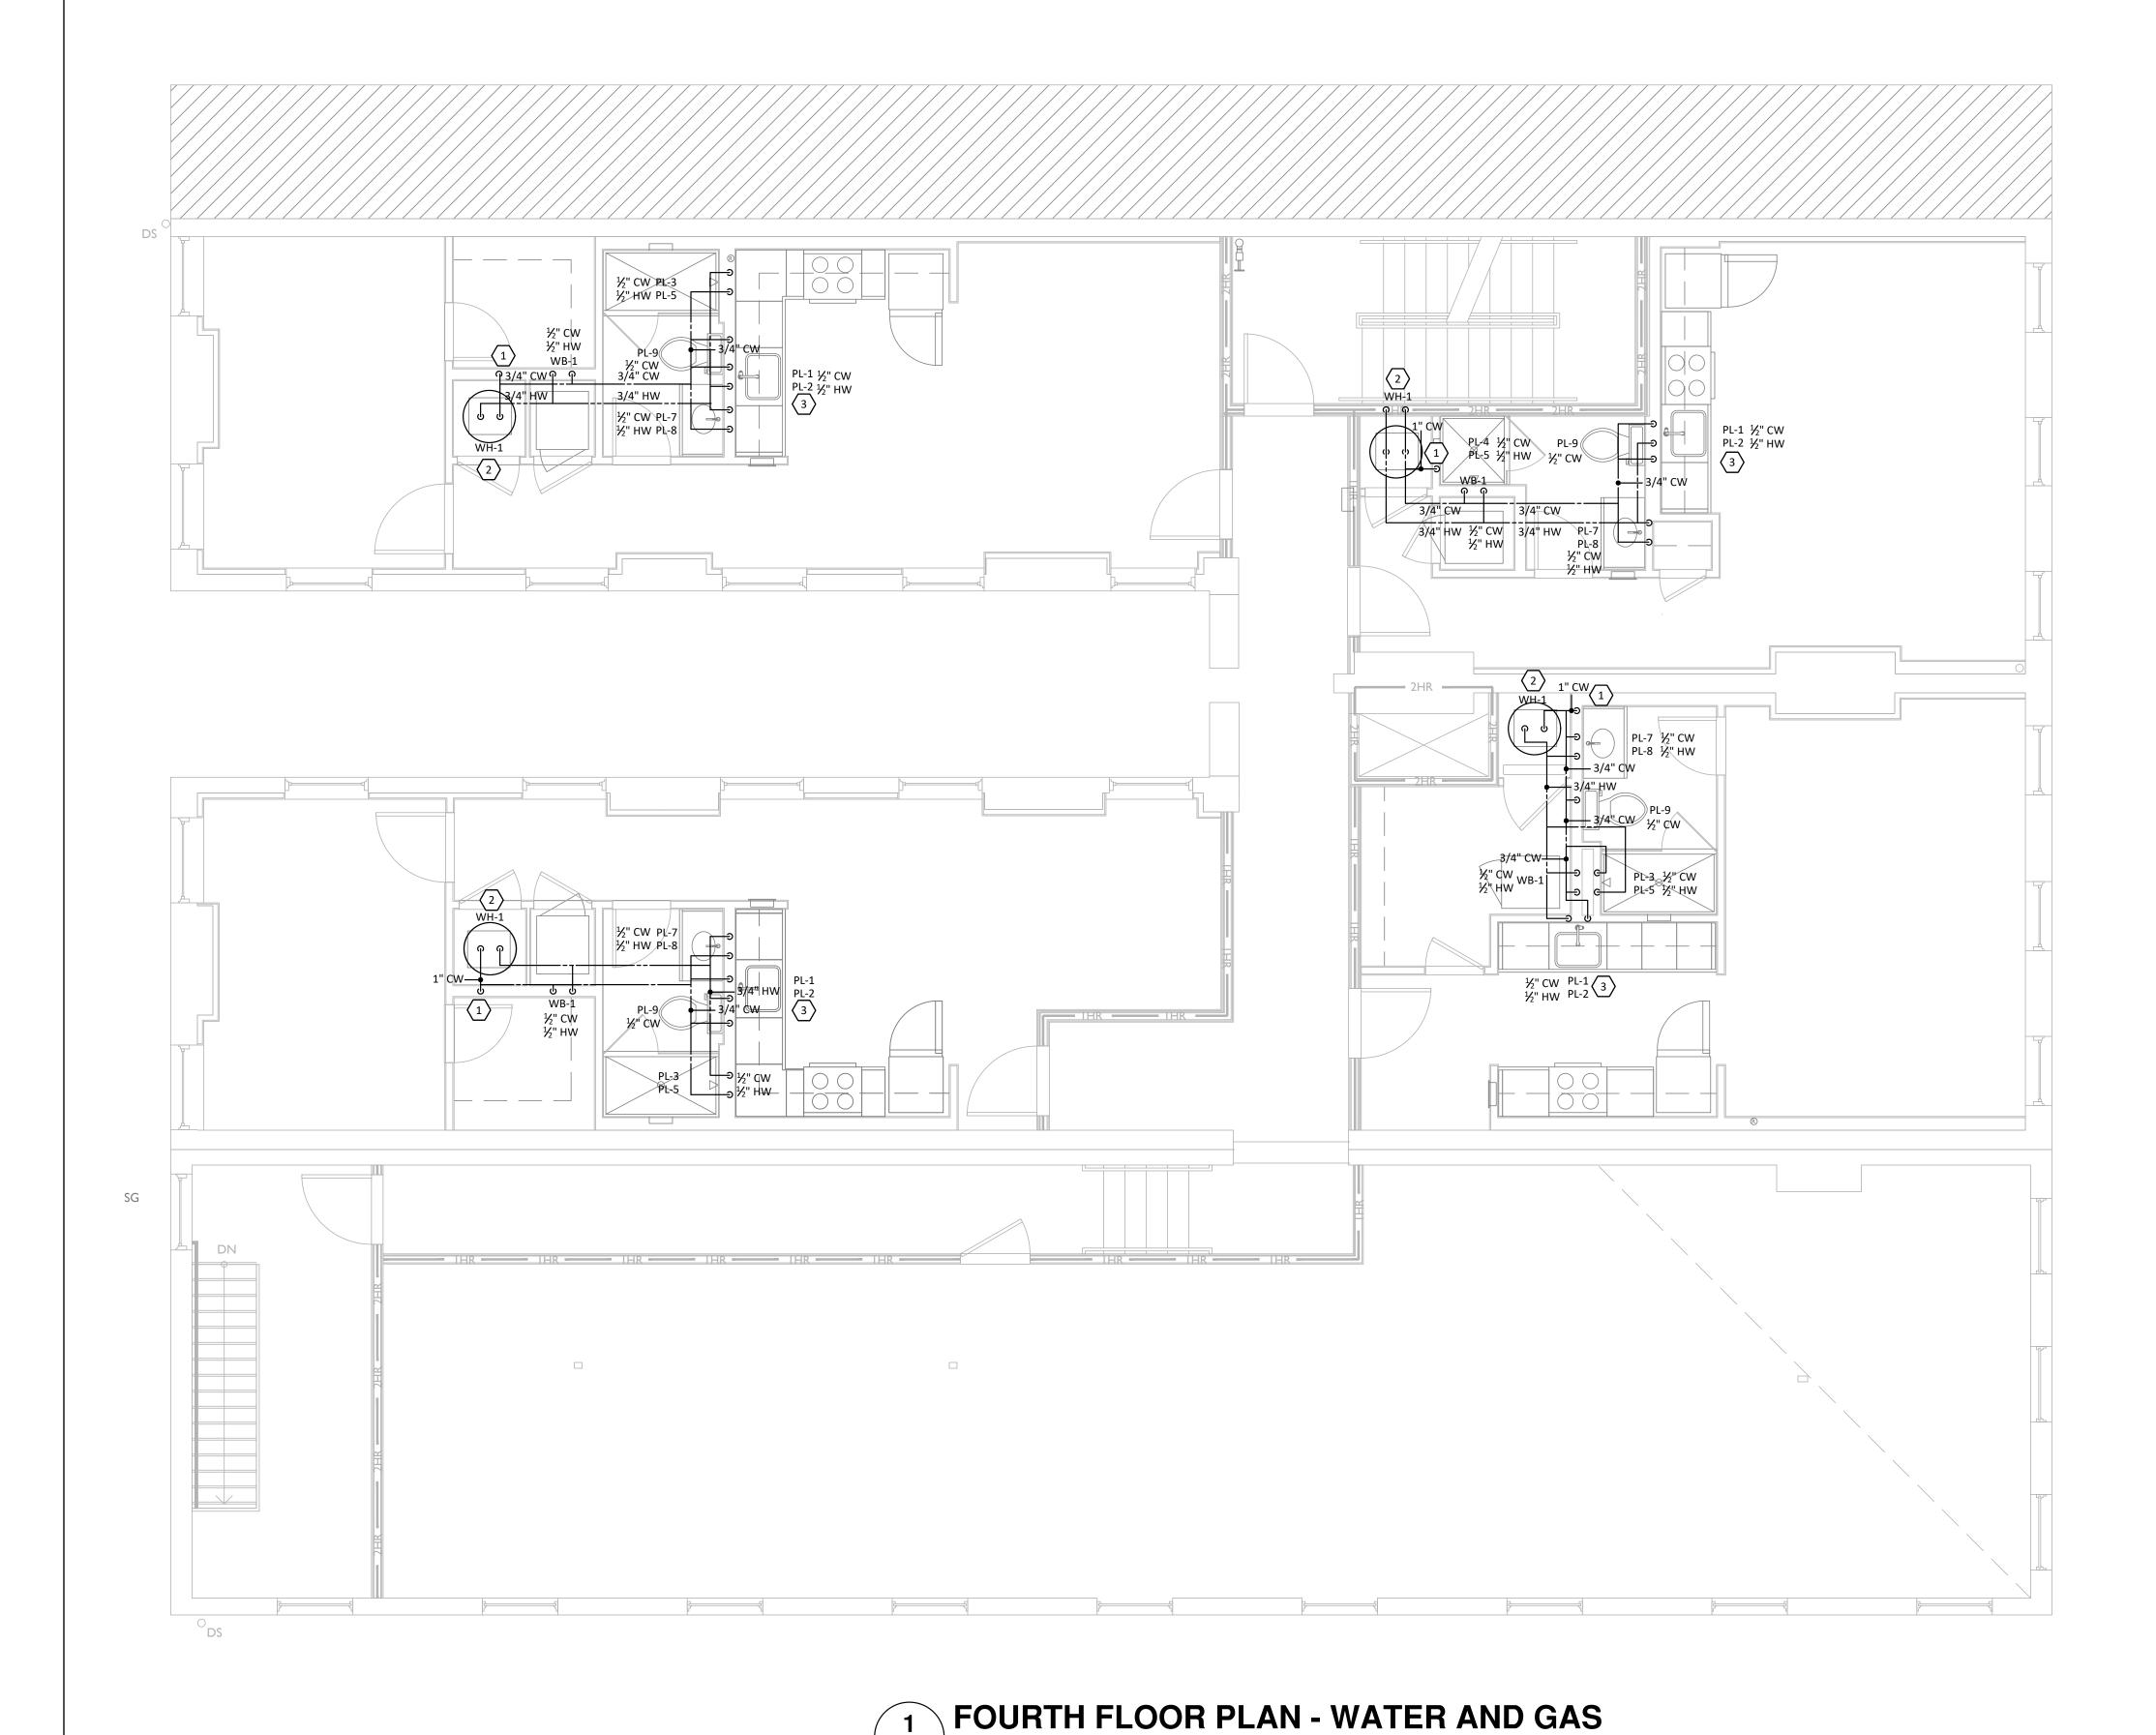


P111 1/4" = 1'-0"

GENERAL NOTES

- . FIELD VERIFY ALL EXISTING CONDITIONS PRIOR TO START OF WORK. VERIFY ALL DIMENSIONS. DRAWINGS ARE ILLUSTRATIVE AND MAY NOT REFLECT EXACT CONDITIONS OR DIMENSIONS.
- DO NOT SCALE THE DRAWINGS. DRAWINGS ARE DIAGRAMMATIC AND SHOW THE GENERAL ARRANGEMENT OF EQUIPMENT AND SYSTEMS. THEY ARE NOT INTENDED TO SHOW EVERY OFFSET, FITTING AND COMPONENT. DO NOT USE THE PLANS FOR EXACT LOCATION OF EQUIPMENT, FIXTURES OR ARCHITECTURAL ITEMS SUCH AS WALLS, WINDOWS, SOFFITS, AND PILASTERS. SPECIFIC LOCATIONS, MOUNTING HEIGHTS AND OVERALL DIMENSIONS OF DEVICES AND FIXTURES ARE TO BE OBTAINED FROM THE ARCHITECTURAL DRAWINGS AND DETAILS WHEN
- DRAWINGS SPECIFIC TO THIS TRADE DO NOT LIMIT THE RESPONSIBILITY OR WORK REQUIRED BY THE CONTRACT DOCUMENTS REFER TO DRAWINGS AND SPECIFICATIONS OF OTHER TRADES FOR COMPLETE INFORMATION PRIOR TO BID.
- WHERE CONFLICTS EXIST AMONG DRAWINGS, SPECIFICATIONS AND EQUIPMENT SCHEDULES, THE MORE STRINGENT SHALL APPLY. NOTIFY THE ENGINEER OF ALL CONFLICTS FOR RESOLUTION OR INTERPRETATION.
- NOTIFY THE OWNER IN WRITING AND FIELD VERIFY CONDITIONS BEFORE PERFORMING ANY SAWCUTTING, TRENCHING, CORING OR ANY OTHER STRUCTURAL MODIFICATIONS. INSURE THAT NO ADVERSE EFFECT TO THE BUILDING'S STRUCTURAL INTEGRITY WILL OCCUR.
- ANY EXISTING CONDITION DISCOVERED DURING THE DEMOLITION OR CONSTRUCTION PROCESS WHICH, BY GENERALLY ACCEPTED CONSTRUCTION PRACTICES, SHOULD BE REMEDIED, SHOULD BE BROUGHT TO THE ATTENTION OF THE ENGINEER/ARCHITECT IMMEDIATELY, IN WRITING.
- OBTAIN WRITTEN APPROVAL FROM THE ENGINEER BEFORE REUSING ANY EXISTING EQUIPMENT, COMPONENTS OR OPENINGS.
- . INSULATE PLUMBING LINES IN EXTERIOR WALLS TO PREVENT FREEZING.
- COORDINATE ROOF WORK WITH ROOFING CONTRACTOR TO ASSURE THAT THE ROOF WARRANTY IS NOT VOIDED.

PLUMBING LEGEND

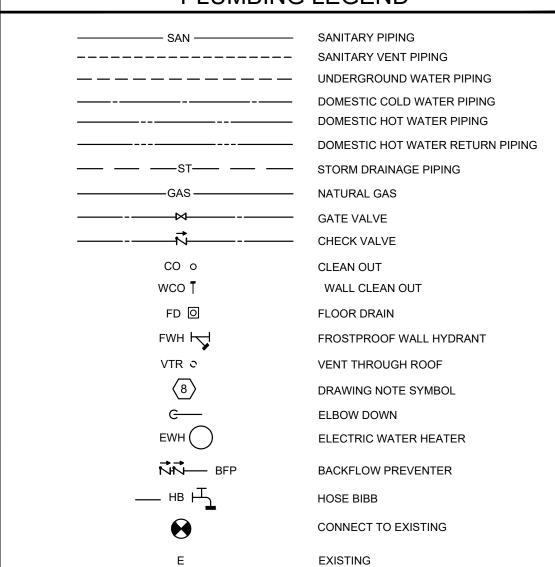


KEYED NOTES

- DOMESTIC COLD WATER FROM BELOW ROUTE THROUGH WALL.
- PROVIDE NEW ELECTRIC WATER HEATER PER MANUFACTURER'S INSTRUCTIONS. ROUTE RELIEF AND DRAIN PAN PIPING TO FLOOR DRAIN.
- ROUTE HOT WATER LINE AND DRAIN LINE WITH DISHWASHER TEE FROM SINK.

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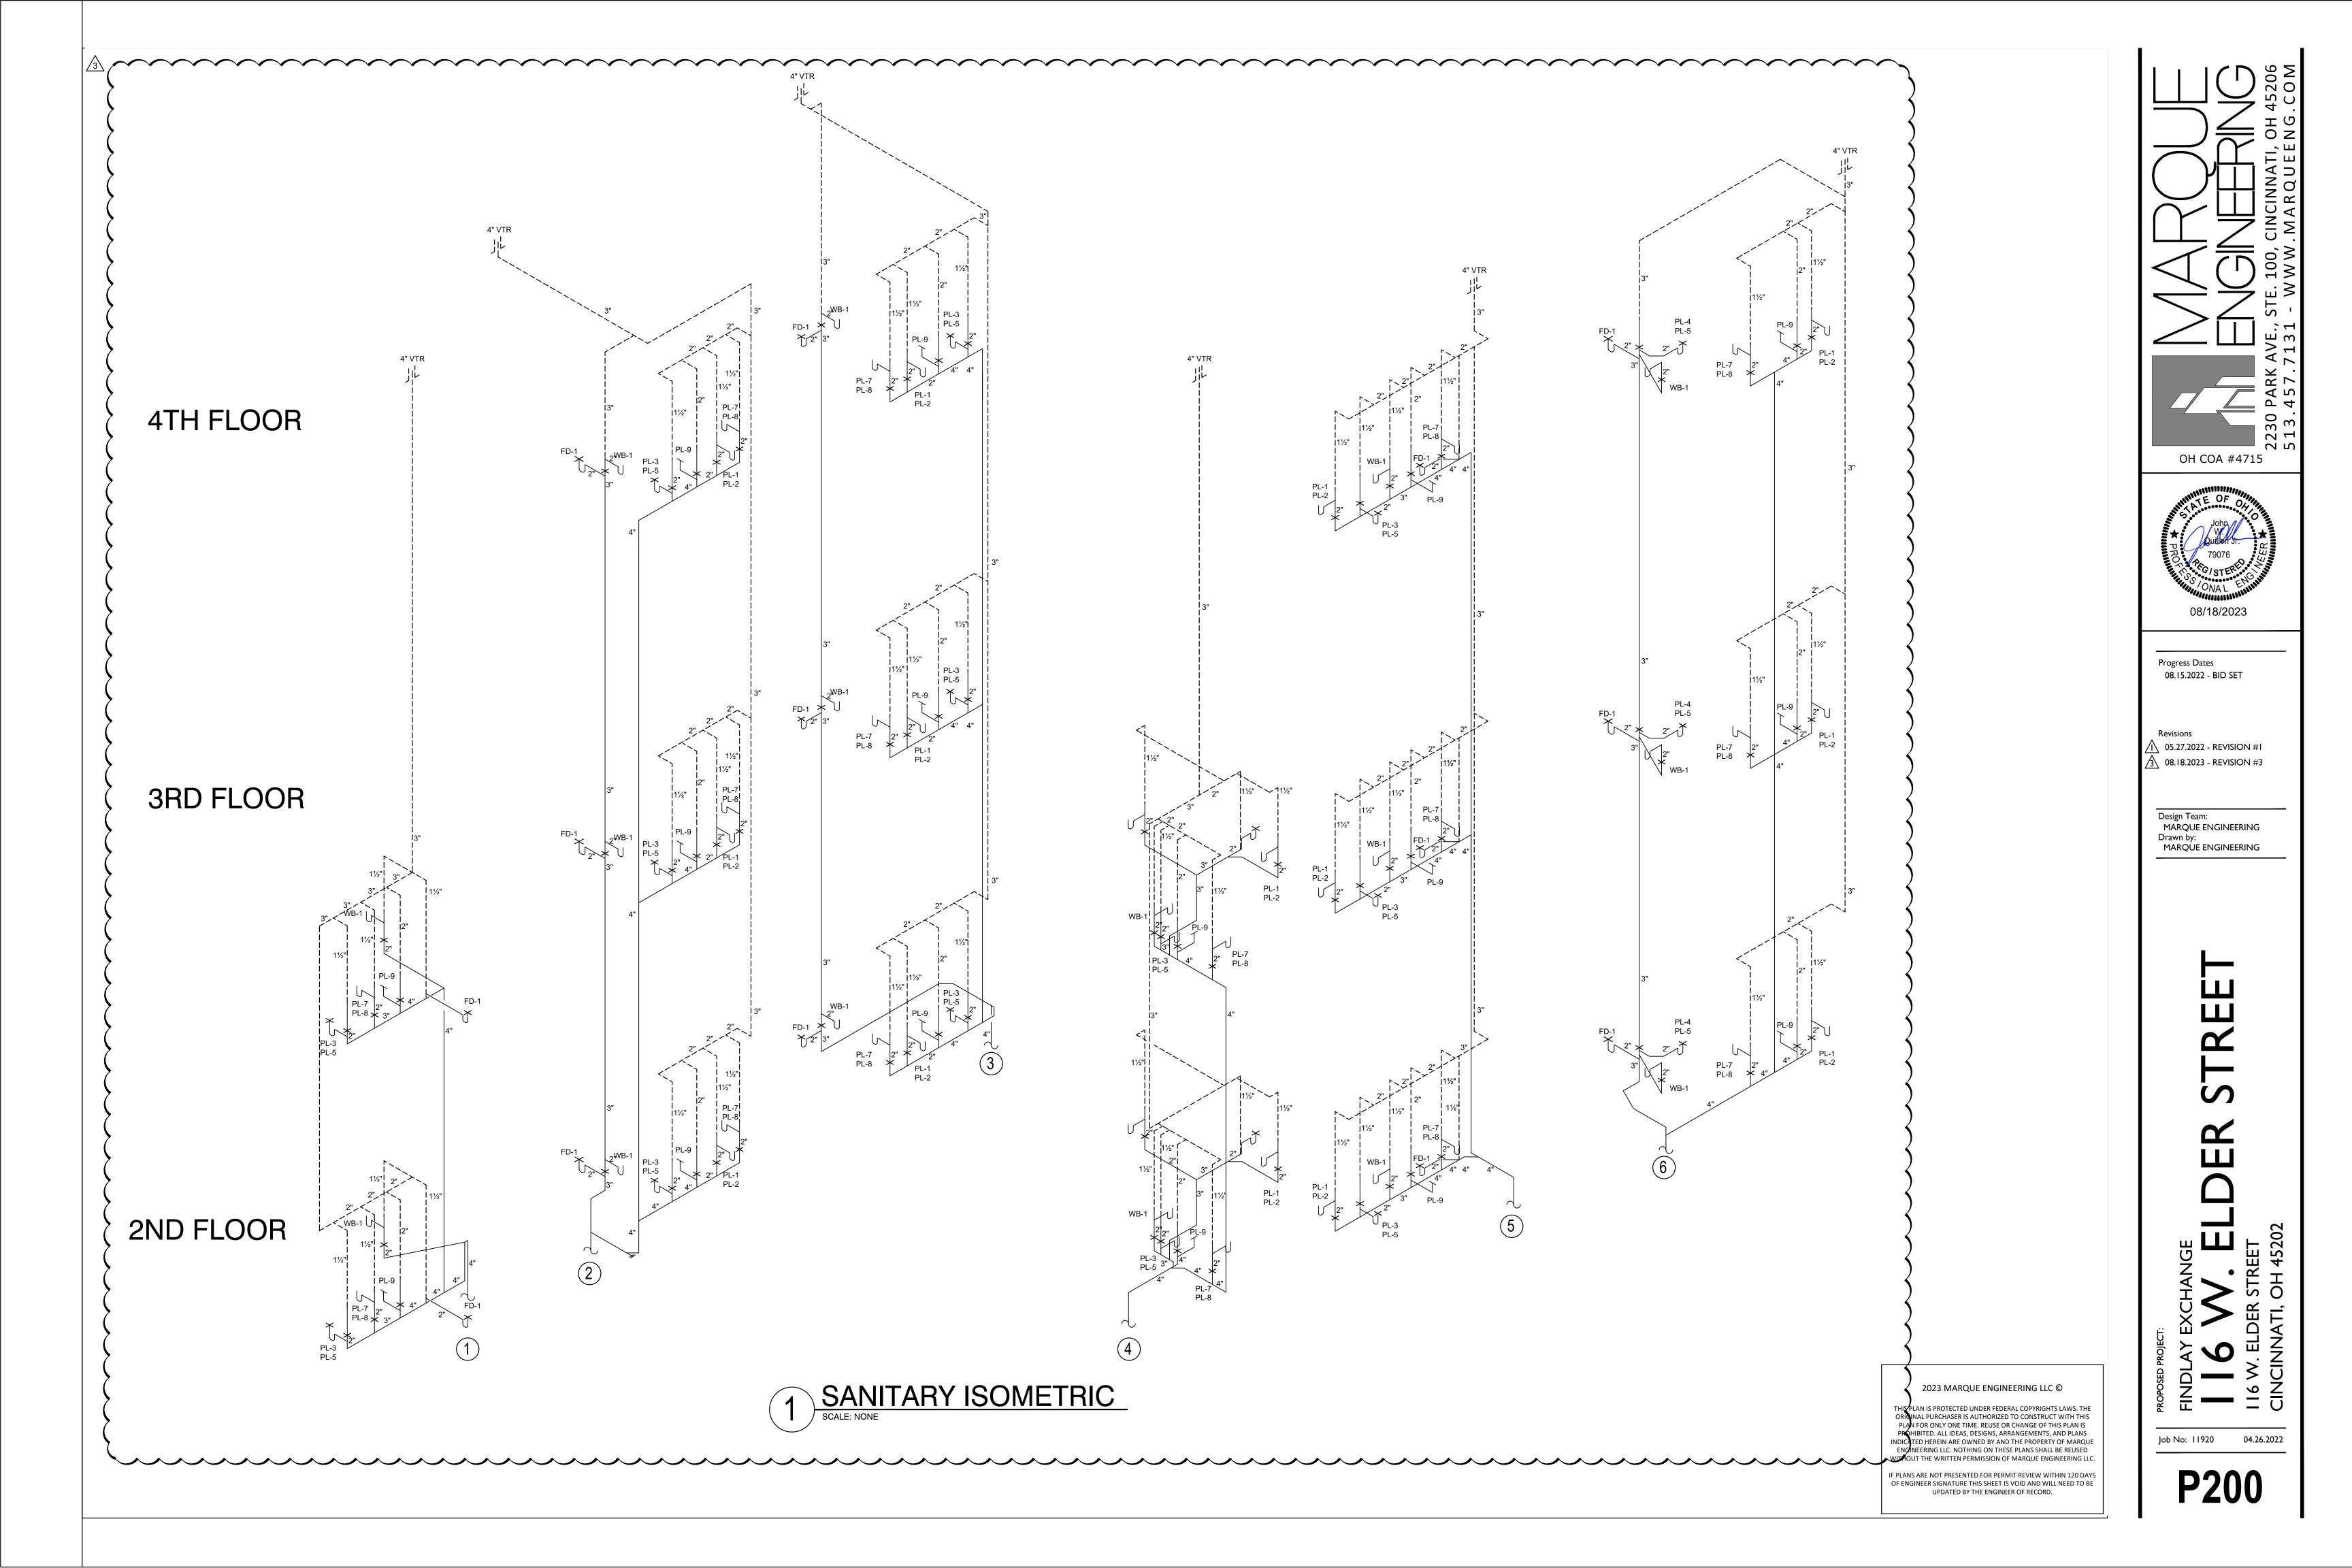
Progress Dates 08.15.2022 - BID SET

1 05.27.2022 - REVISION #1 3 08.18.2023 - REVISION #3

Design Team:
MARQUE ENGINEERING

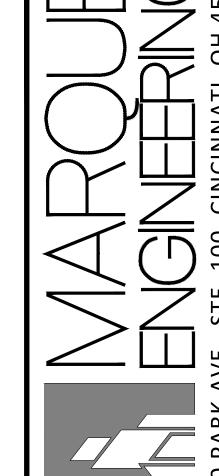MARQÚE ENGINEERING

Job No: 11920




SANITARY SIZING

1 UNIT = 14 DFU 16 UNITS TOTAL

TOTAL DFU = 16 x 14 = 224 DFU'S

224 DFU = 6" SANITARY PIPE

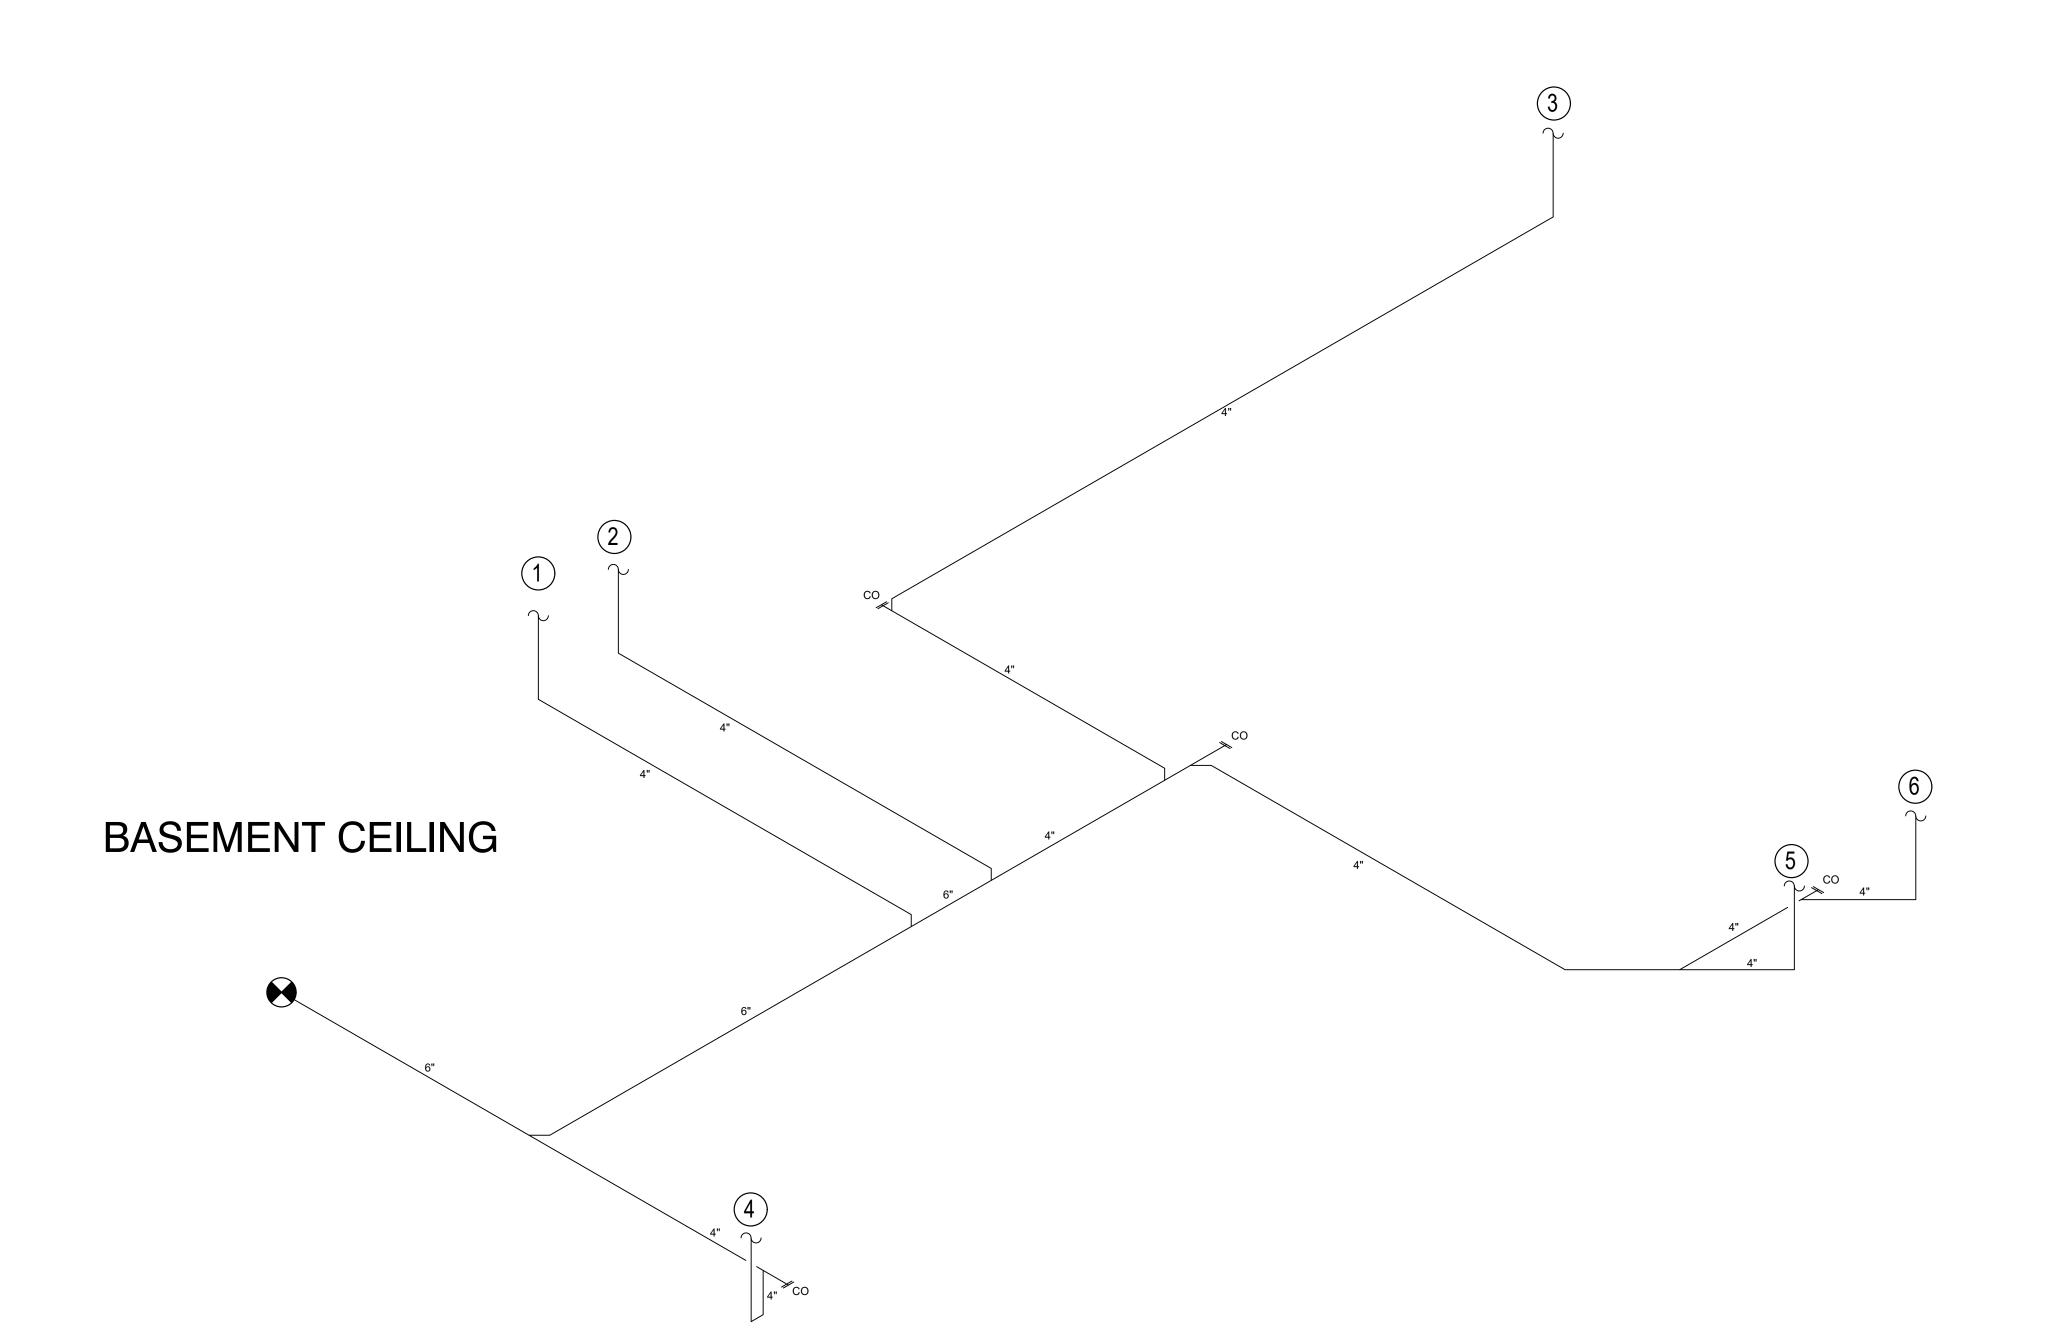

1 SANITARY ISOMETRIC (CONT.)
SCALE: NONE

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PROPOSED PROJECT:
FINDLAY EXCHANGE

| 16 W. ELDER STREET

OH COA #4715

Progress Dates 08.15.2022 - BID SET


05.27.2022 - REVISION #I
3 08.18.2023 - REVISION #3


Design Team:

MARQUE ENGINEERING

Drawn by:

MARQUE ENGINEERING

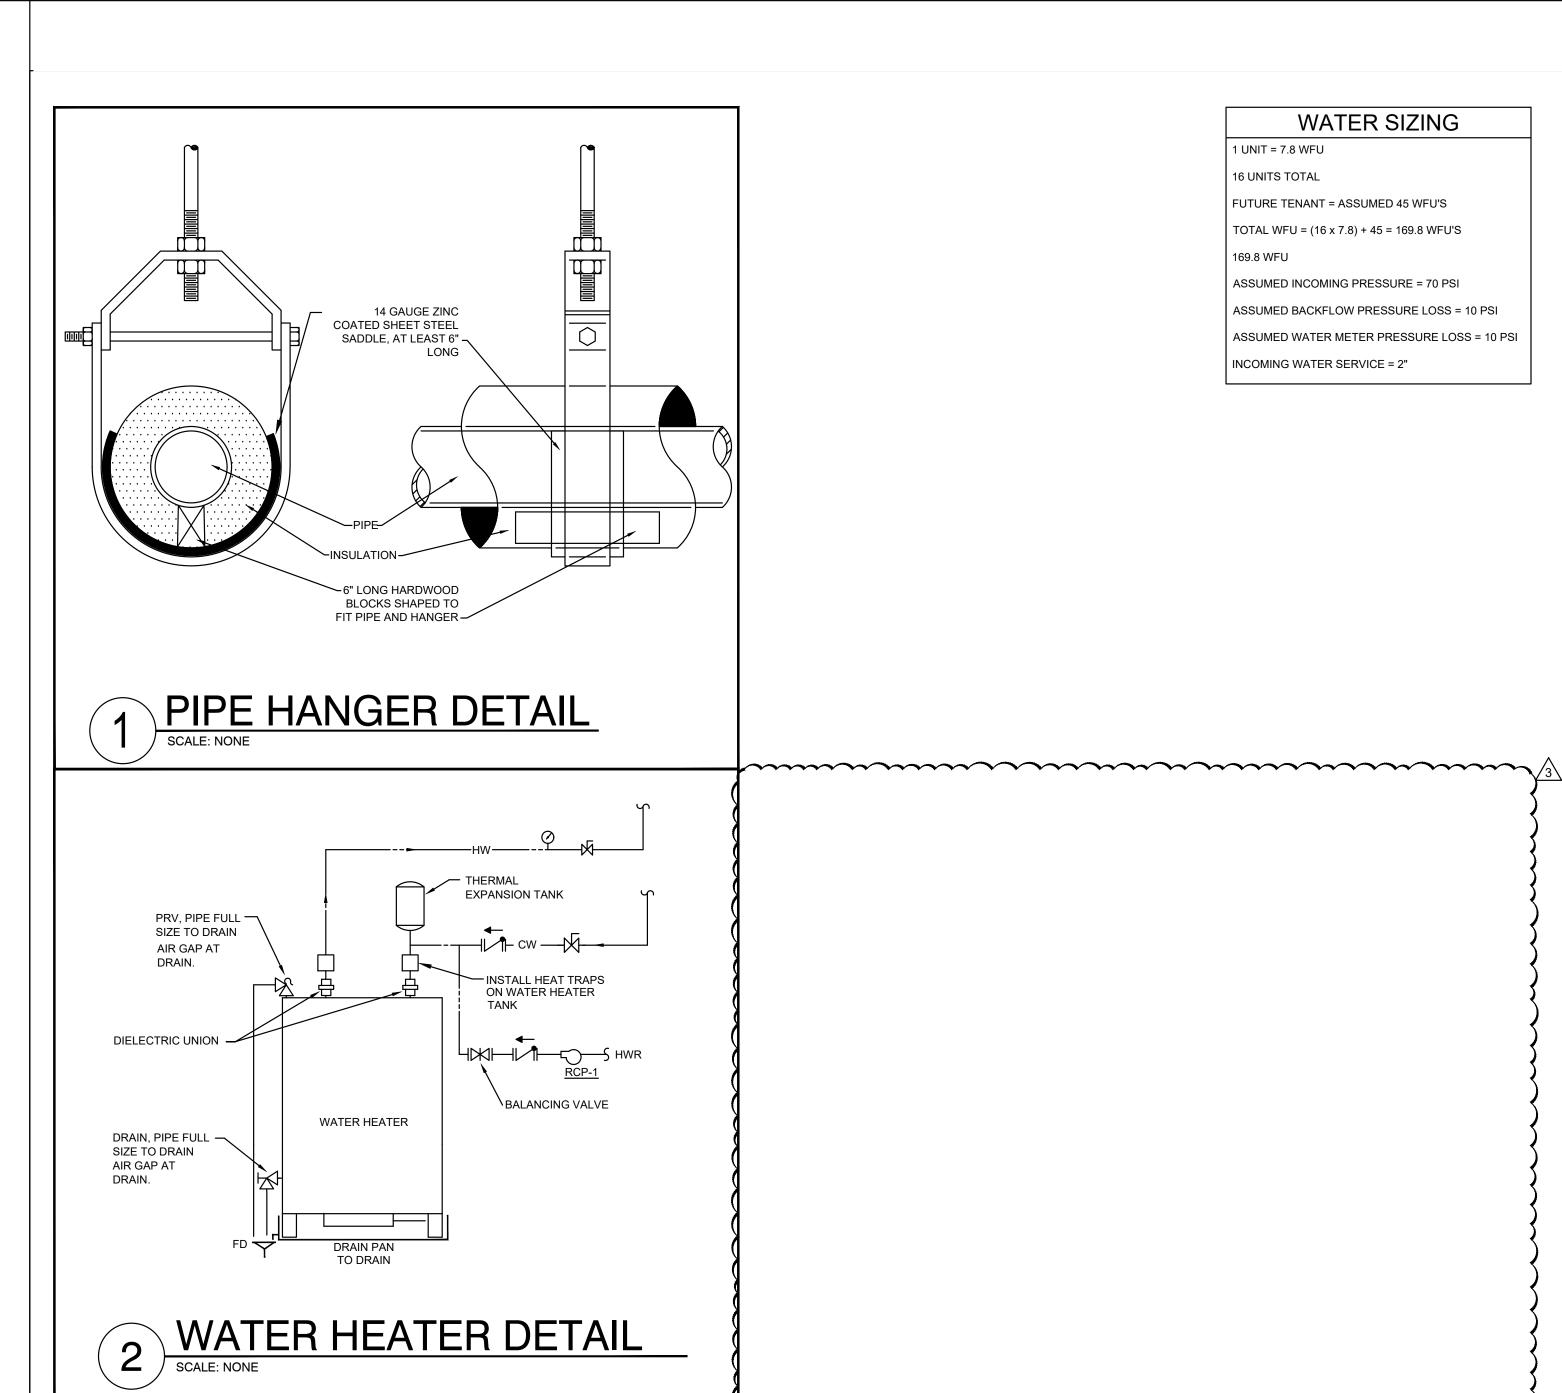

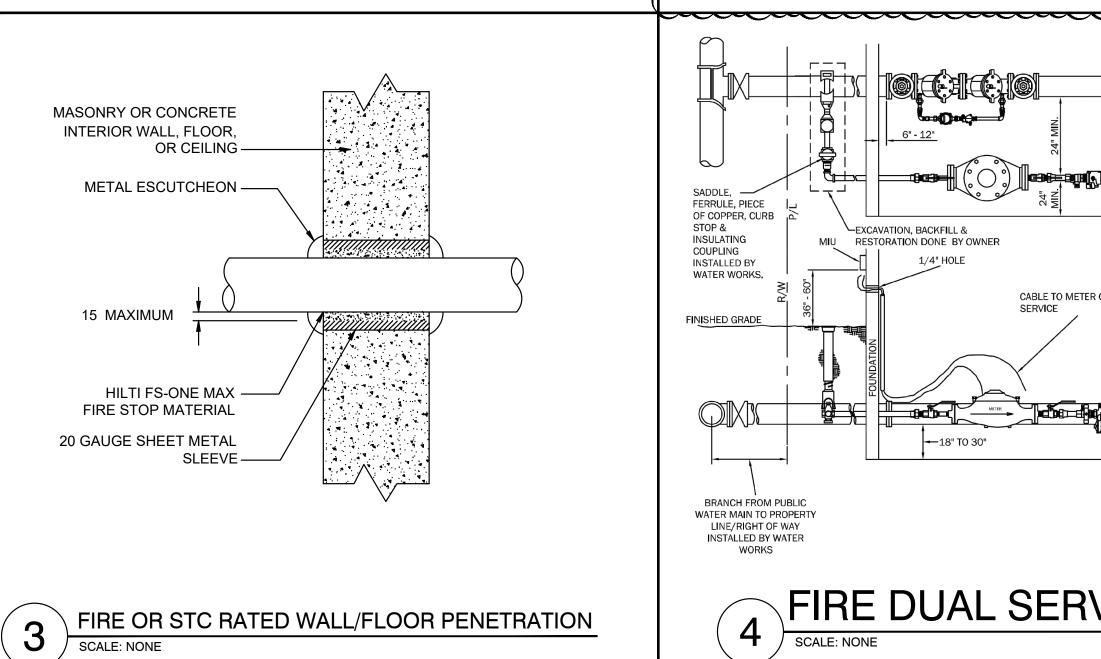

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SADDLE, FERRULE, PIECE OF COPPER, CURB STOP & INSULATING COUPLING INSTALLED BY WATER WORKS. BRANCH FROM PUBLIC WATER WORKS. BRANCH FROM PUBLIC WATER MIN D PROPERTY LINE/RIGHT OF WAY INSTALLED BY WATER WORKS	DETAILS: A) SEE 108-10 & 1E FOR MATERIAL SPECIFICATIONS AND 108-1F FOR EMR SPECIFICATIONS. B) SEE 108-9 FOR METER SETTING DETAILS. C) SEE 108-9 FOR PIPING ARRANGEMENT ON DETECTOR CHECK VALVE ASSEMBLY. D) AN INSULATING COUPLING MUST BE INSTALLED ON THE HOUSE SIDE OF THE CURB STOP. E) 24" MINIMUM CLEARANCE SHALL BE MAINTAINED BETWEEN DOMESTIC METER AND DETECTOR CHECK VALVE ASSEMBLY AND A MINIMUM OF 24" FROM ANY WALL. F) DETECTOR CHECK METER TO BE PURCHASED FROM AND INSTALLED BY GCWW. G) ANY PUMPER CONNECTION MUST BE INSTALLED ON OPPOSITE SIDE OF DETECTOR CHECK METER ASSEMBLY AND DOWNSTREAM OF OUTLET VALVE. H) A ROADWAY BOX MUST BE INSTALLED OVER DOMESTIC CORPORATION STOP. I) BLOCKING MUST BE UNDER OS & Y VALVES.
FIRE DUAL SERVICI	E DETAIL
SCALE: NONE	

WATER SIZING

FUTURE TENANT = ASSUMED 45 WFU'S

TOTAL WFU = (16 x 7.8) + 45 = 169.8 WFU'S

ASSUMED INCOMING PRESSURE = 70 PSI

INCOMING WATER SERVICE = 2"

ASSUMED BACKFLOW PRESSURE LOSS = 10 PSI

ASSUMED WATER METER PRESSURE LOSS = 10 PSI

1 UNIT = 7.8 WFU 16 UNITS TOTAL

169.8 WFU

INDERMOUNT SINK: PROFLO PLOMOSA 24" SINGLE BOWL, STAINLESS STEEL, SOUND DAMPENING. WITH PEERLESS RECEPT SINGLE HANDLE FAUCET. SHOWER: PROFLO MORENCI SERIES PFSB6034WH 60" X 34" WHITE COMPOSITE SHOWER PAN WITH PEERLESS PERCEPT SHOWER TRIM KIT. MODEL PRR188792. SHOWER: PROFLO MORENCI SERIES PFSB3636WH 36" X 36" WHITE COMPOSITE SHOWER PAN WITH PEERLESS PERCEPT SHOWER TRIM KIT. MODEL PRR188792. AVATORY: WHITE VITREOUS CHINA, UNDERMOUNT SINK, EQUAL TO KOHLER CAXTON RECTANGLE K-20000. WITH FEERLESS PRECEPT SINGLE HANDLE FAUCET P191102LF.	7 2"	1-1/2" 1-1/2" 1-1/2"	1/2" 1/2" 1/2"	1/2" 1/2" 1/2"
SHOWER TRIM KIT. MODEL PRR188792. SHOWER: PROFLO MORENCI SERIES PFSB3636WH 36" X 36" WHITE COMPOSITE SHOWER PAN WITH PEERLESS PERCEP SHOWER TRIM KIT. MODEL PRR188792. AVATORY: WHITE VITREOUS CHINA, UNDERMOUNT SINK, EQUAL TO KOHLER CAXTON RECTANGLE K-20000. WITH PEERLESS PRECEPT SINGLE HANDLE FAUCET P191102LF. WATER CLOSET: WHITE VITREOUS CHINA, FLOOR MOUNTED, ELONGATED FRONT BOWL. BOLT CAPS, 1.28	2" T 2"	1-1/2"	1/2"	1/2"
AVATORY: WHITE VITREOUS CHINA, UNDERMOUNT SINK, EQUAL TO KOHLER CAXTON RECTANGLE K-20000. WITH EERLESS PRECEPT SINGLE HANDLE FAUCET P191102LF. WATER CLOSET: WHITE VITREOUS CHINA, FLOOR MOUNTED, ELONGATED FRONT BOWL. BOLT CAPS, 1.28	2"			
VATER CLOSET: WHITE VITREOUS CHINA, FLOOR MOUNTED, ELONGATED FRONT BOWL. BOLT CAPS, 1.28	2"	1-1/2"	1/2"	1/2"
GALLONS/FLUSH, EQUAL TO MANSFIELD ALTO 135-3173. 4" FLUSH VALVE. WITH OPEN FRONT WHITE SEAT LESS COVER. SUPPLY WITH STOP.	4"	2"	1/2"	-
AVATORY: PROFLO PF5414WH WALL MOUNT SINK, 19.5" X 17" BASE WITH AMERICAN STANDARD RELIANT SINGLE IANDLE FAUCET 7385007.002. MOUNT AT BARRIER FREE HEIGHT. MEETS ADA GUIDELINES.	1-1/2"	1-1/2"	1/2"	1/2"
CLEAN OUT: SIOUX CHIEF ON GRADE ADJUSTABLE CLEAN OUT 834-PNR. PVC BASE ADAPTER. ROUND NICKEL-BRONZE COVER.	-	-	1	1
ELECTRIC WATER HEATER: EQUAL TO A.O. SMITH DURA-POWER DEN-30, 4500 WATT ELECTRIC ELEMENT, 208V/1P. 30 SALLON STORAGE TANK, 20 GPH RECOVERY @ 90° TEMPERATURE RISE, 118 LBS, 49-3/4" HEIGHT, 20-1/2" DIAMETER.			1"	1"
LOOR DRAIN: SIOUX CHIEF FINISH LINE 832-2PNRV. 2" CONNECTION SIZE, PVC BASE ADAPTER, ROUND NICKEL-BRONZE STRAINER WITH 863-FN NICKEL-BRONZE CONDENSATE FUNNEL, VANDAL RESISTANT STRAINER SCREWS. PROVIDE TRAP PRIMER AS REQUIRED BY LOCAL CODE.	2"	1-1/2"	-	-
	EAN OUT: SIOUX CHIEF ON GRADE ADJUSTABLE CLEAN OUT 834-PNR. PVC BASE ADAPTER. ROUND NICKEL-BRONZE VER. ECTRIC WATER HEATER: EQUAL TO A.O. SMITH DURA-POWER DEN-30, 4500 WATT ELECTRIC ELEMENT, 208V/1P. 30 LLON STORAGE TANK, 20 GPH RECOVERY @ 90° TEMPERATURE RISE, 118 LBS, 49-3/4" HEIGHT, 20-1/2" DIAMETER. DOR DRAIN: SIOUX CHIEF FINISH LINE 832-2PNRV. 2" CONNECTION SIZE, PVC BASE ADAPTER, ROUND NICKEL-BRONZE RAINER WITH 863-FN NICKEL-BRONZE CONDENSATE FUNNEL, VANDAL RESISTANT STRAINER SCREWS. PROVIDE TRAP	AN OUT: SIOUX CHIEF ON GRADE ADJUSTABLE CLEAN OUT 834-PNR. PVC BASE ADAPTER. ROUND NICKEL-BRONZE VER. ECTRIC WATER HEATER: EQUAL TO A.O. SMITH DURA-POWER DEN-30, 4500 WATT ELECTRIC ELEMENT, 208V/1P. 30 LLON STORAGE TANK, 20 GPH RECOVERY @ 90° TEMPERATURE RISE, 118 LBS, 49-3/4" HEIGHT, 20-1/2" DIAMETER. DORD DRAIN: SIOUX CHIEF FINISH LINE 832-2PNRV. 2" CONNECTION SIZE, PVC BASE ADAPTER, ROUND NICKEL-BRONZE RAINER WITH 863-FN NICKEL-BRONZE CONDENSATE FUNNEL, VANDAL RESISTANT STRAINER SCREWS. PROVIDE TRAP IMER AS REQUIRED BY LOCAL CODE.	NDLE FAUCET 7385007.002. MOUNT AT BARRIER FREE HEIGHT. MEETS ADA GUIDELINES. 1-1/2" 1-1/2" 1-1/2" EAN OUT: SIOUX CHIEF ON GRADE ADJUSTABLE CLEAN OUT 834-PNR. PVC BASE ADAPTER. ROUND NICKEL-BRONZE VER. ECTRIC WATER HEATER: EQUAL TO A.O. SMITH DURA-POWER DEN-30, 4500 WATT ELECTRIC ELEMENT, 208V/1P. 30 LLON STORAGE TANK, 20 GPH RECOVERY @ 90° TEMPERATURE RISE, 118 LBS, 49-3/4" HEIGHT, 20-1/2" DIAMETER. DORD DRAIN: SIOUX CHIEF FINISH LINE 832-2PNRV. 2" CONNECTION SIZE, PVC BASE ADAPTER, ROUND NICKEL-BRONZE RAINER WITH 863-FN NICKEL-BRONZE CONDENSATE FUNNEL, VANDAL RESISTANT STRAINER SCREWS. PROVIDE TRAP IMER AS REQUIRED BY LOCAL CODE.	NDLE FAUCET 7385007.002. MOUNT AT BARRIER FREE HEIGHT. MEETS ADA GUIDELINES. 1-1/2" 1

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OH COA #4715

08/18/2023

Progress Dates

08.15.2022 - BID SET

↑ 05.27.2022 - REVISION #I

3 08.18.2023 - REVISION #3

Design Team:

MARQUE ENGINEERING

Drawn by:

MARQUE ENGINEERING

22 05 00 COMMON WORK RESULTS FOR PLUMBING

ALL PLUMBING WORK AND TESTS SHALL BE DONE IN STRICT ACCORDANCE WITH THE LATEST STATE, COUNTY, AND LOCAL REGULATIONS, LAWS, AND ORDINANCES WHICH MAY BE

BEFORE SUBMITTING A BID, EXAMINE DOCUMENTS OF ALL OTHER TRADES, VISIT THE SITE AND GET ACQUAINTED WITH ALL CONDITIONS THAT MAY IN ANY WAY AFFECT THE EXECUTION OF THIS CONTRACT. TAKE MEASUREMENTS AND BE RESPONSIBLE FOR EXACT SIZE AND LOCATIONS OF ALL OPENINGS REQUIRED. VERIFY INSTALLATION MAY BE MADE IN COMPLETE ACCORDANCE WITH ALL PERTINENT CODES AND REGULATIONS. IN THE EVENT OF DISCREPANCY, IMMEDIATELY NOTIFY THE PROFESSIONAL ENGINEER OF RECORD. DO NOT PROCEED WITH THE INSTALLATION IN AREAS OF DISCREPANCY UNTIL ALL SUCH DISCREPANCIES

IT IS NOT THE INTENT OF THE DRAWINGS THAT EXISTING CONDITIONS BE ACCURATELY SHOWN. EXISTING PLUMBING WORK IS SHOWN TO LIMITED EXTENT ON DRAWINGS AND IS SHOWN FOR GENERAL REFERENCE ONLY, LOCATIONS AND INFORMATION WERE DERIVED FROM CURSORY SITE VISUAL OBSERVATIONS OR FROM DOCUMENTS THAT WERE PREPARED FOR PREVIOUSLY

THE WORK COVERED BY THESE SPECIFICATIONS SHALL CONSIST OF PROVIDING ALL NEW MATERIAL, LABOR, EQUIPMENT, AND SERVICES NECESSARY FOR A COMPLETE PLUMBING INSTALLATION AS SPECIFIED HEREIN. WORK IN THIS SECTION INCLUDES, BUT IS NOT LIMITED TO THE FOLLOWING ITEMS:

PLUMBING FIXTURES

WHENEVER THE WORDS "CONTRACTOR" APPEAR ON PLUMBING DRAWINGS OR IN THESE SPECIFICATIONS, IT SHALL REFER TO THE PLUMBING SUB-CONTRACTOR. WHENEVER THE WORD "PROVIDE" APPEARS IN THESE DOCUMENTS, IT SHALL BE INTERPRETED TO MEAN "FURNISH

COORDINATE ALL WORK WITH THE OWNER TO MINIMIZE INTERRUPTION OF BUILDING

COORDINATE THE INSTALLATION OF PLUMBING ITEMS WITH THE SCHEDULES FOR WORK OF ALL OTHER TRADES TO PREVENT UNNECESSARY DELAYS IN THE TOTAL WORK.

THIS CONTRACTOR SHALL VERIFY AND SATISFY HIMSELF THAT ALL EQUIPMENT FURNISHED WILL PROPERLY FIT IN THE SPACE PROVIDED. THAT IT WILL FUNCTION PROPERLY, AND THAT ALL PARTS OF EQUIPMENT REQUIRING SERVICE ARE READILY ACCESSIBLE.

ALL PIPING SHALL BE RUN PARALLEL OR PERPENDICULAR TO BUILDING WALLS AND FRAMING SYSTEM. ALL VERTICAL RUNS SHALL BE HELD AGAINST WALLS, COLUMNS, ETC., AS POSSIBLE TO

CONTRACTOR SHALL PROVIDE A GUARANTEE IN WRITTEN FORM STATING THAT ALL WORK SHALL BE FREE OF DEFECTS OR ERRORS, AND ALL EQUIPMENT, MATERIALS, OR PARTS FOR A PERIOD OF ONE YEAR FROM THE DATE OF OWNER'S FINAL ACCEPTANCE AND SHALL REPAIR, REVISE OR REPLACE AT NO COST TO THE OWNER ANY SUCH DEFECTS OCCURRING WITHIN THE GUARANTEE PERIOD.

CONTRACTOR SHALL ALSO STATE IN WRITTEN FORM THAT ANY ITEMS OR OCCURRENCES ARISING DURING THE GUARANTEE PERIOD WILL BE ATTENDED TO IN A TIMELY MANNER AND

WILL IN NO CASE EXCEED THREE (3) WORKING DAYS FROM DATE OF NOTIFICATION BY OWNER. PROVIDE A COMPLETE INSTALLATION IN CONFORMANCE WITH THE FOLLOWING STANDARDS:

ASPE: AMERICAN SOCIETY OF PLUMBING ENGINEERS NFPA: NATIONAL FIRE PROTECTION ASSOCIATION

STATEWIDE BUILDING CODE INTERNATIONAL PLUMBING CODE

AGA: AMERICAN GAS ASSOCIATION

CONTRACTOR SHALL DO ALL CUTTING AND PATCHING REQUIRED FOR INSTALLATION OF THIS WORK. ALL OPENINGS IN WALLS, FLOORS OR CEILINGS SHALL BE PROPERLY SEALED AND RESTORED IN KIND. FLASH AND COUNTERFLASH AT ROOF OPENINGS.

ALL EQUIPMENT SHALL BE LISTED AND LABELED, UNLESS OTHERWISE APPROVED.

ALL WIRING SHALL MEET THE REQUIREMENTS LISTED IN THE ELECTRICAL SPECIFICATIONS. ALL CONTROL AND INTERLOCK WIRING AND CONDUIT (120V OR 24V) SHALL BE BY THE PLUMBING

EQUIPMENT SHALL BE INSTALLED IN ACCORDANCE WITH THE CONDITIONS OF LISTING AND THE MANUFACTURER'S INSTALLATION INSTRUCTIONS AND THIS CODE.

CLEANING: THIS CONTRACTOR SHALL REMOVE FROM THE PREMISES ALL ACCUMULATION OF DIRT, DEBRIS, WASTE MATERIALS AND RUBBISH CAUSED BY HIS EMPLOYEES OR WORK, AT LEAST ONCE A WEEK, EXCEPT THAT COMBUSTIBLE MATERIALS SHALL BE REMOVED DAILY.

DURING PROGRESS OF THE WORK. MAINTAIN ON DRAWINGS AT THE SITE. AN ACCURATE RECORD OF THE INSTALLATION OF THE MECHANICAL SYSTEM, INDICATING ALL ITEMS WHICH HAVE BEEN CHANGED OR ADDED.

APPLY FOR AND PAY FOR ALL PERMITS AND INSPECTIONS REQUIRED BY LOCAL AUTHORITY, FOR

A CERTIFICATE OF FINAL INSPECTION AND APPROVAL SHALL BE SUBMITTED WITH THE

CONTRACTOR'S REQUEST FOR FINAL PAYMENT. NO FINAL PAYMENT WILL BE APPROVED WITHOUT THIS CERTIFICATE.

GUARANTEE ALL WORKMANSHIP, MATERIAL, AND EQUIPMENT AND REPLACE ANY FOUND DEFECTIVE WORK WITHOUT COST TO THE OWNER, FOR A PERIOD OF ONE YEAR AFTER FINAL

DO NOT REUSE REMOVED PLUMBING MATERIALS UNLESS SPECIFICALLY INDICATED ON DRAWINGS. EXISTING SYSTEMS MAY BE UTILIZED ONLY TO THE EXTENT INDICATED ON

IF REQUIRED TO ACCOMMODATE CONSTRUCTION RELATED ACTIVITIES TEMPORARILY REMOVE, STORE IN PROTECTED LOCATION ON SITE, AND REINSTALL CONFLICTING PLUMBING EQUIPMENT, OR DEVICES THAT ARE TO REMAIN OR TO BE RELOCATED.

WHERE THE TERM "DEMOLITION" IS USED HEREIN, INTERPRET IT TO MEAN "DEMOLITION" OR "SELECTIVE DEMOLITION" WHERE APPLICABLE.

PROVIDE PLUMBING DEMOLITION WORK AS REQUIRED TO ACCOMMODATE PROJECT DEMOLITION AND AS REQUIRED TO ACCOMMODATE NEW CONSTRUCTION. DISCONNECT AND REMOVE WORK TO BE ABANDONED. AND AS REQUIRED TO ACCOMMODATE WORK OF OTHER TRADES, IN AREAS AFFECTED BY THIS PROJECT.

LEGALLY DISPOSE OF MATERIALS TO SALVAGED OR RETAINED.

22 05 03 SUBMITTALS FOR PLUMBING

DESIGN BASIS MANUFACTURERS OF MATERIAL AND EQUIPMENT ARE SPECIFIED AND PLANS ARE DETAILED ACCORDING TO THIS MATERIAL. CONTRACTOR SHALL BASE HIS BID ON FURNISHING AND INSTALLING THIS MAKE OF MATERIAL AND EQUIPMENT.

SHOP DRAWINGS SHALL INCLUDE, BUT ARE NOT LIMITED TO THE FOLLOWING: MAKE, MODEL NUMBER, DIMENSIONS, ELECTRICAL CHARACTERISTICS (RATING). SHOP DRAWINGS SHALL BEAR NAME OF PROJECT AND LOCATION.

THE MAKE, TYPE, AND FINISH OF ALL MATERIALS, EQUIPMENT AND APPARATUS SHALL BE APPROVED BY THE ENGINEER/ ARCHITECT IN WRITING BEFORE THE CONTRACTOR INSTALLS IT. ANY SUBSTITUTION FOR ANY SPECIFIED EQUIPMENT OR MATERIAL SHALL FIRST BY APPROVED BY THE ENGINEER/ARCHITECT IN WRITING.

SUBMIT SHOP DRAWINGS ON THE FOLLOWING ITEMS FOR REVIEW BEFORE FABRICATION OR SHIPMENT: PLUMBING FIXTURES

MAINTENANCE MANUALS: FURNISH THREE FINAL COPIES, INCLUDING WIRING DIAGRAMS, MAINTENANCE AND OPERATING INSTRUCTIONS, PARTS LISTINGS, AND COPIES OF OTHER SUBMITTALS INDICATED FOR INCLUSION.

ANY CHANGES TO ITEMS SPECIFIED MUST BE SUBMITTED AS A SUBSTITUTION. WITH COMPLETE DOCUMENTATION OF PRICE DIFFERENTIAL AND EQUIPMENT DETAILS.

- 1. CERTAIN MAKES OF MATERIALS AND EQUIPMENT ARE SPECIFIED AND DRAWINGS ARE DETAILED ACCORDING TO THIS MATERIAL. CONTRACTOR SHALL BASE HIS BID ON FURNISHINGS AND INSTALLING THE SPECIFIED MAKE AND MODEL OR THE "EQUIVALENT" MODEL OF ANOTHER OF THE SPECIFIED MANUFACTURERS WHICH MEETS ALL THE QUALIFICATIONS OF THE SPECIFIED ITEMS.
- 2. WHERE MORE THAN ONE MAKE OF MATERIAL OR EQUIPMENT IS SPECIFIED, THE CONTRACTOR SHALL STATE IN HIS BID WHICH MAKE HE PROPOSES TO FURNISH. SHOP DRAWING APPROVAL SHALL BE OBTAINED PRIOR TO SHIPMENT OF
- 3. "EQUIVALENT" MATERIALS AND EQUIPMENT ARE THOSE OF MANUFACTURER WHICH MEET THE SAME STANDARDS OF PERFORMANCE, HAVE EQUAL OR BETTER MATERIALS OF CONSTRUCTION, AND EQUAL OR BETTER MAINTENANCE CHARACTERISTICS. ALL EQUIVALENTS MUST FIT THE SPACE PROVIDED IN THE BUILDING STRUCTURE. WHERE THE USE OF EQUIVALENTS RESULTS IN CHANGES, THIS CONTRACTOR SHALL BE RESPONSIBLE FOR SUCH CHANGES AND ANY COSTS RESULTING FROM THEM.
- 4. IF THE CONTRACTOR INTENDS TO USE EQUIPMENT OR MATERIALS NOT SPECIFIED, HE MUST RECEIVE APPROVAL FROM THE ENGINEER/ARCHITECT PRIOR TO THE AWARD OF THE CONTRACT. THIS PRIOR APPROVAL ONLY PERMITS SUBMITTAL OF A PARTICULAR MANUFACTURER'S EQUIPMENT IN GENERAL. THE SPECIFIED ITEM TO BE USED MUST AGAIN BE SUBMITTED FOR FINAL REVIEW AS SPECIFIED UNDER "SHOP DRAWINGS".

22 05 23 GENERAL DUTY VALVES

PROVIDE STOPS OR ISOLATION VALVES ON DOMESTIC WATER SUPPLIES TO ISOLATE HOT AND COLD WATER TO EACH FIXTURE, INCLUDING ALL EQUIPMENT AND EQUIPMENT PROVIDED BY

FIXTURES, ITEM OR UNITS FURNISHED BY THE MANUFACTURER WITH INTEGRAL STOPS OR STOPS SPECIFIED WITH THE FIXTURE ARE CONSIDERED TO BE PROPERLY VALVED AT THE

ACCESS SHALL BE PROVIDED TO ALL VALVES.

VALVES ON DOMESTIC WATER PIPING SHALL BE BALL VALVES.

[BALL VALVES - 1 INCH AND SMALLER: 2-PIECE BODY, 600 PSI CWP, 150 PSI SWP, CAST BRONZE BODY, FULL PORT, TEFLON SEATS, BLOWOUT-PROOF STEM, ADJUSTABLE PACKING GLAND, CHROME PLATED BRONZE BALL, WITH SCREWED ENDS, AND VINYL-COVERED STEEL HANDLE. PROVIDE SOLDER ENDS. PROVIDE EXTENDED VALVE STEMS FOR VALVES USED ON INSULATED LINES. PROVIDE NIBCO SERIES 585-70-NS.]

[BALL VALVES: 1-1/4 INCH TO 3 INCH: 3-PIECE BODY, 600 PSI CWP, 150 PSI SWP, CAST BRONZE BODY, CONVENTIONAL PORT, TEFLON SEATS, BLOWOUT-PROOF STEM, ADJUSTABLE PACKING GLAND, CHROME PLATED BRONZE BALL, SCREWED ENDS, AND VINYL-COVERED STEEL HANDLE. PROVIDE SOLDER ENDS. PROVIDE EXTENDED VALVE STEMS FOR VALVES USED ON INSULATED LINES. PROVIDE TO NIBCO SERIES 590-Y.1

MANUFACTURERS: SUBJECT TO COMPLIANCE WITH REQUIREMENTS, AVAILABLE PRODUCTS THAT MAY BE INCORPORATED INTO THE WORK INCLUDE, AND ARE LIMITED TO, THE FOLLOWING:

AMERICAN VALVE, INC. CONBRACO INDUSTRIES, INC.; APOLLO VALVES. CRANE CO.; CRANE VALVE GROUP; CRANE VALVES.

HAMMOND VALVE. MILWAUKEE VALVE COMPANY.

NIBCO INC.

RED-WHITE VALVE CORPORATION.

WATTS REGULATOR CO.; A DIVISION OF WATTS WATER TECHNOLOGIES, INC

CHECK VALVES

SWING CHECK VALVES - CLASS 125, CAST BRONZE BODY AND CAP, HORIZONTAL SWING, Y-PATTERN, WITH A BRONZE DISC, AND HAVING THREADED OR SOLDER ENDS. PROVIDE SOLDER ENDS FOR DOMESTIC HOT AND COLD WATER SERVICE. PROVIDE NIBCO S-413.

22 05 29 HANGERS AND SUPPORTS FOR PLUMBING PIPING AND EQUIPMENT

SUPPORT ALL PIPING AND EQUIPMENT BY HANGERS OR BRACKETS. PROVIDE STRUCTURAL STEEL MEMBERS WHERE REQUIRED TO SUPPORT PIPING AND EQUIPMENT. NO PORTION OF PIPING OR VALVES SHALL BE SUPPORTED BY EQUIPMENT.

DELEGATED DESIGN FOR EQUIPMENT SUPPORTS, THIS CONTRACTOR SHALL RETAIN A QUALIFIED PROFESSIONAL ENGINEER TO PROVIDE SUPPORT CALCULATIONS OF STATIC AND DYNAMIC LOADING DUE TO OPERATING EQUIPMENT WEIGHT, SEISMIC AND WIND FORCES. THE SIGNED AND SEALED CALCULATIONS AND DETAILS SHALL BE SUBMITTED BY THE RETAINED PROFESSIONAL ENGINEER.

PROVIDE HANGERS, SUPPORTS, CLAMPS AND ATTACHMENTS TO SUPPORT PIPING PROPERLY FROM BUILDING STRUCTURE. ARRANGE FOR GROUPING OF PARALLEL RUNS OF HORIZONTAL PIPING SUPPORTED TOGETHER ON FIELD-FABRICATED. HEAVY-DUTY TRAPEZE HANGERS WHERE POSSIBLE. WHERE PIPING OF VARIOUS SIZES IS SUPPORTED TOGETHER BY TRAPEZE HANGERS,

SPACE HANGERS FOR SMALLEST PIPE SIZE OR PROVIDE INTERMEDIATE SUPPORTS FOR SMALLER DIAMETER PIPE AS SPECIFIED ABOVE FOR INDIVIDUAL PIPE HANGERS. INDIVIDUAL PIPE HANGERS TO BE ANVIL INTERNATIONAL CLEVIS HANGER FIG. 260, ELCEN. ROD SIZES TO CONFORM TO THE FOLLOWING: 3/8" RODS FOR 3/4" TO 2" PIPE; 1/2" RODS FOR

2-1/2" TO 3" PIPE; 5/8" RODS FOR 4" TO 5" PIPE; 3/4" RODS FOR 6" PIPE. HANGERS SHALL BE SIZED TO ALLOW INSULATION TO PASS THROUGH UNOBSTRUCTED, PROVIDE SADDLE SUPPORT FOR INSULATION AT ALL HANGERS.

HANGER SPACING FOR STEEL PIPING UNLESS OTHERWISE NOTED IS TO BE AS FOLLOWS: 1-1/4" OR SMALLER TO BE 8' ON CENTER; 1-1/2" TO 2" TO BE 10' ON CENTER; 2-1/2" AND LARGER TO BE 12' ON CENTER AND AT EACH CHANGE OF DIRECTION. HANGER SPACING FOR COPPER PIPE TO BE AS FOLLOWS: 1" OR SMALLER 6' ON CENTER; 1-1/4" OR LARGER 8' ON CENTER. HANGER SPACE FOR CPVC AND PVC PIPE TO BE AS FOLLOWS: 1" AND SMALLER TO BE 3' ON CENTER; 1-1/4" OR LARGER TO BE 4' ON CENTER.

PIPING SHALL ALSO BE SUPPORTED AT EACH CHANGE IN DIRECTION, VALVES AND EQUIPMENT. 22 05 53 IDENTIFICATION FOR PLUMBING PIPING AND EQUIPMENT

PROVIDE SELF-ADHESIVE PIPE LABELS WITH WHITE BACKGROUND AND BLACK LETTERING. CONTACT TYPE WITH PERMANENT ADHESIVE BACKING. INCLUDE IDENTIFICATION OF PIPING

SERVICE USING SAME DESIGNATIONS OR ABBREVIATIONS AS USED ON THE DRAWINGS AND AN ARROW INDICATING FLOW DIRECTION. **EQUIPMENT** PROVIDE SELF-ADHESIVE PLASTIC EQUIPMENT LABELS WITH WHITE BACKGROUND AND

BLACK LETTERING, CONTACT TYPE WITH PERMANENT ADHESIVE BACKING, 160 DEGREE F TEMPERATURE. INCLUDE EQUIPMENT'S DRAWING DESIGNATION AND SPECIFICATION SECTION NUMBER WHERE EQUIPMENT IS SPECIFIED.

22 07 19 PLUMBING SYSTEM INSULATION

INSULATION SHALL BE LISTED AND LABELED PER ASTM E 84 FOR PLENUM INSTALLATIONS EMPLOYING SLIP ON TECHNIQUES. PROVIDE INSULATION MATERIALS, ACCESSORIES, AND FINISHES WITH SMOOTH, STRAIGHT,

AND EVEN SURFACES; FREE OF VOIDS THROUGHOUT THE LENGTH OF PIPING INCLUDING

FITTINGS, VALVES, AND SPECIALTIES. SURFACE PREPARATION: CLEAN AND DRY SURFACES TO RECEIVE INSULATION. REMOVE MATERIALS THAT WILL ADVERSELY AFFECT INSULATION APPLICATION.

PIPING SYSTEMS REQUIRING INSULATION INSULATE DOMESTIC COLD WATER PIPING, ASSOCIATED FITTINGS AND VALVES WITH FLEXIBLE

ELASTOMERIC 1/2" WALL THICKNESS INSULATION. INSULATE DOMESTIC HOT WATER PIPING, ASSOCIATED FITTINGS AND VALVES WITH 1" THICK FLEXIBLE ELASTOMERIC, 1" THICK MINERAL WOOL, 1-1/2" THICK FIBERGLASS INSULATION OR PER LOCAL ENERGY CODE, WHICHEVER GREATER.

INSULATE DOMESTIC HOT WATER RETURN PIPING, ASSOCIATED FITTINGS AND VALVES WITH 1" WALL THICKNESS INSULATION OR PER LOCAL ENERGY CODE, WHICHEVER GREATER. INSULATE WASTE PIPING ABOVE CEILINGS THAT RECEIVE CONDENSATE WITH 1/2" WALL THICKNESS INSULATION.

INSULATE EXPOSED SANITARY DRAINS, DOMESTIC WATER, DOMESTIC HOT WATER, AND STOPS FOR PLUMBING FIXTURES FOR PEOPLE WITH DISABILITIES. FLEXIBLE ELASTOMERIC INSULATION

CLOSED-CELL, SPONGE- OR EXPANDED-RUBBER MATERIALS. COMPLY WITH ASTM C 534, TYPE I FOR TUBULAR MATERIALS AND TYPE II FOR SHEET MATERIALS. ADHESIVES, SEALERS, AND PROTECTIVE FINISHES: AS RECOMMENDED BY INSULATION MANUFACTURER FOR APPLICATIONS INDICATED.

MANUFACTURERS: SUBJECT TO COMPLIANCE WITH REQUIREMENTS, AVAILABLE PRODUCTS THAT MAY BE INCORPORATED INTO THE WORK INCLUDE, AND ARE LIMITED TO, THE FOLLOWING:

AEROFLEX USA, INC.; AEROCEL. ARMACELL LLC; AP ARMAFLEX.

K-FLEX USA; INSUL-LOCK, INSUL-TUBE, AND K-FLEX LS.

FIBERGLASS INSULATION

FIBERGLASS PIPING INSULATION: ASTM C 547, CLASS 1 ENCASE PIPE FITTINGS INSULATION WITH ONE-PIECE PRE-MOLDED PVC FITTING COVERS. VAPOR BARRIER MATERIAL: PAPER-BACKED ALUMINUM FOIL. EXCEPT AS OTHERWISE INDICATED, STRENGTH AND PERMEABILITY RATING EQUIVALENT TO ADJOINING PIPE

STAPLES, BANDS, WIRES, AND CEMENT: AS RECOMMENDED BY INSULATION MANUFACTURER

ADHESIVES, SEALERS, AND PROTECTIVE FINISHES: AS RECOMMENDED BY INSULATION MANUFACTURER FOR APPLICATIONS INDICATED. MANUFACTURERS: SUBJECT TO COMPLIANCE WITH REQUIREMENTS, AVAILABLE PRODUCTS THAT MAY BE INCORPORATED INTO THE WORK INCLUDE, AND ARE LIMITED TO, THE

ARMSTRONG WORLD INDUSTRIES, INC. OWENS-CORNING FIBERGLASS CORP.

FOR APPLICATIONS INDICATED.

KEENE CORP. CERTAINTEED.

JOHNS MANVILLE.

ADHESIVES MATERIALS SHALL BE COMPATIBLE WITH INSULATION MATERIALS, JACKETS, AND SUBSTRATES AND FOR BONDING INSULATION TO ITSELF AND TO SURFACES TO BE INSULATED, UNLESS OTHERWISE INDICATED.

INSULATION FOR HANDICAP ACCESSIBLE FIXTURES ALL HANDICAP LAVATORY P-TRAP AND ANGLE STOP ASSEMBLIES SHALL BE INSULATED WITH TRAP WRAP PROTECTIVE KIT MANUFACTURED BY PROFLO MODEL PF202WH. ABRASION RESISTANT, ANTI-MICROBIAL VINYL EXTERIOR COVER SHALL BE SMOOTH. FOR TRAPS, THE INSULATION SHALL HAVE A CLEANOUT NUT CAP TO ALLOW SERVICE TO THE TRAP WITHOUT DISASSEMBLY. FOR STOPS, THE INSULATION SHALL HAVE A LOCK LID THAT PREVENTS TAMPERING BUT ALLOWS ACCESS WITHOUT REMOVAL OF THE INSULATION. FASTENERS SHALL REMAIN SUBSTANTIALLY OUT OF SIGHT.

MANUFACTURERS: SUBJECT TO COMPLIANCE WITH REQUIREMENTS PROFLO TRUEBRO

PLUMBEREX

INSTALL PIPING CONCEALED FROM VIEW UNLESS NOTED OTHERWISE, FREE OF SAGS AND BENDS. DO NOT ENCLOSE, COVER, OR PUT PIPING INTO OPERATION UNTIL IT HAS BEEN INSPECTED AND APPROVED BY AUTHORITIES HAVING JURISDICTION. CLEAN AND DISINFECT POTABLE DOMESTIC WATER PIPING USING APPROVED PROCEDURES BY AUTHORITIES HAVING JURISDICTION.

INSTALL AT RIGHT ANGLES; DIAGONAL RUNS ARE PROHIBITED UNLESS OTHERWISE SHOWN. INSTALL PIPING ABOVE ACCESSIBLE CEILINGS TO ALLOW SUFFICIENT SPACE FOR CEILING PANEL REMOVAL. COORDINATE ALL PIPING WITH ALL OTHER TRADES. PROVIDE WATER PRESSURE REGULATORS WHERE NECESSARY TO LIMIT THE INCOMING WATER PRESSURE TO 80 PSI INSIDE THE BUILDING.

DOMESTIC WATER PIPING ABOVE GROUND: HARD COPPER TUBE, ASTM B 88, TYPE L; WROUGHT-COPPER, SOLDER-JOINT FITTINGS; AND SOLDERED JOINTS. SOLDER FILLER METALS: ASTM B 32, LEAD-FREE ALLOYS.

FLUX: ASTM B 813, WATER FLUSHABLE. TYPE "L"; COPPER PRESSURE-SEAL JOINT; AND PRESSURE-SEAL JOINT SYSTEMS.

PROVIDE DIELECTRIC INSULATION AT POINTS WHERE COPPER OR BRASS PIPE COMES IN CONTACT WITH FERROUS PIPING, REINFORCING STEEL OR OTHER DISSIMILAR METAL IN

22 11 19 DOMESTIC WATER PIPING SPECIALTIES

REDUCED PRESSURE BACKFLOW PREVENTERS BACKFLOW PREVENTER (2" AND SMALLER) - PROVIDE A REDUCED PRESSURE BACKFLOW PREVENTER ON WATER SERVICE MAIN WHERE THE WATER SERVICE ENTERS THE BUILDING. REDUCED PRESSURE BACKFLOW PREVENTER SHALL BE SIZED EQUAL TO THE SIZE OF THE WATER SERVICE AND CONFORM TO ASSE 1013. PIPE BACKFLOW PREVENTER DISCHARGE TO APPROVED

PLACE OF DISPOSAL.

DUAL CHECK VALVE BACKFLOW PREVENTER PROVIDE A DUAL CHECK VALVE BACKFLOW PREVENTER THAT COMPLIES WITH ASSE 1022 AT CONNECTION OF DOMESTIC WATER SUPPLY TO ANY PERMANENTLY CONNECTED CARBONATED BEVERAGE DISPENSER OR WHERE INDICATED IN THE CONTRACT DOCUMENTS.

PROVIDE A DUAL CHECK VALVE BACKFLOW PREVENTER THAT COMPLIES WITH ASSE 1024 AT CONNECTION OF DOMESTIC WATER SUPPLY TO ANY POTABLE WATER DISPENSING EQUIPMENT SUCH AS ICE MAKERS, COFFEE MACHINES, TEA MACHINES, ESPRESSO MACHINES OR WHERE INDICATED IN THE CONTRACT DOCUMENTS MANUFACTURERS: SUBJECT TO COMPLIANCE WITH REQUIREMENTS, AVAILABLE PRODUCTS THAT MAY BE INCORPORATED INTO THE WORK INCLUDE, AND ARE LIMITED TO, THE

AMES FIRE & WATERWORKS; A DIVISION OF WATTS WATER TECHNOLOGIES, INC.

CONBRACO INDUSTRIES, INC. FEBCO: A DIVISION OF WATTS WATER TECHNOLOGIES, INC.

FLOMATIC CORPORATION. WATTS; A DIVISION OF WATTS WATER TECHNOLOGIES, INC.; WATTS REGULATOR COMPANY. ZURN INDUSTRIES, LLC; PLUMBING PRODUCTS GROUP; WILKINS WATER CONTROL PRODUCTS.

PROVIDE BALANCING VALVES WHERE REQUIRED FOR PROPER BALANCING OF WATER SYSTEMS AS SHOWN ON THE CONTRACT DOCUMENTS.

BALANCING VALVES SHALL BE RED-WHITE VALVE CORPORATION MODEL 9517AB (NPT) OR MODEL 9519 (SOLDER). VALVE SHALL HAVE BRASS BODY, GLOBE VALVE REGULATION AND ISOLATION PROPERTIES. FIXED ORIFICE DESIGN FOR PRECISE MEASUREMENT, INTEGRAL MEMORY STOP TO ENSURE REPEATABLE SETTING, FULL SHUTOFF WITHOUT AFFECTING MEMORY SETTINGS, HIGH AND LOW PRESSURE METERING POINTS, PRECISION INDICATOR WINDOWS, RUGGED TOP SET HAND-WHEEL ASSEMBLY, PRESSURE RATING OF 300 PSI, AND TEMPERATURE RATING OF 15 DEG. F TO 260 DEG. F.

MANUFACTURERS: SUBJECT TO COMPLIANCE WITH REQUIREMENTS, AVAILABLE MANUFACTURERS OFFERING PRODUCTS THAT MAY BE INCORPORATED INTO THE WORK INCLUDE, AND ARE LIMITED TO, THE FOLLOWING: CRANE CO.; CRANE VALVE GROUP; CRANE VALVES

HAMMOND VALVE MILWAUKEE VALVE COMPANY. NIBCO INC.

WATTS RED-WHITE VALVE CORP.

VACUUM BREAKERS VACUUM BREAKERS SHALL BE WATTS MODEL LF288A FOR PIPING CONNECTIONS OR WATTS LF8 SERIES FOR HOSE CONNECTIONS. VACUUM BREAKERS SHALL COMPLY WITH ASSE 1001 FOR PIPED CONNECTIONS, ASSE 1011 FOR HOSE CONNECTIONS, BRONZE BODY AND THREADED

CONNECTIONS WITH ROUGH BRONZE FINISH. MANUFACTURERS: SUBJECT TO COMPLIANCE WITH REQUIREMENTS, AVAILABLE MANUFACTURERS OFFERING PRODUCTS THAT MAY BE INCORPORATED INTO THE WORK INCLUDE, AND LIMITED TO, THE FOLLOWING: MIFAB, INC.

PRIER PRODUCTS, INC.

MIFAB, INC.

WATTS; A DIVISION OF WATTS WATER TECHNOLOGIES, INC.; WATTS REGULATOR COMPANY. ZURN INDUSTRIES, LLC; PLUMBING PRODUCTS GROUP; LIGHT COMMERCIAL PRODUCTS. ZURN INDUSTRIES, LLC; PLUMBING PRODUCTS GROUP; WILKINS WATER CONTROL PRODUCTS

PRESSURE REDUCING VALVES PROVIDE PRESSURE REDUCING VALVE TO REGULATE INCOMING DOMESTIC WATER PRESSURE IN EXCESSIVE OF 80 PSIG. PRESSURE REDUCING VALVE SHALL BE WATTS MODEL LF223S, COMPLY WITH ASSE 1003, INITIAL WORKING PRESSURE OF 300 PSIG, INTEGRAL STRAINER, LEAD-FREE

BRASS BODY WITH THREADED CONNECTIONS. MANUFACTURERS: SUBJECT TO COMPLIANCE WITH REQUIREMENTS, AVAILABLE MANUFACTURERS OFFERING PRODUCTS THAT MAY BE INCORPORATED INTO THE WORK INCLUDE, AND LIMITED TO, THE FOLLOWING:

CONBRACO INDUSTRIES, INC. HONEYWELL INTERNATIONAL INC

CASH ACME; A DIVISION OF RELIANCE WORLDWIDE CORPORATION.

WATTS; A DIVISION OF WATTS WATER TECHNOLOGIES, INC.; WATTS REGULATOR COMPANY. ZURN INDUSTRIES, LLC; PLUMBING PRODUCTS GROUP; WILKINS WATER CONTROL PRODUCTS. STRAINERS PROVIDE LEAD-FREE WYE-PATTERN STRAINER WATTS MODEL LFS777S RATED FOR 125 PSIG

MINIMUM, BRONZE BODY, THREADED CONNECTIONS, STAINLESS STEEL SCREEN WITH ROUND PERFORATIONS OF 0.020 INCH AND PIPE PLUG DRAIN. PROVIDE STRAINERS ON SUPPLY SIDE OF EACH PRESSURE REDUCING VALVE, SOLENOID VALVE AND PUMP. MANUFACTURERS: SUBJECT TO COMPLIANCE WITH REQUIREMENTS, AVAILABLE MANUFACTURERS OFFERING PRODUCTS THAT MAY BE INCORPORATED INTO THE WORK INCLUDE, AND LIMITED TO, THE FOLLOWING:

PRIER PRODUCTS, INC. WATTS; A DIVISION OF WATTS WATER TECHNOLOGIES, INC.; WATTS REGULATOR COMPANY. ZURN INDUSTRIES, LLC; PLUMBING PRODUCTS GROUP; LIGHT COMMERCIAL PRODUCTS.

ZURN INDUSTRIES, LLC; PLUMBING PRODUCTS GROUP; WILKINS WATER CONTROL PRODUCTS WHERE APPLICABLE AND POSSIBLE, INSTALL ALL HOSE BIBS 24"-30" ABOVE FINISHED FLOOR TO FACILITATE FILLING OF MOP BUCKET WITHOUT A HOSE. FURNISH TO OWNER WITH RECEIPT ONE VALVE KEY FOR EACH KEY OPERATED HOSE BOB INSTALLED.

MANUFACTURERS: SUBJECT TO COMPLIANCE WITH REQUIREMENTS, AVAILABLE MANUFACTURERS OFFERING PRODUCTS THAT MAY BE INCORPORATED INTO THE WORK INCLUDE, AND LIMITED TO, THE FOLLOWING:

SMITH, JAY R. MFG. CO.; DIVISION OF SMITH INDUSTRIES, INC.

WATTS DRAINAGE PRODUCTS

WOODFORD MANUFACTURING COMPANY; A DIVISION OF WCM INDUSTRIES, INC. ZURN INDUSTRIES, LLC; PLUMBING PRODUCTS GROUP; LIGHT COMMERCIAL PRODUCTS. ZURN INDUSTRIES, LLC; PLUMBING PRODUCTS GROUP; SPECIFICATION DRAINAGE

WALL HYDRANTS PROVIDE NONFREEZE WALL HYDRANTS WOODFORD MODEL B-67 WITH CHROME FINISH ON BRASS CASTING WITH BOX AND HINGED DOOR. CONCEAL WITHIN INTERIOR PARTITIONS. FURNISH TO OWNER WITH RECEIPT ONE VALVE KEY FOR EACH KEY OPERATED WALL HYDRANT INSTALLED

MANUFACTURERS: SUBJECT TO COMPLIANCE WITH REQUIREMENTS, AVAILABLE MANUFACTURERS OFFERING PRODUCTS THAT MAY BE INCORPORATED INTO THE WORK INCLUDE, AND LIMITED TO, THE FOLLOWING: JOSAM COMPANY

<u>SMITH, JAY R. MFG. CO.; DIVISION OF SMITH INDUSTRIES, INC.</u>

<u>TYLER PIPE; WADE DIV</u>

WATTS DRAINAGE PRODUCTS WOODFORD MANUFACTURING COMPANY; A DIVISION OF WCM INDUSTRIES, INC.

ZURN INDUSTRIES, LLC; PLUMBING PRODUCTS GROUP; LIGHT COMMERCIAL PRODUCTS ZURN INDUSTRIES, LLC; PLUMBING PRODUCTS GROUP; SPECIFICATION DRAINAGE

TRAP-SEAL PRIMER DEVICE

WATER TAB METERS

THE PLUMBING CONTRACTOR SHALL PROVIDE TRAP PRIMERS FOR ALL FLOOR DRAINS. TRAP PRIMER SHALL BE MIFAB MR-500 TRAP PRIMER VALVE. PROVIDE ACCESS PANEL IN WALL OR CEILING FOR ALL CONCEALED TRAP PRIMERS. INSTALL TRAP SEAL PRIMER VALVES WITH OUTLET PIPING PITCHED DOWN TOWARD DRAIN TRAP A MINIMUM OF 1% AND CONNECT TO FLOOR DRAIN BODY, TRAP OR INLET FITTING.COORDINATE EXACT LOCATION WITH ARCHITECT PRIOR TO INSTALLATION.

MANUFACTURERS: SUBJECT TO COMPLIANCE WITH REQUIREMENTS, AVAILABLE MANUFACTURERS OFFERING PRODUCTS THAT MAY BE INCORPORATED INTO THE WORK INCLUDE, AND LIMITED TO, THE FOLLOWING:

PRECISION PLUMBING PRODUCTS, INC.

DISPLACEMENT-TYPE WATER METERS:

SIOUX CHIEF MANUFACTURING COMPANY, INC. SMITH, JAY R. MFG. CO.; DIVISION OF SMITH INDUSTRIES, INC.

WATTS; A DIVISION OF WATTS WATER TECHNOLOGIES, INC.; WATTS REGULATOR

PLUMBING CONTRACTOR TO COORDINATE WITH OWNER FOR EXACT MODEL AND MANUFACTURER. DESCRIPTION: DISPLACEMENT-TYPE WATER METER COMPLYING WITH AWWA C700. REMOTE REGISTRATION SYSTEM: DIRECT-READING TYPE COMPLYING WITH AWWA C706; MODIFIED WITH SIGNAL-TRANSMITTING ASSEMBLY, LOW-VOLTAGE CONNECTING WIRING, AND REMOTE REGISTER ASSEMBLY AS REQUIRED BY LANDLORD

OR OWNER. MOUNT READER IN AN ACCESSIBLE LOCATION. WATER HAMMER ARRESTERS PROVIDE WATER-HAMMER ARRESTERS IN WATER PIPING ACCORDING TO PDI-WH 201.

STANDARD: ASSE 1010 OR PDI-WH 201. TYPE: METAL BELLOWS OR COPPER TUBE WITH PISTON. SIZE: ASSE 1010, SIZES AA AND A THROUGH F, OR PDI-WH 201, SIZES A THROUGH F. MANUFACTURERS: SUBJECT TO COMPLIANCE WITH REQUIREMENTS, AVAILABLE MANUFACTURERS OFFERING PRODUCTS THAT MAY BE INCORPORATED INTO THE WORK

INCLUDE, AND ARE LIMITED TO, THE FOLLOWING: AMTROL, INC. JOSAM COMPANY PRECISION PLUMBING PRODUCTS, INC. SIOUX CHIEF MANUFACTURING COMPANY, INC. SMITH, JAY R. MFG. CO.; DIVISION OF SMITH INDUSTRIES, INC.

22 13 16 SANITARY, WASTE AND VENT PIPING SYSTEM

PROVIDE A COMPLETE SOIL, WASTE AND VENT SYSTEM IN THE BUILDING AND ON THE SITE AS INDICATED ON THE DRAWINGS AND AS SPECIFIED HEREIN. ABOVE GROUND SOIL, WASTE AND VENT PIPING WITHIN BUILDINGS INCLUDING SOIL STACKS, VENT STACKS, HORIZONTAL BRANCHES, TRAPS, AND CONNECTIONS TO FIXTURES AND DRAINS. UNDERGROUND BUILDING DRAIN PIPING INCLUDING MAINS, BRANCHES, TRAPS, CONNECTIONS TO FIXTURES AND DRAINS, AND CONNECTIONS TO STACKS, TERMINATING AT CONNECTION TO EXISTING SANITARY SEWER.

LINE SHALL BE SCHEDULE 40 CELLULAR-CORE PVC PIPE. ASTM F891, WITH ALL COMPATIBLE PVC SOCKET FITTINGS. MAKE TO ASTM D3311, DRAIN, WASTE, AND VENT

PIPING ALIGNMENT SHALL BE AS INDICATED ON THE DRAWINGS USING APPROVED WYE BRANCHES OR EIGHT BANDS FOR DIRECTION CHANGES AND SHALL BE SURELY SUPPORTED OR SECURED TO MAINTAIN SUCH ALIGNMENT.

PITCH OF SANITARY PIPING SHALL BE UNIFORM AT A MINIMUM OF 1/8" PER FOOT FOR BUILDING DRAINS, DRAINAGE PIPING GREATER THAN 2" AND AS INDICATED ON THE DRAWINGS. PITCH OF SANITARY PIPING SHALL BE UNIFORM AT A MINIMUM OF 1/4" PER FOOT FOR DRAINAGE PIPING 2" AND SMALLER AND AS INDICATED ON THE DRAWINGS. PROTECTION SHALL BE GIVEN ALL FOOTINGS, OTHER STRUCTURAL ELEMENTS DURING UNDERGROUND WORK ADJACENT TO SUCH ITEMS. REFER TO ARCHITECTURAL AND/OR STRUCTURAL DRAWINGS FOR LOCATIONS.

ABOVE FLOOD RIM OF FIXTURES. PITCH VENT LINES BACK TO SOIL OR WASTE PIPE, FREE OF DROPS AND SAGS. CLEANOUTS SHALL BE FULL SIZE OF PIPE UP TO 4", AND 4" FOR LARGER SIZES. FOR UNDERGROUND AND CONCEALED LINES, PROVIDE CLEANOUTS IN ACCESSIBLE POSITIONS AT EACH RIGHT ANGLE TURN AND AT INTERVALS NOT TO EXCEED FIFTY FEET. IN FLOORS, INSTALL

VENT ALL FIXTURES, CONNECT BRANCH VENTS TO MAIN VENT RISERS AT LEAST SIX INCHES

FLUSH WITH FINISH FLOOR WITH EXTENSION PIPE FROM CLEANOUT WYE. STORM SEWER PIPING - ALL STORM SEWER LINES SHALL BE PVC ASTM D-3034 WITH

22 13 19 SANITARY WASTE PIPING SPECIALTIES

FLOOR CLEANOUT: AS SCHEDULED.

WALL CLEANOUT: AS SCHEDULED. PROVIDE A SANITARY TEE AND THREADED CAP CLEANOUT PLUG IN SUSPENDED WASTE PIPING. MANUFACTURERS: SUBJECT TO COMPLIANCE WITH REQUIREMENTS, AVAILABLE PRODUCTS THAT MAY BE INCORPORATED INTO THE WORK INCLUDE, AND ARE LIMITED TO, THE

WATTS REGULATOR CO.; A DIVISION OF WATTS WATER TECHNOLOGIES, INC

FOLLOWING:

SYMMONS

LAWLER

LEONARD

SDR-35 GASKETS.

MIFAB ZURN SIOUX CHIEF

JOSAM, SMITH, ZURN, WATTS, MIFAB, SIOUX CHIEF, OR OATEY ALL FLOOR DRAINS LOCATED IN ROOMS WHICH HAVE TILE FLOORS SHALL HAVE SQUARE

REFER TO PLUMBING FIXTURE AND EQUIPMENT SCHEDULE FOR PROJECT SPECIFIC FLOOR DRAIN MANUFACTURERS AND MODELS 22 30 01 POINT OF USE THERMOSTATIC MIXING VALVES

OPERATING PRESSURE. MOUNT UNDER SINK OR LAVATORY. SET OUTLET TEMPERATURE OF

THERMOSTATIC MIXING VALVES SHALL BE PROVIDED FOR ALL PUBLIC HAND WASHING SINKS AND LAVATORIES AND SHALL BE ASSE 1070 LISTED, LEAD FREE, SWEAT CONNECTIONS, 125 PSI

THERMOSTATIC MIXING VALVE TO 110 DEGREES F.

POINT-OF USE THERMOSTATIC MIXING VALVES SHALL BE POWERS HYDROGUARD LFe480. ROUTE TEMPERED WATER TO HOT WATER SIDE OF SINK AND LAVATORIES. MANUFACTURERS: SUBJECT TO COMPLIANCE WITH REQUIREMENTS, AVAILABLE MANUFACTURERS OFFERING PRODUCTS THAT MAY BE INCORPORATED INTO THE WORK INCLUDE, AND ARE LIMITED TO, THE FOLLOWING:

POWERS BRADLEY

22 40 00 PLUMBING FIXTURES

REFER TO PLUMBING FIXTURE SCHEDULE. MANUFACTURERS: SUBJECT TO COMPLIANCE WITH REQUIREMENTS, AVAILABLE

MANUFACTURERS OFFERING PRODUCTS THAT MAY BE INCORPORATED INTO THE WORK INCLUDE, AND ARE LIMITED TO, THE FOLLOWING: AMERICAN STANDARD AMERICA.

CRANE PLUMBING, LLC. KOHLER CO.

FIAT.

TOTO USA, INC. ZURN INDUSTRIES, LLC; COMMERCIAL BRASS AND FIXTURES.

STERLING; A KOHLER COMPANY. SLOAN.

OH COA #4715

08/18/2023

Progress Dates 08.15.2022 - BID SET

\ 05.27.2022 - REVISION #1 08.18.2023 - REVISION #3


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Job No: 11920 04.26.2022



- THE DRAWINGS ARE DIAGRAMMATIC IN NATURE. EXACT LOCATIONS OF DEVICES AND ROUTING OF DUCTWORK SHALL BE DETERMINED BY CONTRACTOR AFTER COORDINATION WITH ALL OTHER TRADES AND FIELD DETERMINATION OF FINAL CONSTRUCTION DETAILS. MINOR ADJUSTMENTS TO DUCT ROUTING AND CONFIGURATION TO AVOID CONFLICT WITH BUILDING STRUCTURE OR OTHER TRADES SHALL BE INCLUDED IN CONTRACTOR'S PRICE. CONTRACTOR SHALL OBTAIN ENGINEERS APPROVAL IN WRITING FOR ANY MODIFICATIONS TO SYSTEM DESIGN PRIOR TO INSTALLATION.
- ALL EXPOSED MATERIALS AND EQUIPMENT SHALL BE INSTALLED AND SUPPORTED IN A FIRST-CLASS AND WORKMANLIKE FASHION. DUCTWORK SHALL RUN PARALLEL AND/ OR PERPENDICULAR TO MAIN BUILDING STRUCTURE. ANY WORK THAT IS NOT DONE IN A FIRST-CLASS OR WORKMANLIKE FASHION, IN THE ARCHITECTS OPINION, SHALL BE REDONE AT THE CONTRACTORS EXPENSE.
- APPROVED HANGERS AT INTERVALS NOT EXCEEDING TEN FEET. DUCT COVERINGS AND LININGS SHALL HAVE A FLAME-SPREAD INDEX NOT MORE THAN 25 AND A SMOKE DEVELOPED INDEX NOT MORE THAN 50.

ALL DUCT JOINTS, SEAMS AND CONNECTIONS SHALL BE SECURELY FASTENED AND SEALED. DUCTS SHALL BE SUPPORTED WITH

- PROVIDE VOLUME DAMPERS AT ALL ROUND BRANCH DUCT TAKE-OFFS THAT ARE ACCESSIBLE. PROVIDE TURNING VANES AT ALL 90 DEGREE SQUARE ELBOWS IN SUPPLY AIR DUCTS. PROVIDE 45 DEGREE HEEL AT ALL RECTANGULAR SUPPLY AND RETURN BRANCH DUCT TAKE-OFFS.
- OUTDOOR AIR INTAKES SHALL BE 10'-0" MINIMUM AWAY FROM ANY EXHAUST AND PLUMBING VENT OUTLET.
- WIRE UP ALL LOW VOLTAGE (24V) THERMOSTATS.
- CONTRACTOR SHALL COORDINATE THE LOCATION OF ALL PIPES, DUCTWORK, UNITS, ETC. WITH ALL OTHER TRADES AND SHIFT LOCATION OR OFFSET WHERE NECESSARY. PROVIDE TRANSITIONS IN DUCTWORK TO AVOID CONFLICT WITH EXISTING DUCTWORK AND OTHER STRUCTURES.
- CONTRACTOR SHALL COORDINATE ALL AIR DEVICES WITH ELECTRICAL AND ARCHITECTURAL REFLECTED CEILING PLANS.
- COORDINATE LOCATION OF ALL EXTERIOR LOUVER OR OUTLET WITH ARCHITECTURAL ELEVATION PLAN.
- COORDINATE ROOF WORK WITH BUILDING OWNER'S ROOFING CONTRACTOR TO ASSURE THAT THE ROOF WARRANTY IS NOT
- INSTALL DUCTWORK AS HIGH AS POSSIBLE.
- EXHAUST AIR DUCTS SHALL BE EQUIPPED WITH BACKDRAFT DAMPERS.
- . ALL DUCT OPENINGS AND OTHER AIR DISTRIBUTION OPENINGS SHALL BE COVERED DURING CONSTRUCTION EXCEPT FOR TESTING AND INSPECTION.
- PROVIDE BUILDING OWNER OR REPRESENTATIVE WITH DETAILED OPERATING AND MAINTENANCE INSTRUCTIONS AND WARRANTIES /WRITTEN GUARANTEE FOR EACH SYSTEM. O&M INSTRUCTIONS SHALL BE CONSISTENT WITH OSHA REQUIREMENTS IN CCR TITLE 8, SECTION 5142 AND OTHER RELATED REGULATIONS.
- . ALL DUCT ELBOWS SHALL BE LONG RADIUS OR MITERED.

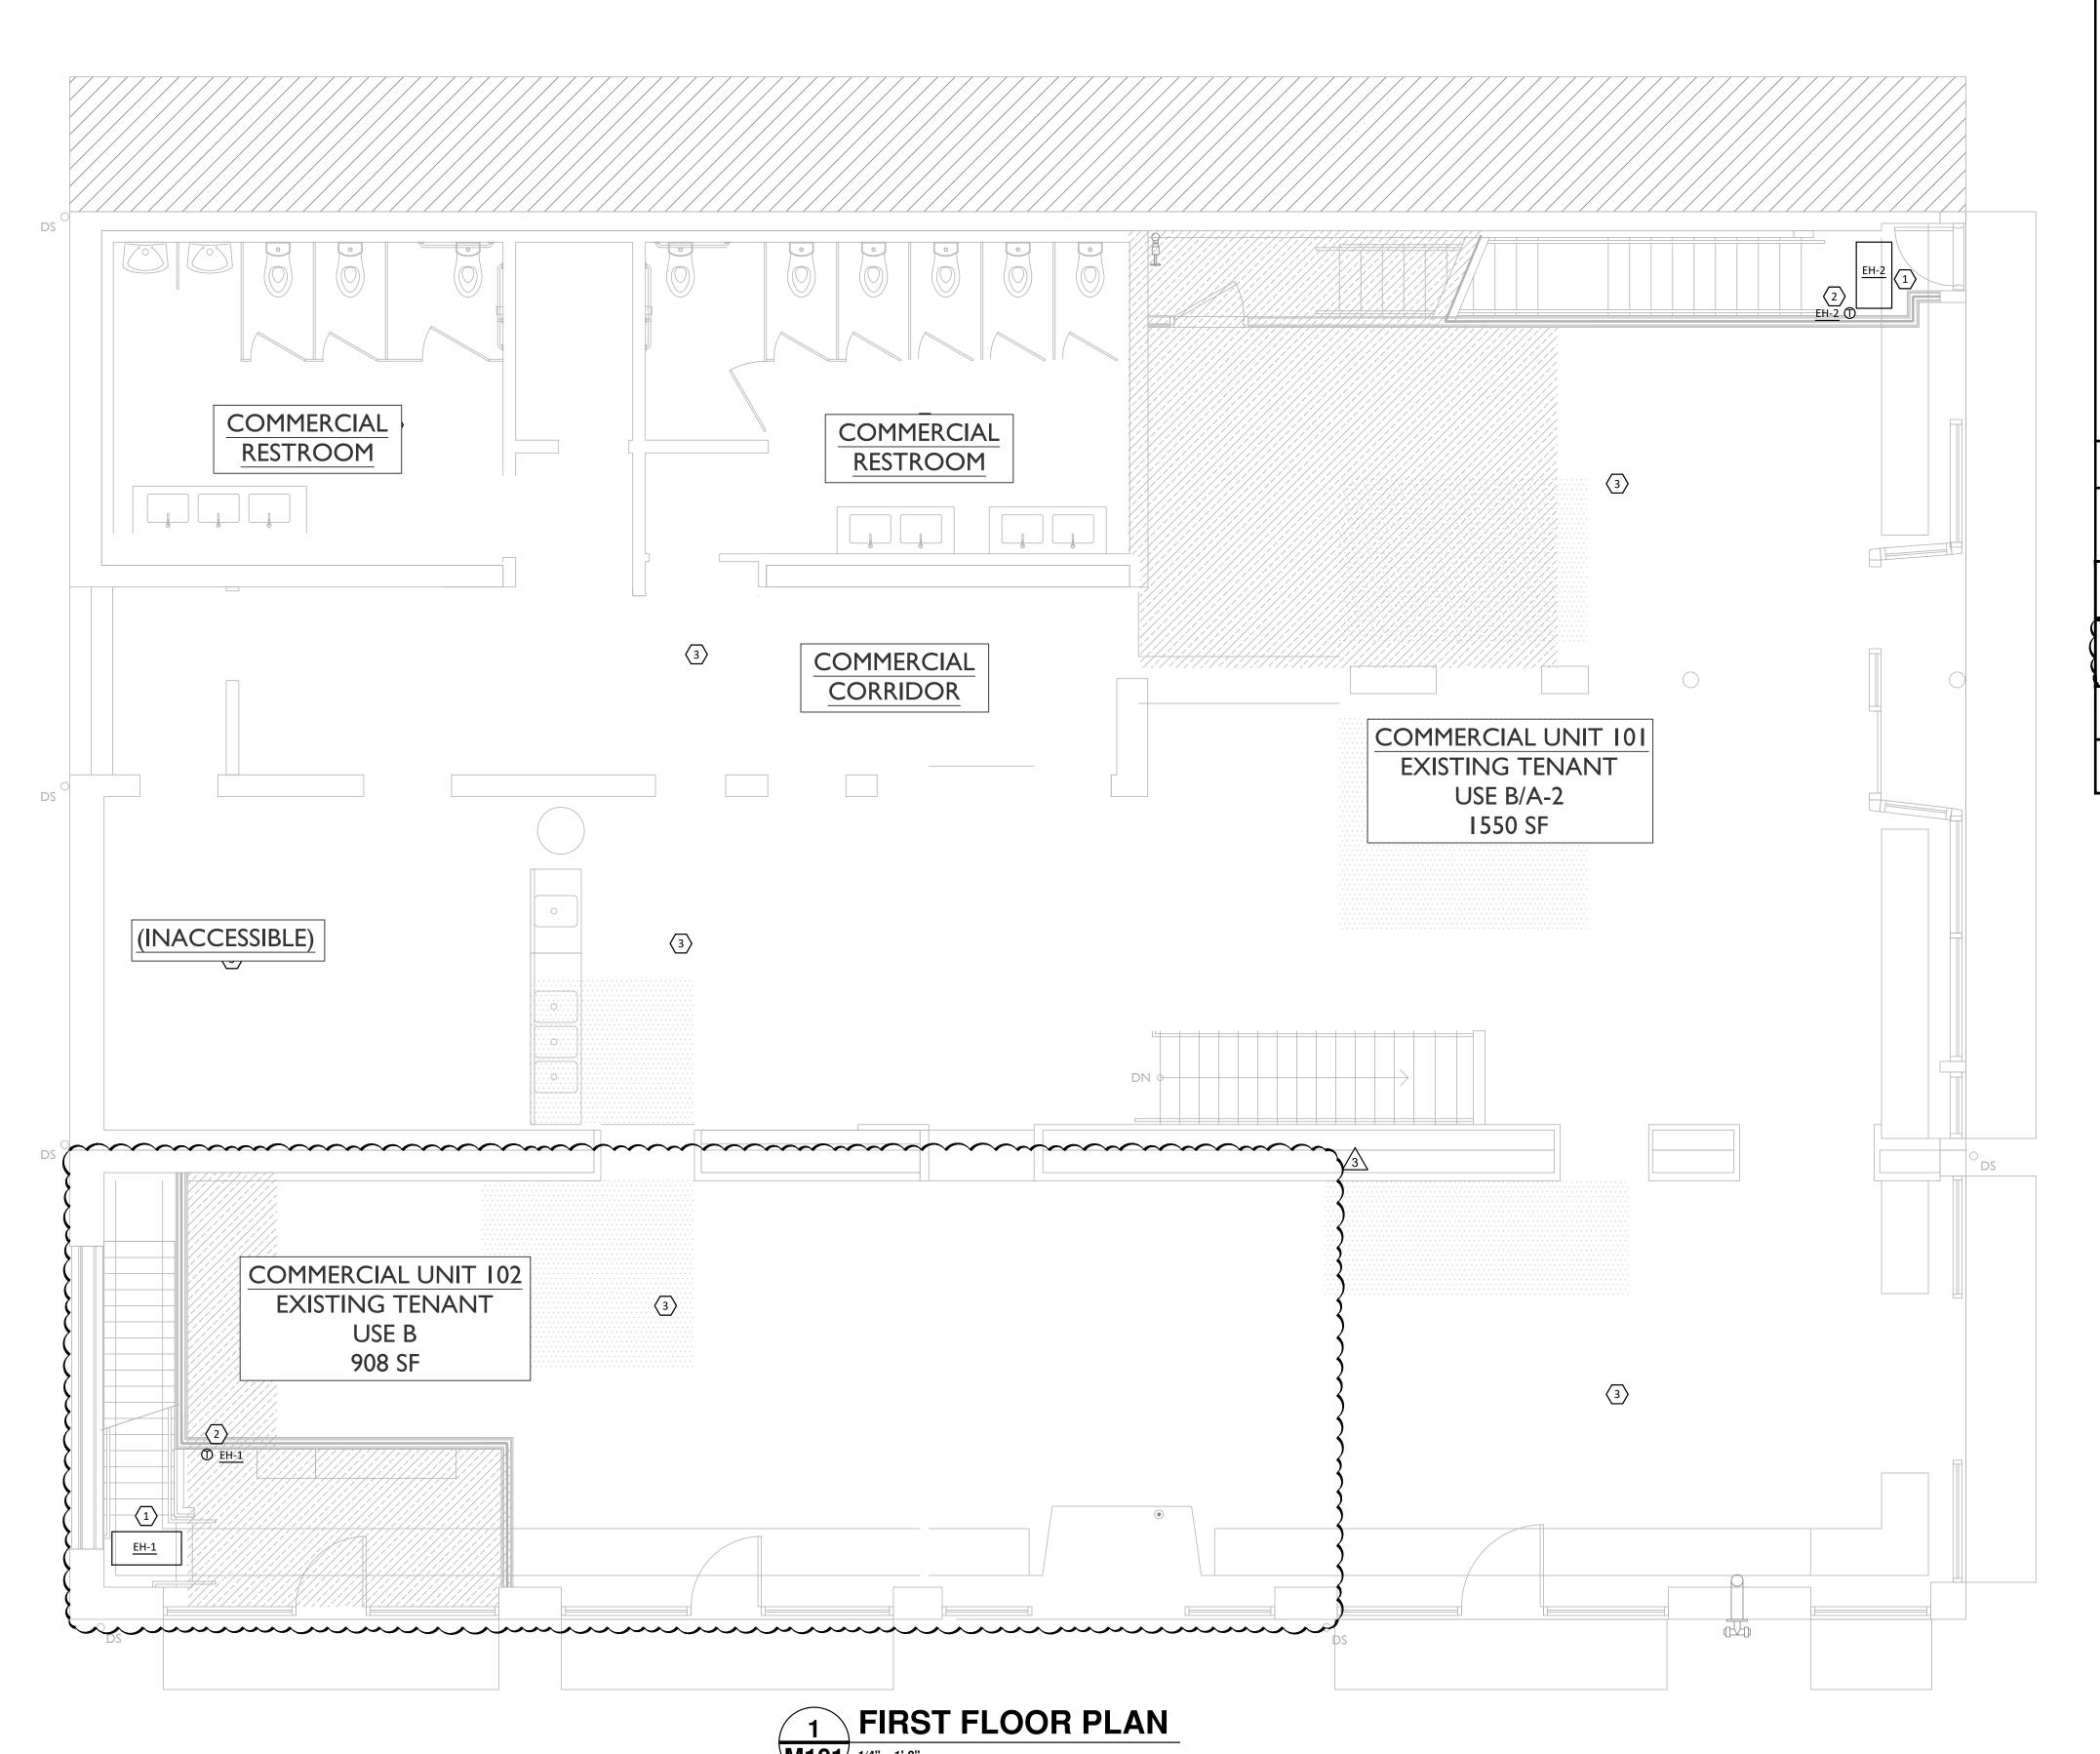KEYED NOTES

- PROVIDE ELECTRIC CEILING HEATER, MOUNT TO STRUCTURE. HEATER SHALL BE RECESSED IN THE CEILING.
- PROVIDE THERMOSTAT AND MOUNT ON WALL 4 FEET A.F.F.
- EXISTING AREA TO REMAIN AS IS. NO WORK IN HERE AS PART OF THIS CONTRACT.

HEAT PUMP HEATING CONTROLS

WHEN THE OUTDOOR TEMPERATURE IS BELOW THE COMPRESSOR LOCKOUT TEMPERATURE (35°F), ONLY THE AUXILIARY HEAT OPERATES. WHEN THE OUTDOOR TEMPERATURE IS ABOVE THE AUXILIARY LOCKOUT TEMPERATURE (35°F), ONLY THE COMPRESSOR OPERATES. BOTH COMPRESSOR LOCKOUT AND AUXILIARY LOCKOUT TEMPERATURES TO BE THE SAME TEMPERATURE (35°F).

NATURAL VENTILATION

OUTDOOR AIR IS OBTAINED FROM NATURAL VENTILATION, IN ACCORDANCE WITH SECTION 402.2 OF THE OHIO MECHANICAL CODE THE MINIMUM OPENABLE AREA TO THE OUTDOORS EXCEEDS 4% OF THE FLOOR AREA BEING VENTILATED.

OH COA #4715

08/18/2023

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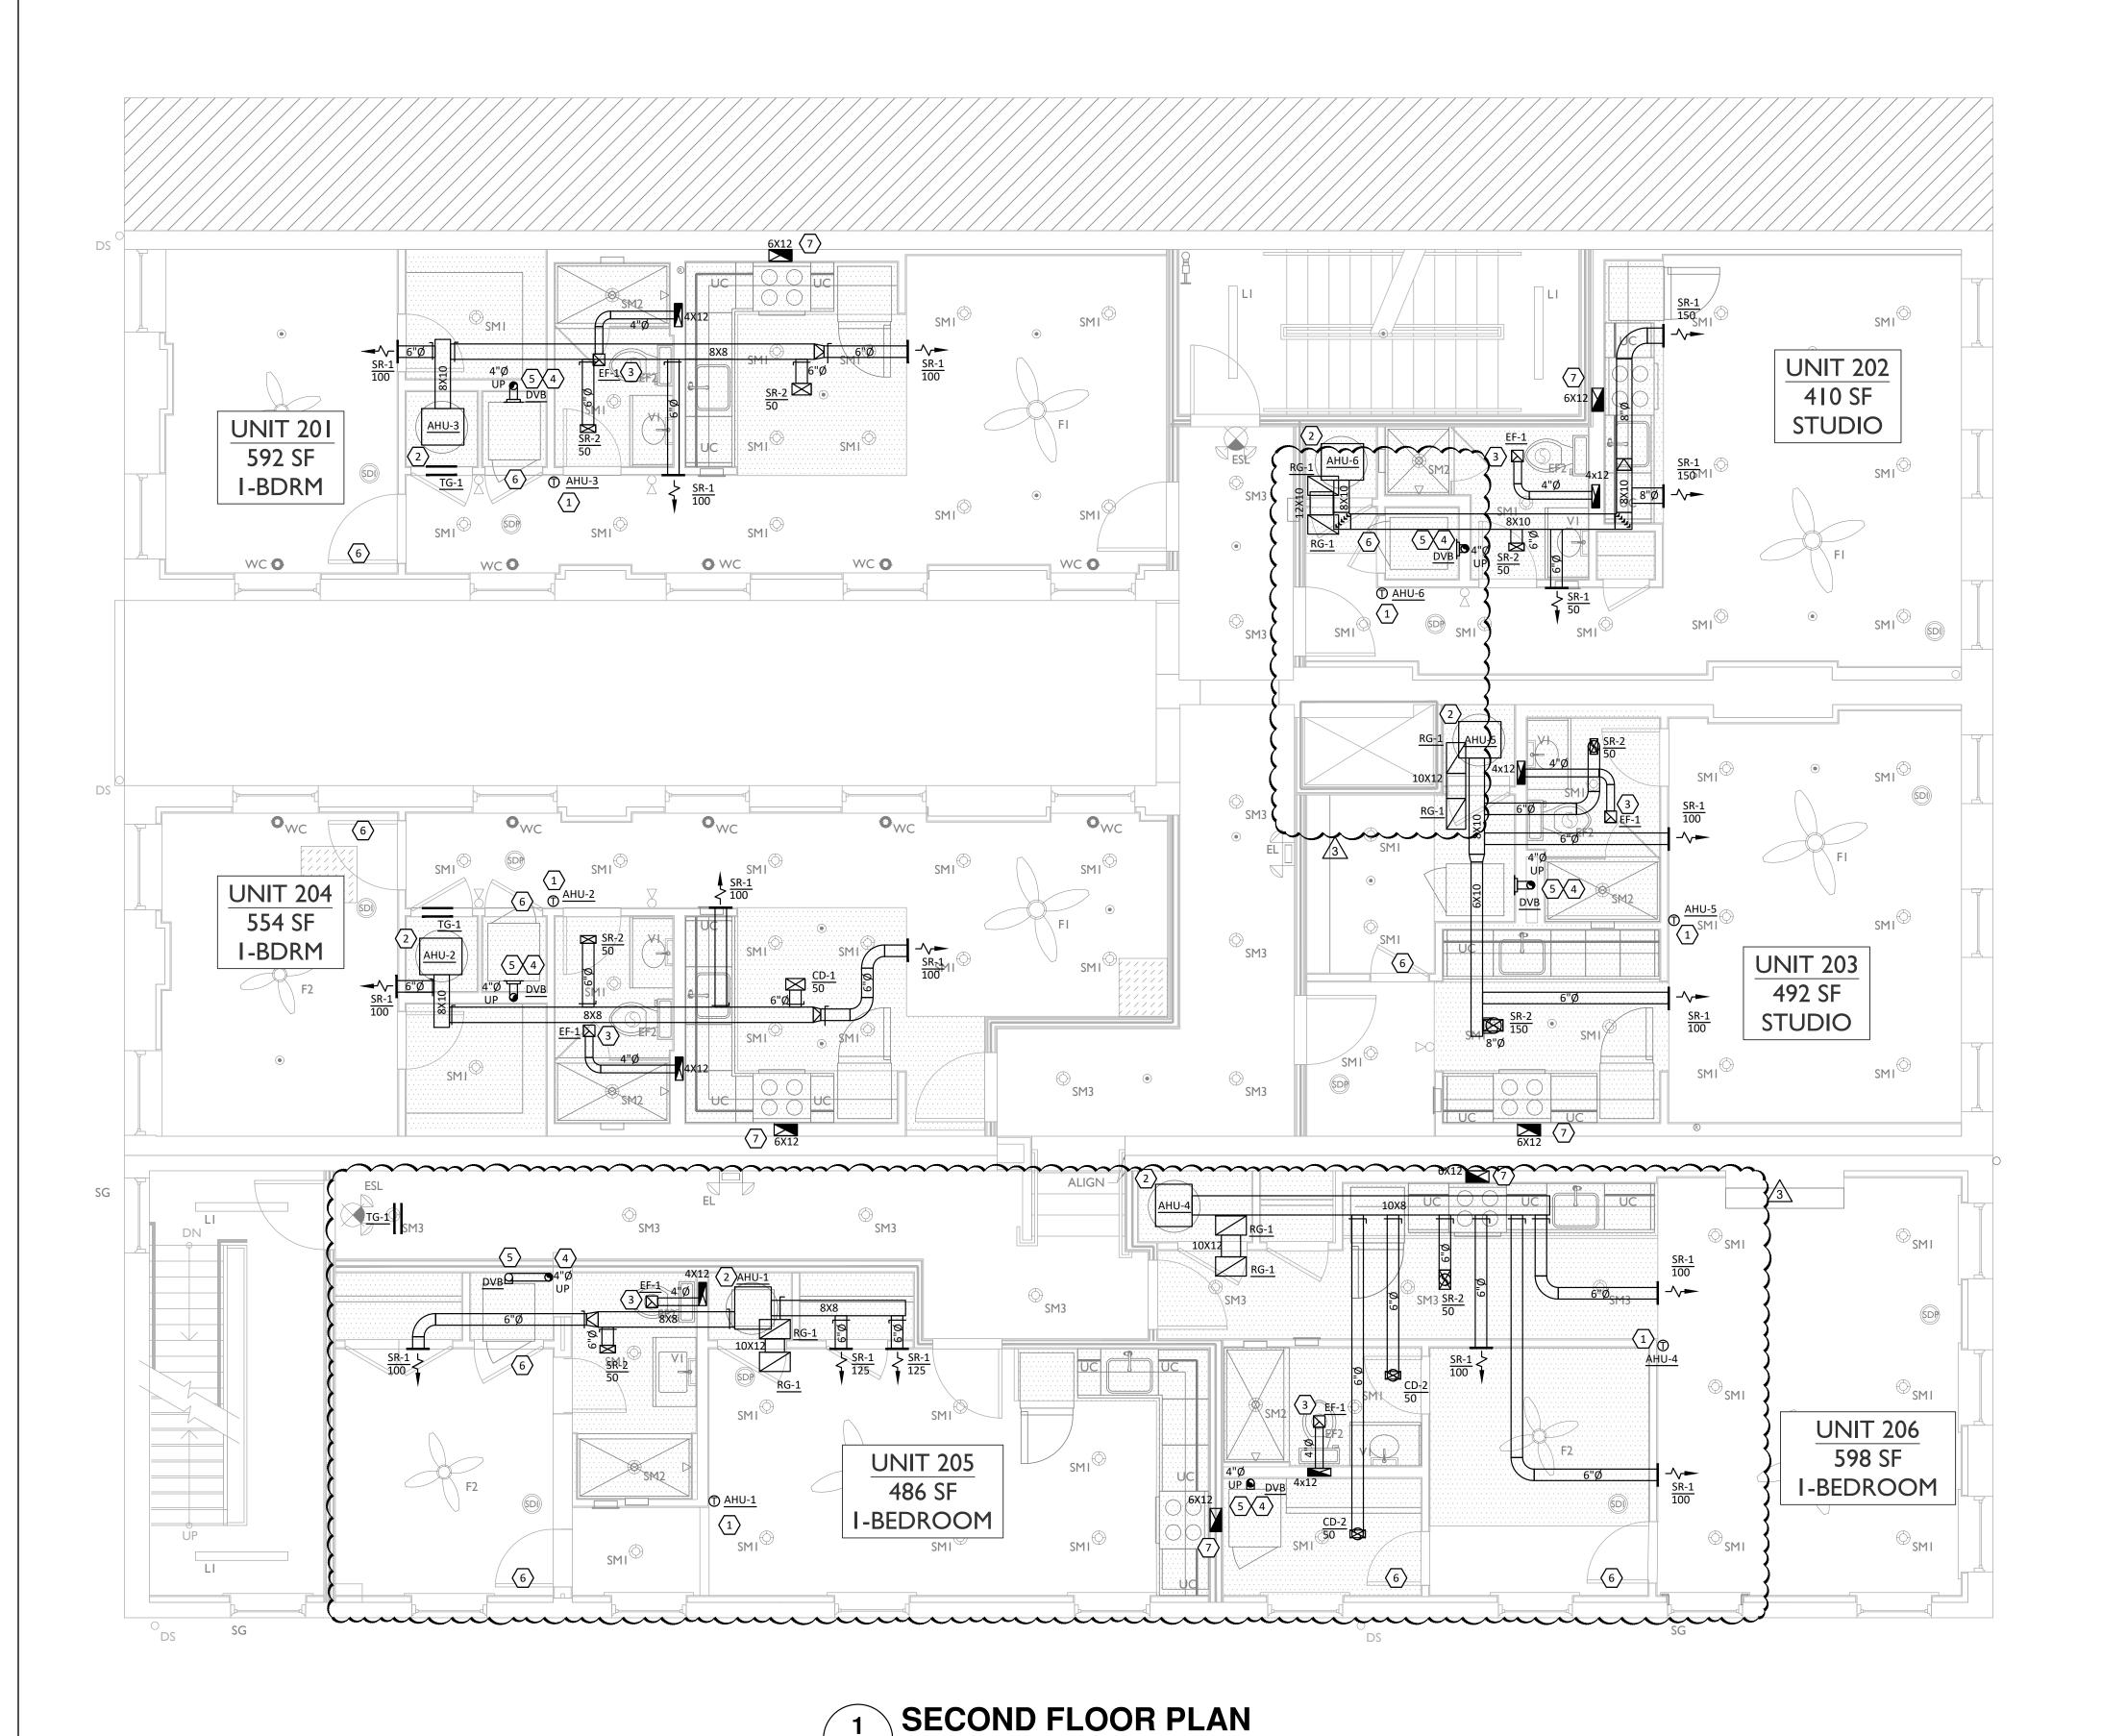
Design Team:
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WITHOUT THE WRITTEN PERMISSION OF MARQUE ENGINEERING LLC F PLANS ARE NOT PRESENTED FOR PERMIT REVIEW WITHIN 120 DAYS OF ENGINEER SIGNATURE THIS SHEET IS VOID AND WILL NEED TO BE UPDATED BY THE ENGINEER OF RECORD.



- THE DRAWINGS ARE DIAGRAMMATIC IN NATURE. EXACT LOCATIONS OF DEVICES AND ROUTING OF DUCTWORK SHALL BE DETERMINED BY CONTRACTOR AFTER COORDINATION WITH ALL OTHER TRADES AND FIELD DETERMINATION OF FINAL CONSTRUCTION DETAILS. MINOR ADJUSTMENTS TO DUCT ROUTING AND CONFIGURATION TO AVOID CONFLICT WITH BUILDING STRUCTURE OR OTHER TRADES SHALL BE INCLUDED IN CONTRACTOR'S PRICE. CONTRACTOR SHALL OBTAIN ENGINEERS APPROVAL IN WRITING FOR ANY MODIFICATIONS TO SYSTEM DESIGN PRIOR TO INSTALLATION.
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KEYED NOTES

- PROVIDE THERMOSTAT AND MOUNT ON WALL 4 FEET A.F.F.
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- PROVIDE NEW EXHAUST FAIR AND ROUTE EXHAUST DUCTWORK UP TUROUGH ROOF, REFER TO ROOF PLAN FOR TERMINATION INFORMATION. PROVIDE RADIATION DAMPER WHEN PENETRATING THROUGH A FIRE RATED ASSEMBLY.
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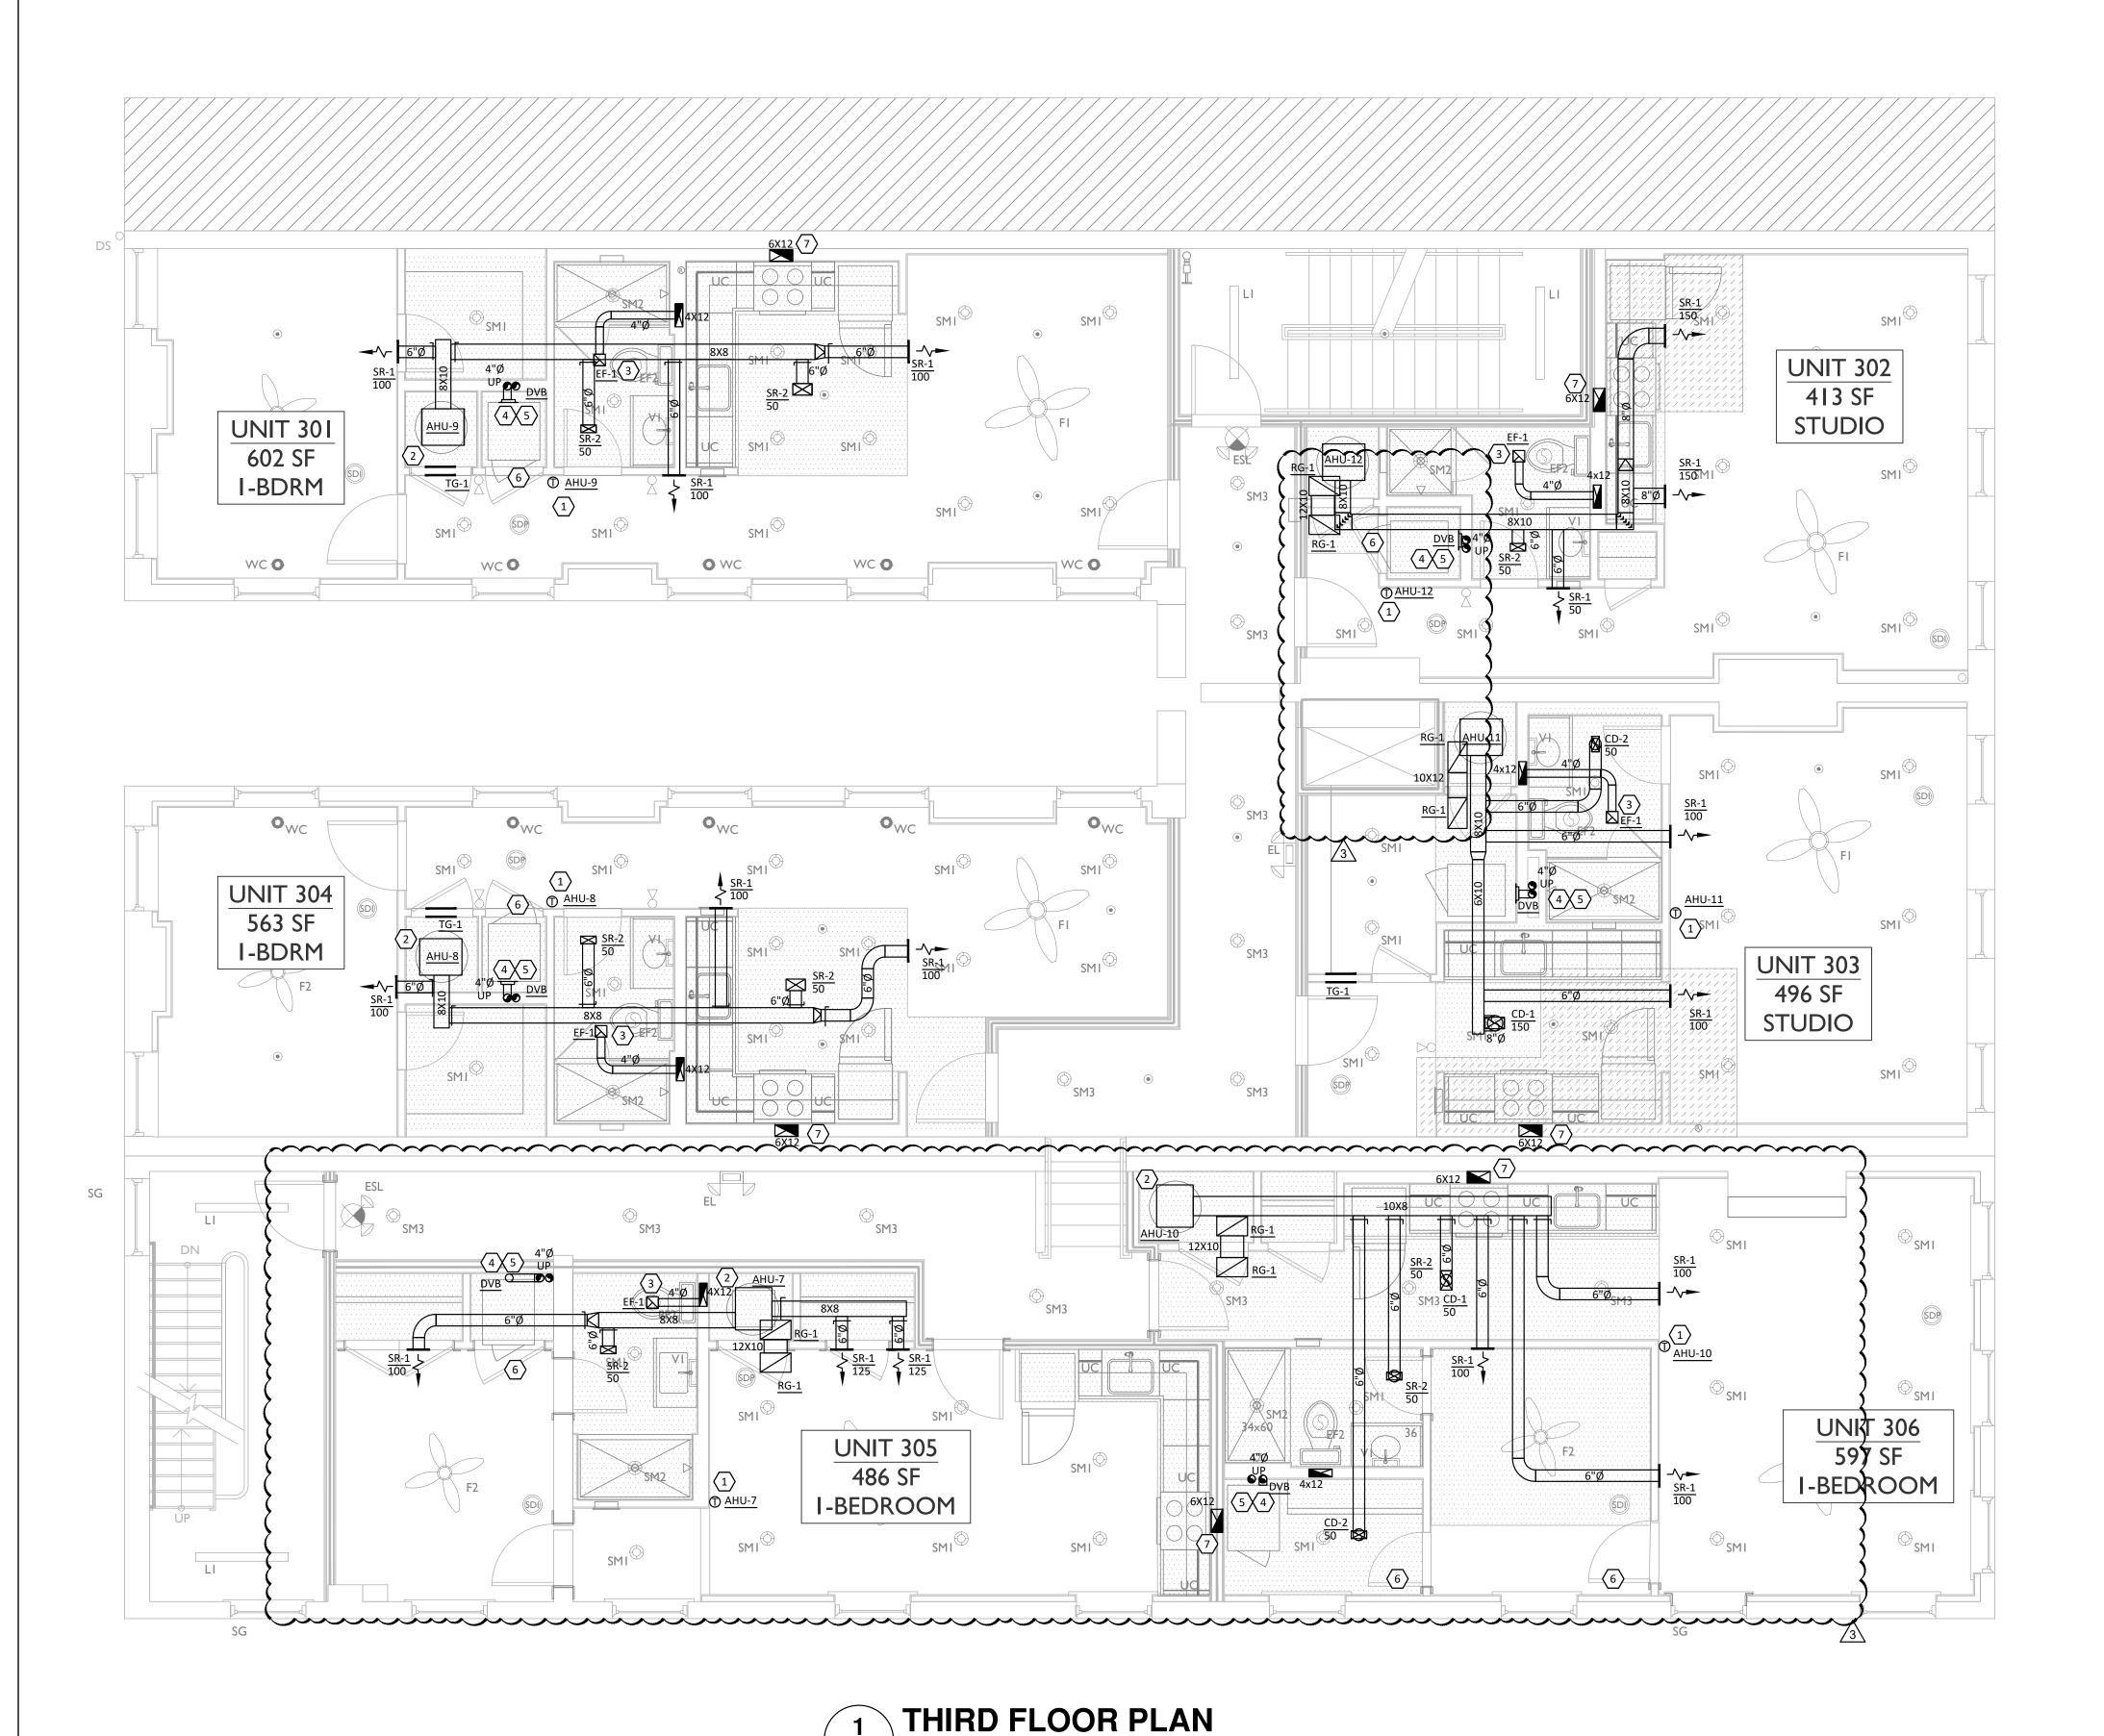
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- UNDERCUT DOOR 1" TO ALLOW FOR AIR TRANSFER.
- ROUTE 6X10 EXHAUST DUCT CONNECTION TO STOVE EXHAUST HOOD OP THROUGH KOOP, REFER TO ROOF PLAN FOR 3 TERMINATION INFORMATION. PROVIDE RADIATION DAMPER WHEN PENETRATING THROUGH A FIRE RATED ASSEMBLY.

HEAT PUMP HEATING CONTROLS

WHEN THE OUTDOOR TEMPERATURE IS BELOW THE COMPRESSOR LOCKOUT TEMPERATURE (35°F), ONLY THE AUXILIARY HEAT OPERATES. WHEN THE OUTDOOR TEMPERATURE IS ABOVE THE AUXILIARY LOCKOUT TEMPERATURE (35°F), ONLY THE COMPRESSOR OPERATES. BOTH COMPRESSOR LOCKOUT AND AUXILIARY LOCKOUT TEMPERATURES TO BE THE SAME TEMPERATURE (35°F).

NATURAL VENTILATION


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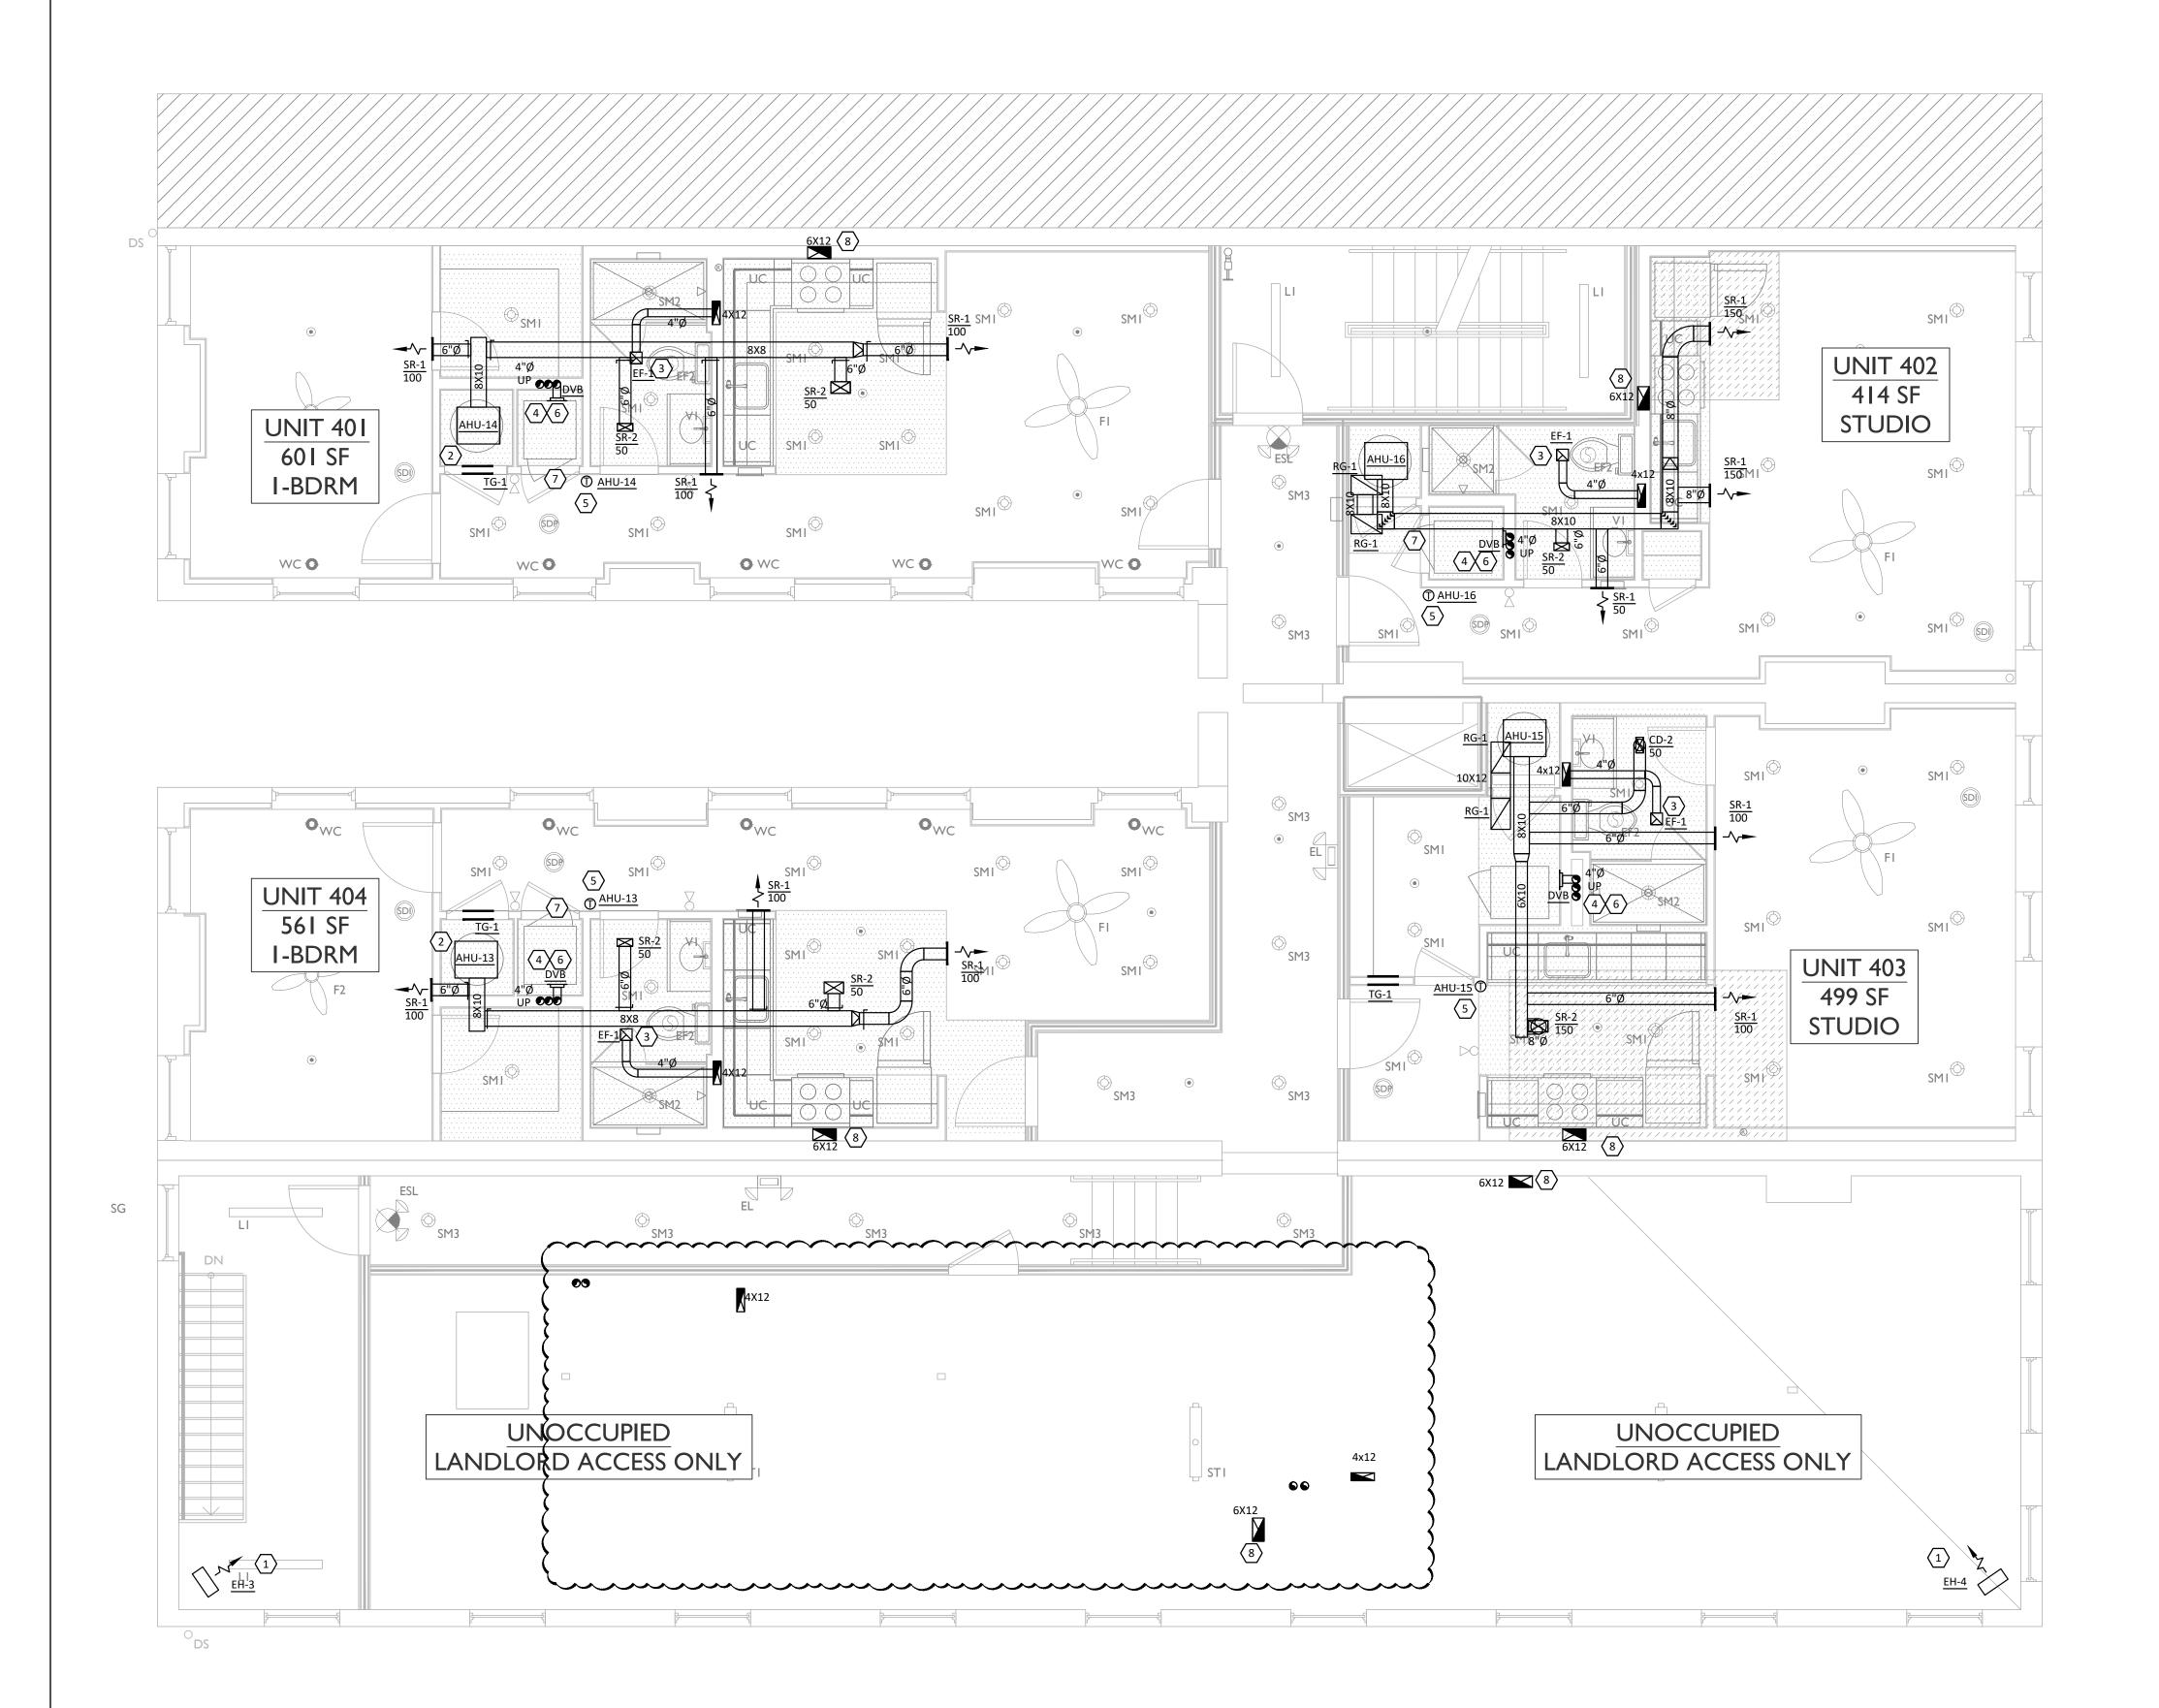


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Design Team:
MARQUE ENGINEERING

Drawn by: MARQUE ENGINEERING



FOURTH FLOOR PLAN

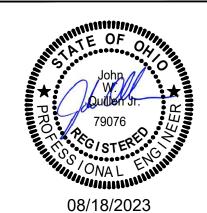M104 1/4" = 1'-0"

GENERAL NOTES

- THE DRAWINGS ARE DIAGRAMMATIC IN NATURE. EXACT LOCATIONS OF DEVICES AND ROUTING OF DUCTWORK SHALL BE DETERMINED BY CONTRACTOR AFTER COORDINATION WITH ALL OTHER TRADES AND FIELD DETERMINATION OF FINAL CONSTRUCTION DETAILS. MINOR ADJUSTMENTS TO DUCT ROUTING AND CONFIGURATION TO AVOID CONFLICT WITH BUILDING STRUCTURE OR OTHER TRADES SHALL BE INCLUDED IN CONTRACTOR'S PRICE. CONTRACTOR SHALL OBTAIN ENGINEERS APPROVAL IN WRITING FOR ANY MODIFICATIONS TO SYSTEM DESIGN PRIOR TO INSTALLATION.
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ALL DUCT JOINTS, SEAMS AND CONNECTIONS SHALL BE SECURELY FASTENED AND SEALED. DUCTS SHALL BE SUPPORTED WITH

- PROVIDE VOLUME DAMPERS AT ALL ROUND BRANCH DUCT TAKE-OFFS THAT ARE ACCESSIBLE. PROVIDE TURNING VANES AT ALL 90 DEGREE SQUARE ELBOWS IN SUPPLY AIR DUCTS. PROVIDE 45 DEGREE HEEL AT ALL RECTANGULAR SUPPLY AND RETURN BRANCH DUCT TAKE-OFFS.
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KEYED NOTES

- PROVIDE ELECTRIC UNIT HEATER, WITH UNIT MOUNTED THERMOSTAT. HEATER SHALL BE MOUNTED FROM CEILING. SET THERMOSTAT TO 60°F (ADJUSTABLE).
- PROVIDE AIR HANDLING UNIT AND INSTALL ABOVE WATER HEATER LOCATED IN MECHANICAL ROOM. INSTALL IN ACCORDANCE WITH DETAIL ON DRAWING M201. ALL FILTER ACCESS TO BE IN FRONT OF THE UNIT. ROUTE $\frac{3}{4}$ " CONDENSATE DRAIN LINE WITH TRAP TO FLOOR DRAIN OR NEAREST APPROVED RECEPTACLE. PROVIDE CONDENSATE PUMP AS REQUIRED. COORDINATE FLOOR DRAIN LOCATION WITH PLUMBING PLAN.
- INFORMATION. PROVIDE RADIATION DAMPER WHEN PENETRATING THROUGH A FIRE RATED ASSEMBLY.
- CLOTHES DRYER EXHAUST DUCTS. ALL CLOSED DRYER EXHAUST RUNS SHALL BE LIMITED TO 35'. INCLUDING ELBOWS. FROM INSTALLATION INSTRUCTIONS SHOWING A LENGTH EXCEEDING 35'. AS AN OPTION, A DRYER EXHAUST POWER VENTILATOR MAY BE USED WHERE DRYER DUCT RUNS EXCEED 35'. ROUTE DRYER VENT UP THROUGH ATTIC. REFER TO ROOF PLAN FOR TERMINATION INFORMATION. ROUTE EXHAUST DUCT TO IN WALL DRYER BOX, IN-O-VATE TECHNOLOGIES INC MODEL #350. COORDINATE VENT BOX LOCATION WITH DRYER MANUFACTURER'S RECOMMENDATIONS.
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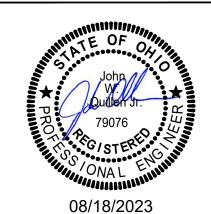
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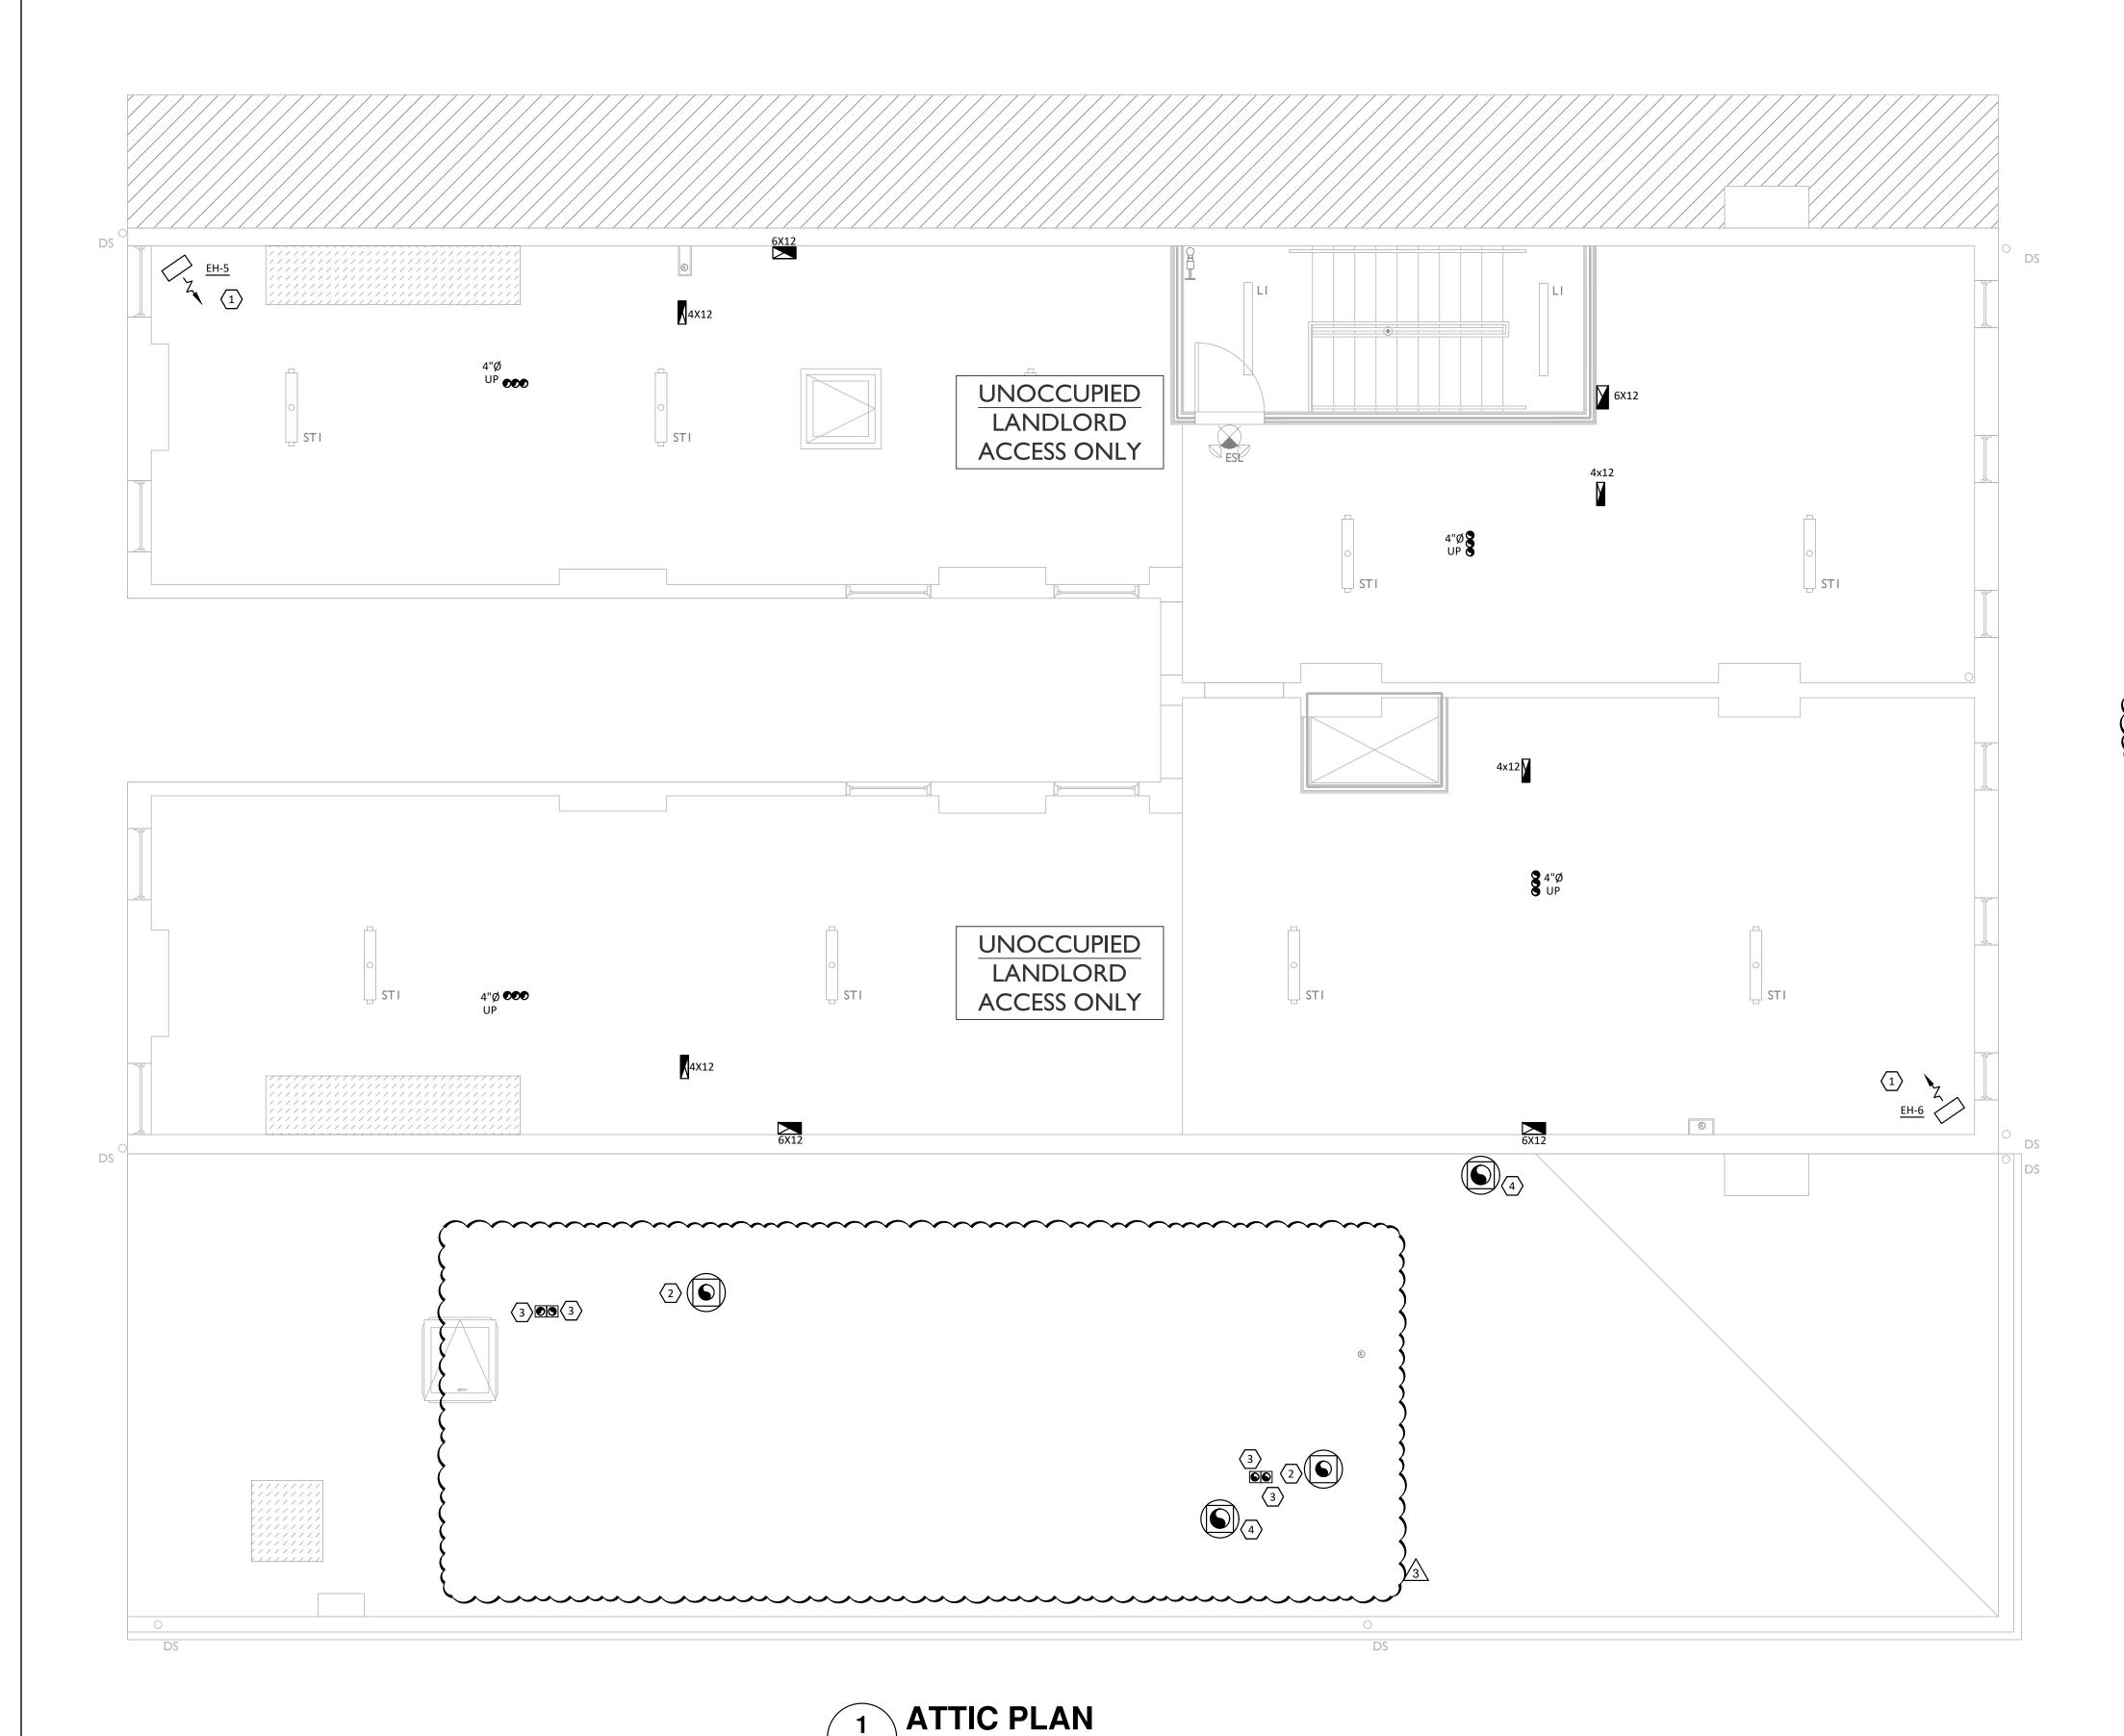


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1 05.27.2022 - REVISION #1 3 08.18.2023 - REVISION #3

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- EXHAUST AIR DUCTS SHALL BE EQUIPPED WITH BACKDRAFT DAMPERS.
- M. ALL DUCT OPENINGS AND OTHER AIR DISTRIBUTION OPENINGS SHALL BE COVERED DURING CONSTRUCTION EXCEPT FOR TESTING AND INSPECTION.
- N. PROVIDE BUILDING OWNER OR REPRESENTATIVE WITH DETAILED OPERATING AND MAINTENANCE INSTRUCTIONS AND WARRANTIES /WRITTEN GUARANTEE FOR EACH SYSTEM. O&M INSTRUCTIONS SHALL BE CONSISTENT WITH OSHA REQUIREMENTS IN CCR TITLE 8, SECTION 5142 AND OTHER RELATED REGULATIONS.
- . ALL DUCT ELBOWS SHALL BE LONG RADIUS OR MITERED.

KEYED NOTES

- PROVIDE ELECTRIC UNIT HEATER, WITH UNIT MOUNTED THERMOSTAT. HEATER SHALL BE MOUNTED FROM CEILING. SET THERMOSTAT TO 60°F (ADJUSTABLE).
- PROVIDE GREENHECK, OR EQUIVALENT MODEL GRSR-8 EXHAUST HOOD AND INSTALL ON 12" HIGH INSULATED ROOF CURB.

 PROVIDE DRYER JACK MODEL DJK486U, OR EQUIVALENT DRYER VENT. AND INSTALL ON 12" HIGH INSULATED ROOF CURB.

 MAINTAIN MINIMUM 10' CLEARANCE FROM ANY OUTDOOR AIR INTAKES.
- 4. PROVIDE GREENHECK, OR EQUIVALENT MODEL GRSR-10 EXHAUST HOOD AND INSTALL ON 12" HIGH INSULATED ROOF CURB.

HEAT PUMP HEATING CONTROLS

WHEN THE OUTDOOR TEMPERATURE IS BELOW THE COMPRESSOR LOCKOUT TEMPERATURE (35°F), ONLY THE AUXILIARY HEAT OPERATES. WHEN THE OUTDOOR TEMPERATURE IS ABOVE THE AUXILIARY LOCKOUT TEMPERATURE (35°F), ONLY THE COMPRESSOR OPERATES. BOTH COMPRESSOR LOCKOUT AND AUXILIARY LOCKOUT TEMPERATURES TO BE THE SAME TEMPERATURE (35°F).

NATURAL VENTILATION

OUTDOOR AIR IS OBTAINED FROM NATURAL VENTILATION, IN ACCORDANCE WITH SECTION 402.2 OF THE OHIO MECHANICAL CODE. THE MINIMUM OPENABLE AREA TO THE OUTDOORS EXCEEDS 4% OF THE FLOOR AREA BEING VENTILATED.

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OH COA #4715



08.15.2022 - BID SET

Progress Dates

Revisions

05.27.2022 - REVISION #1

08.18.2023 - REVISION #3

Design Team:
MARQUE ENGINEERING
Drawn by:
MARQUE ENGINEERING

ANGE STREET

Job No: 11920 04.26

M105



- THE DRAWINGS ARE DIAGRAMMATIC IN NATURE. EXACT LOCATIONS OF DEVICES AND ROUTING OF DUCTWORK SHALL BE DETERMINED BY CONTRACTOR AFTER COORDINATION WITH ALL OTHER TRADES AND FIELD DETERMINATION OF FINAL CONSTRUCTION DETAILS. MINOR ADJUSTMENTS TO DUCT ROUTING AND CONFIGURATION TO AVOID CONFLICT WITH BUILDING STRUCTURE OR OTHER TRADES SHALL BE INCLUDED IN CONTRACTOR'S PRICE. CONTRACTOR SHALL OBTAIN ENGINEERS APPROVAL IN WRITING FOR ANY MODIFICATIONS TO SYSTEM DESIGN PRIOR TO INSTALLATION.
- ALL EXPOSED MATERIALS AND EQUIPMENT SHALL BE INSTALLED AND SUPPORTED IN A FIRST-CLASS AND WORKMANLIKE FASHION. DUCTWORK SHALL RUN PARALLEL AND/ OR PERPENDICULAR TO MAIN BUILDING STRUCTURE. ANY WORK THAT IS NOT DONE IN A FIRST-CLASS OR WORKMANLIKE FASHION, IN THE ARCHITECTS OPINION, SHALL BE REDONE AT THE CONTRACTORS EXPENSE.
- ALL DUCT JOINTS, SEAMS AND CONNECTIONS SHALL BE SECURELY FASTENED AND SEALED. DUCTS SHALL BE SUPPORTED WITH APPROVED HANGERS AT INTERVALS NOT EXCEEDING TEN FEET. DUCT COVERINGS AND LININGS SHALL HAVE A FLAME-SPREAD INDEX NOT MORE THAN 25 AND A SMOKE DEVELOPED INDEX NOT MORE THAN 50.
- PROVIDE VOLUME DAMPERS AT ALL ROUND BRANCH DUCT TAKE-OFFS THAT ARE ACCESSIBLE. PROVIDE TURNING VANES AT ALL 90 DEGREE SQUARE ELBOWS IN SUPPLY AIR DUCTS. PROVIDE 45 DEGREE HEEL AT ALL RECTANGULAR SUPPLY AND RETURN BRANCH DUCT TAKE-OFFS.
- OUTDOOR AIR INTAKES SHALL BE 10'-0" MINIMUM AWAY FROM ANY EXHAUST AND PLUMBING VENT OUTLET.
- WIRE UP ALL LOW VOLTAGE (24V) THERMOSTATS.
- CONTRACTOR SHALL COORDINATE THE LOCATION OF ALL PIPES, DUCTWORK, UNITS, ETC. WITH ALL OTHER TRADES AND SHIFT LOCATION OR OFFSET WHERE NECESSARY. PROVIDE TRANSITIONS IN DUCTWORK TO AVOID CONFLICT WITH EXISTING DUCTWORK AND OTHER STRUCTURES.
- CONTRACTOR SHALL COORDINATE ALL AIR DEVICES WITH ELECTRICAL AND ARCHITECTURAL REFLECTED CEILING PLANS.
- COORDINATE LOCATION OF ALL EXTERIOR LOUVER OR OUTLET WITH ARCHITECTURAL ELEVATION PLAN.
- COORDINATE ROOF WORK WITH BUILDING OWNER'S ROOFING CONTRACTOR TO ASSURE THAT THE ROOF WARRANTY IS NOT
- INSTALL DUCTWORK AS HIGH AS POSSIBLE.
- EXHAUST AIR DUCTS SHALL BE EQUIPPED WITH BACKDRAFT DAMPERS.
- ALL DUCT OPENINGS AND OTHER AIR DISTRIBUTION OPENINGS SHALL BE COVERED DURING CONSTRUCTION EXCEPT FOR TESTING AND INSPECTION.
- PROVIDE BUILDING OWNER OR REPRESENTATIVE WITH DETAILED OPERATING AND MAINTENANCE INSTRUCTIONS AND WARRANTIES / WRITTEN GUARANTEE FOR EACH SYSTEM. O&M INSTRUCTIONS SHALL BE CONSISTENT WITH OSHA REQUIREMENTS IN CCR TITLE 8, SECTION 5142 AND OTHER RELATED REGULATIONS.
- ALL DUCT ELBOWS SHALL BE LONG RADIUS OR MITERED.

KEYED NOTES

- PROVIDE GREENHECK, OR EQUIVALENT MODEL GRSR-8 EXHAUST HOOD AND INSTALL ON 12" HIGH INSULATED ROOF CURB. PROVIDE HEAT PUMP AND LOCATE ON ROOF ON ANVIL INTERNATIONAL HAYDON H-BLOCK, OR EQUIVALENT, ROOFTOP SUPPORT SYSTEM, COMPLETE WITH ROOF PAD. MAINTAIN UNIT MINIMUM REQUIRED SERVICE AND AIRFLOW CLEARANCE. ROUTE REFRIGERANT LIQUID AND SUCTION LINES BETWEEN HEAT PUMP AND DUCTLESS SPLIT SYSTEM/AIR HANDLING UNIT AND SEAL ROOF PENETRATIONS WEATHER-TIGHT. PROVIDE PATE, OR EQUIVALENT, PIPE CURB FOR ALL ROOF PENETRATIONS. ROUTE AND SIZE LINES AND ACCESSORIES PER MANUFACTURER'S GUIDELINES. PROVIDE A FULLY CHARGED SYSTEM AND INSULATE ALL REFRIGERANT PIPING WITH ARMAFLEX INSULATION.
- PROVIDE DRYER JACK MODEL DJK486U, OR EQUIVALENT DRYER VENT. AND INSTALL ON 12" HIGH INSULATED ROOF CURB. MAINTAIN MINIMUM 10' CLEARANCE FROM ANY OUTDOOR AIR INTAKES.
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OH COA #4715

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Design Team: MARQUE ENGINEERING

MARQUE ENGINEERING

Drawn by:

Job No: 11920

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SPLIT SYSTEM HEAT PUMP SCHEDULE

	INDOOR UNIT												
TAG	MANUFACTURER	MODEL	NOMINAL TONNAGE	SUPPLY CFM	OA CFM	FAN HP	E.S.P.	AUX HEAT KW	VOLTAGE	ELECTI PHASE	RICAL MCA	MOCP	WEIGHT LBS
AHU-1	ICP	FMA4X1800AL	1.0	400	-	1/3	0.5"	5	230	1	28.5	30	103
AHU-2	ICP	FMA4X1800AL	1.0	400	-	1/3	0.5"	5	230	1	28.5	30	103
AHU-3	ICP	FMA4X1800AL	1.0	400	-	1/3	0.5"	5	230	1	28.5	30	103
AHU-4	ICP	FMA4X1800AL	1.0	450	-	1/3	0.5"	5	230	1	28.5	30	103
AHU-5	ICP	FMA4X1800AL	1.0	400	-	1/3	0.5"	5	230	1	28.5	30	103
AHU-6	ICP	FMA4X1800AL	1.0	400	-	1/3	0.5"	5	230	1	28.5	30	103
AHU-7	ICP	FMA4X1800AL	1.0	400	-	1/3	0.5"	5	230	1	28.5	30	103
AHU-8	ICP	FMA4X1800AL	1.0	400	-	1/3	0.5"	5	230	1	28.5	30	103
AHU-9	ICP	FMA4X1800AL	1.0	400	-	1/3	0.5"	5	230	1	28.5	30	103
AHU-10	ICP	FMA4X1800AL	1.0	450	-	1/3	0.5"	5	230	1	28.5	30	103
AHU-11	ICP	FMA4X1800AL	1.0	400	-	1/3	0.5"	5	230	1	28.5	30	103
AHU-12	ICP	FMA4X1800AL	1.0	400	-	1/3	0.5"	5	230	1	28.5	30	103
AHU-13	ICP	FMA4X1800AL	1.0	400	-	1/3	0.5"	5	230	1	28.5	30	103
AHU-14	ICP	FMA4X1800AL	1.0	400	-	1/3	0.5"	5	230	1	28.5	30	103
AHU-15	ICP	FMA4X1800AL	1.0	400	-	1/3	0.5"	5	230	1	28.5	30	103
AHU-16	ICP	FMA4X1800AL	1.0	400	-	1/3	0.5"	5	230	1	28.5	30	103

		OUTD	OOR UNIT		COMBINED ARI RATING								
TAG	MANUFACTURER	MODEL	VOLTAGE	ELECT PHASE	RICAL MCA	MOCP	WEIGHT LBS	TOTAL MBH	SENSIBLE MBH	SEER	HEATING MBH	HSPF	REMARKS
HP-1	ICP	DLCSRBH12AAK	208	1	15	15	74	12.6	10.08	15.5	7.2 @ 17°F	9.5	A,B,C
HP-2	ICP	DLCSRBH12AAK	208	1	15	15	74	12.6	10.08	15.5	7.2 @ 17°F	9.5	A,B,C
HP-3	ICP	DLCSRBH12AAK	208	1	15	15	74	12.6	10.08	15.5	7.2 @ 17°F	9.5	A,B,C
HP-4	ICP	DLCSRBH12AAK	208	1	15	15	74	12.6	10.08	15.5	7.2 @ 17°F	9.5	A,B,C,D
HP-5	ICP	DLCSRBH12AAK	208	1	15	15	74	12.6	10.08	15.5	7.2 @ 17°F	9.5	A,B,C,D
HP-6	ICP	DLCSRBH12AAK	208	1	15	15	74	12.6	10.08	15.5	7.2 @ 17°F	9.5	A,B,C,D
HP-7	ICP	DLCSRBH12AAK	208	1	15	15	74	12.6	10.08	15.5	7.2 @ 17°F	9.5	A,B,C
HP-8	ICP	DLCSRBH12AAK	208	1	15	15	74	12.6	10.08	15.5	7.2 @ 17°F	9.5	A,B,C
HP-9	ICP	DLCSRBH12AAK	208	1	15	15	74	12.6	10.08	15.5	7.2 @ 17°F	9.5	A,B,C
HP-10	ICP	DLCSRBH12AAK	208	1	15	15	74	12.6	10.08	15.5	7.2 @ 17°F	9.5	A,B,C,D
HP-11	ICP	DLCSRBH12AAK	208	1	15	15	74	12.6	10.08	15.5	7.2 @ 17°F	9.5	A,B,C,D
HP-12	ICP	DLCSRBH12AAK	208	1	15	15	74	12.6	10.08	15.5	7.2 @ 17°F	9.5	A,B,C,D
HP-13	ICP	DLCSRBH12AAK	208	1	15	15	74	12.6	10.08	15.5	7.2 @ 17°F	9.5	A,B,C
HP-14	ICP	DLCSRBH12AAK	208	1	15	15	74	12.6	10.08	15.5	7.2 @ 17°F	9.5	A,B,C
HP-15	ICP	DLCSRBH12AAK	208	1	15	15	74	12.6	10.08	15.5	7.2 @ 17°F	9.5	A,B,C,D
HP-16	ICP	DLCSRBH12AAK	208	1	15	15	74	12.6	10.08	15.5	7.2 @ 17°F	9.5	A,B,C,D

A. ALL HVAC EQUIPMENT TO BE FIELD LABELED TO IDENTIFY WHICH AREAS OF THE BUILDING THEY SERVE.

B. MERV 8 PLEATED FILTER.

UNIT MOUNTED NON FUSED DISCONNECT SWITCH (INDOOR UNIT ONLY)

D. INVERTER COMPRESSOR

EXHAUST	FAN SCHEDULE	=

TAG	MANUFACTURER	MODEL	CFM	ESP	RPM	WATTS	VOLTAGE	Ф	FLA	WEIGHT LBS	SONES	REMARKS
EF-1	PANASONIC	FV-0511VKSL2	30/80	0.4"	1150	16	120	1	ı	10	0.6	A,B,C,D,E,F

- A. FAN TO BE RUN CONTINUOUSLY AT MINIMUM CFM AND MAXIMUM CFM ACTIVATED BY SWITCH
- B. DISCONNECT SWITCH
- C. BACKDRAFT DAMPER
- D. ALUMINUM GRILLE WITH WHITE ENAMEL FINISH
- F. INTEGRAL RADIATION DAMPER WHEN PASSING THROUGH RATED ASSEMBLIES

AIR DEVICE SCHEDULE

TAG	MANUFACTURER	MODEL	FUNCTION	FACE SIZE	BORDER TYPE	MATERIAL	FINISH	REMARKS
SR-1	HART & COOLEY	821	SUPPLY	10X6	SURFACE	STEEL	WHITE	A,B
SR-2	HART & COOLEY	821	SUPPLY	10X8	SURFACE	STEEL	WHITE	A,B,D
TG-1	HART & COOLEY	A650	RETURN	16X10	SURFACE	ALUMINUM	WHITE	С
RG-1	HART & COOLEY	A650	RETURN	16X10	SURFACE	ALUMINUM	WHITE	В
		•						

- A. PROVIDE VOLUME DAMPERS IN TAKEOFFS WHERE ACCESSIBLE. WHERE DAMPERS ARE NOT ACCESSIBLE, PROVIDE OPPOSED BLADE DAMPER AT DIFFUSER
- B. COORDINATE FRAME TYPE WITH ARCHITECTURAL REFLECTED CEILING PLAN
- C. PROVIDE WALL MOUNTING FRAME AND TRANSFER KIT D. CEILING DAMPER

ELECTRIC HEATER SCHEDULE									
TAG	MANUFACTURER	MODEL	KW	втин	El	_ECTRICA	L	REMARKS	
TAG	MANUFACTURER	WIODEL	NVV	ВТОП	VOLTAGE	PHASE	AMP	INLIVIANNO	
EH-1	QMARK	CDFRE548	3.0	11,260	208	1	14.5	С	
EH-2	QMARK	CDFRE548	3.0	11,260	208	1	14.5	С	
EH-3	QMARK	MUH0381	3.0	11,260	208	1	14.5	A,B	
EH-4	QMARK	MUH0381	3.0	11,260	208	1	14.5	A,B	
EH-5	QMARK	MUH102	7.5	25,600	208	1	36	A,B	
EH-6	QMARK	MUH102	7.5	25,600	208	1	36	A,B	

REMARKS:


- A. CEILING MOUNTING BRACKET
- B. UNIT MOUNTED THERMOSTAT AND DISCONNECT SWITCH
- C. PROVIDE COMPLETE UNIT WITH 120V RELAY, RECESSED MOUNTING ENCLOSURE, AND DISCONNECT

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OH COA #4715




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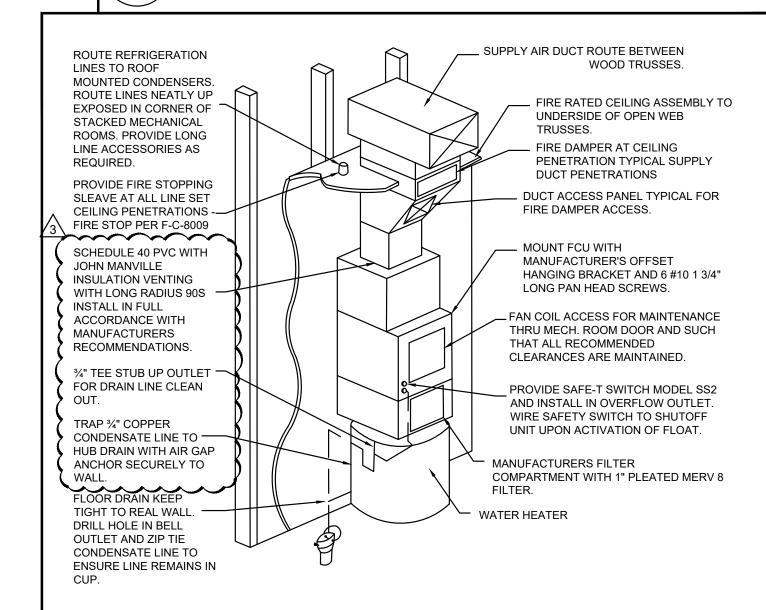
Design Team:

MARQUE ENGINEERING Drawn by: MARQUE ENGINEERING

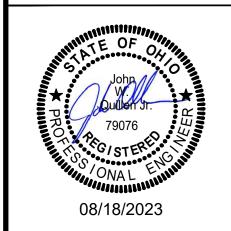Job No: 11920 04.26.2022



6 CEILING DIFFUSER DETAIL SCALE: NONE

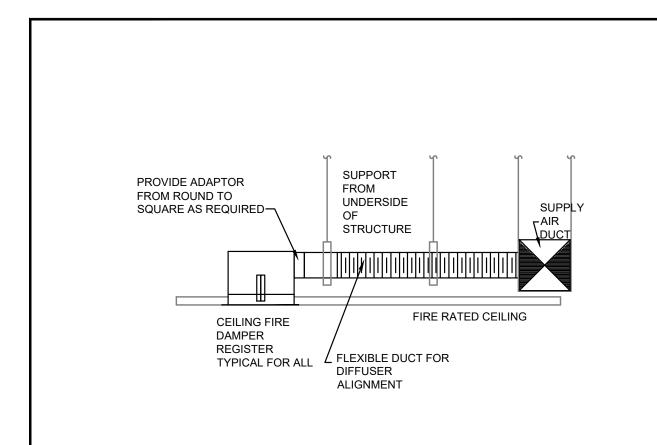

APARTMENT STACKED FAN COIL DETAIL


DUCT UNDER BEAM OR CROSSOVER


ROUND BRANCH DUCT

BRANCH DUCT

MANUAL VOLUME DAMPER
ON FITTING, TYPICAL


RUN EXPOSE DUCT TIGHT
TO DECK/UNDER GIRDER

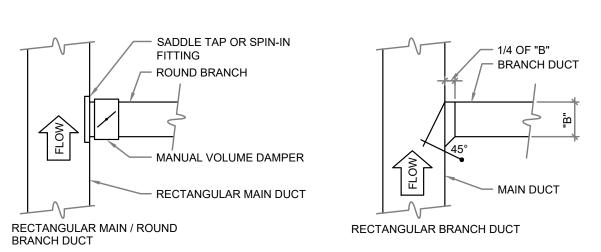

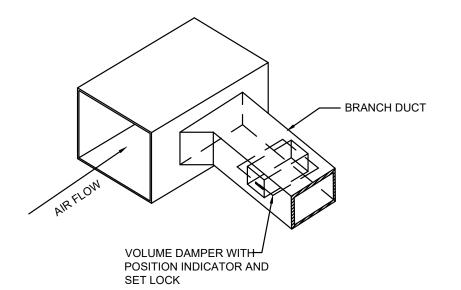


4 BRANCH DUCT TAKEOFF DETAIL

SCALE: NONE

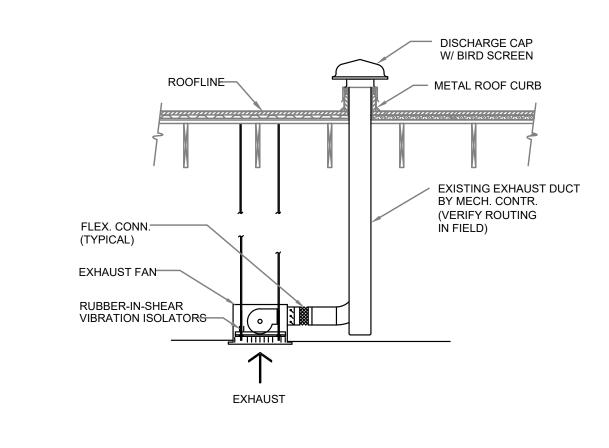

EXHAUST RISER DETAIL

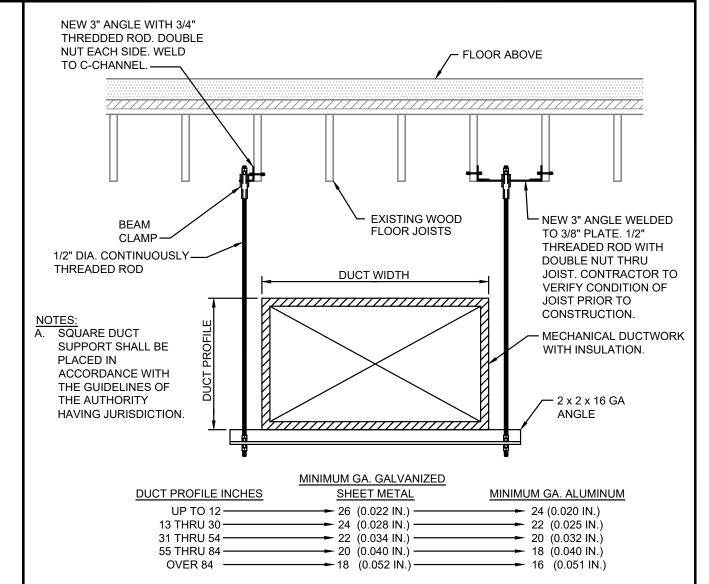


RECT. DUCT SUPPORT DETAIL

NEW 3" ANGLE WITH 3/4" THREDDED ROD. DOUBLE NUT EACH SIDE. WELD FLOOR ABOVE TO C-CHANNEL. — BEAM CLAMP-1/2" DIA. CONTINUOUSLY-TURNBUCKLE ADJUSTER THREADED ROD WITH LOCK NUTS 1/2" BOLT WITH NUT AND LOCK WASHER -1-1/2"x1/8" FLAT BAR DRAWBAND AROUND DUCTWORK GALVANIZED STEEL

2 ROUND DUCT SUPPORT DETAIL

SCALE: NONE

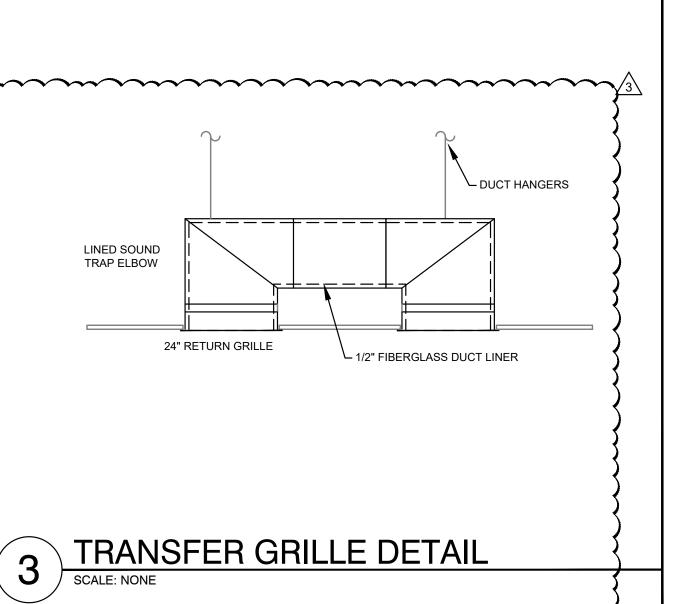

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Design Team:
MARQUE ENGINEERING
Drawn by:
MARQUE ENGINEERING

M20²

04.26.2022

23 05 01 COMMON REQUIREMENTS FOR HVAC

ALL MECHANICAL WORK AND TESTS SHALL BE DONE IN STRICT ACCORDANCE WITH THE LATEST STATE, COUNTY, AND LOCAL REGULATIONS, LAWS, AND ORDINANCES WHICH MAY BE APPLICABLE.

BEFORE SUBMITTING A BID, EXAMINE DOCUMENTS OF ALL OTHER TRADES, VISIT THE SITE AND GET ACQUAINTED WITH ALL CONDITIONS THAT MAY IN ANY WAY AFFECT THE EXECUTION OF THIS CONTRACT. TAKE MEASUREMENTS AND BE RESPONSIBLE FOR EXACT SIZE AND LOCATIONS OF ALL OPENINGS REQUIRED. VERIFY INSTALLATION MAY BE MADE IN COMPLETE ACCORDANCE WITH ALL PERTINENT CODES AND REGULATIONS. IN THE EVENT OF DISCREPANCY, IMMEDIATELY NOTIFY THE PROFESSIONAL ENGINEER OF RECORD. DO NOT PROCEED WITH THE INSTALLATION IN AREAS OF DISCREPANCY UNTIL ALL SUCH DISCREPANCIES HAVE BEEN FULLY RESOLVED.

IT IS NOT THE INTENT OF THE DRAWINGS THAT EXISTING CONDITIONS BE ACCURATELY SHOWN. EXISTING MECHANICAL WORK IS SHOWN TO LIMITED EXTENT ON DRAWINGS AND IS SHOWN FOR GENERAL REFERENCE ONLY. LOCATIONS AND INFORMATION WERE DERIVED FROM CURSORY SITE VISUAL OBSERVATIONS OR FROM DOCUMENTS THAT WERE PREPARED FOR PREVIOUSLY INSTALLED WORK WHEN AVAILABLE.

THE WORK COVERED BY THESE SPECIFICATIONS SHALL CONSIST OF PROVIDING ALL NEW MATERIAL, LABOR, EQUIPMENT, AND SERVICES NECESSARY FOR A COMPLETE MECHANICAL INSTALLATION AS SPECIFIED HEREIN. WORK IN THIS SECTION INCLUDES, BUT IS NOT LIMITED TO THE FOLLOWING ITEMS:

- SPLIT SYSTEM CONDENSING UNITS AIR HANDLING UNITS
- TOILET EXHAUST FANS
- LOW VOLTAGE THERMOSTATS/REMOTE SENSORS
- DUCT DAMPERS
- DIFFUSERS, REGISTERS, AND LOUVERS

WHENEVER THE WORDS "CONTRACTOR" APPEAR ON MECHANICAL DRAWINGS OR IN THESE SPECIFICATIONS, IT SHALL REFER TO THE MECHANICAL SUB-CONTRACTOR. WHENEVER THE WORD "PROVIDE" APPEARS IN THESE DOCUMENTS, IT SHALL BE INTERPRETED TO MEAN "FURNISH AND INSTALL".

COORDINATE ALL WORK WITH THE OWNER TO MINIMIZE INTERRUPTION OF BUILDING OPERATION.

COORDINATE THE INSTALLATION OF MECHANICAL ITEMS WITH THE SCHEDULES FOR WORK OF ALL OTHER TRADES TO PREVENT UNNECESSARY DELAYS IN THE TOTAL WORK.

THIS CONTRACTOR SHALL VERIFY AND SATISFY HIMSELF THAT ALL EQUIPMENT FURNISHED WILL PROPERLY FIT IN THE SPACE PROVIDED, THAT IT WILL FUNCTION PROPERLY, AND THAT ALL PARTS OF EQUIPMENT REQUIRING SERVICE ARE

ALL PIPING SHALL BE RUN PARALLEL OR PERPENDICULAR TO BUILDING WALLS AND FRAMING SYSTEM. ALL VERTICAL RUNS SHALL BE HELD AGAINST WALLS, COLUMNS, ETC., AS POSSIBLE TO PERMIT MAKING OF PIPE JOINTS.

CONTRACTOR SHALL PROVIDE A GUARANTEE IN WRITTEN FORM STATING THAT ALL WORK SHALL BE FREE OF DEFECTS OR ERRORS, AND ALL EQUIPMENT, MATERIALS, OR PARTS FOR A PERIOD OF ONE YEAR FROM THE DATE OF OWNER'S FINAL ACCEPTANCE AND SHALL REPAIR, REVISE OR REPLACE AT NO COST TO THE OWNER ANY SUCH DEFECTS OCCURRING WITHIN THE GUARANTEE PERIOD.

CONTRACTOR SHALL ALSO STATE IN WRITTEN FORM THAT ANY ITEMS OR OCCURRENCES ARISING DURING THE GUARANTEE PERIOD WILL BE ATTENDED TO IN A TIMELY MANNER AND WILL IN NO CASE EXCEED THREE (3) WORKING DAYS FROM DATE OF NOTIFICATION BY OWNER.

PROVIDE A COMPLETE INSTALLATION IN CONFORMANCE WITH THE FOLLOWING STANDARDS. AGA: AMERICAN GAS ASSOCIATION

ASHRAE: AMERICAN SOCIETY OF HEATING, REFRIGERATING AND AIR CONDITIONING ENGINEERS

NFPA: NATIONAL FIRE PROTECTION ASSOCIATION SMACNA: SHEET METAL AND AIR CONDITIONING CONTRACTORS NATIONAL ASSOCIATION.

STATEWIDE BUILDING CODE INTERNATIONAL MECHANICAL CODE

CONTRACTOR SHALL DO ALL CUTTING AND PATCHING REQUIRED FOR INSTALLATION OF THIS WORK. ALL OPENINGS IN WALLS, FLOORS OR CEILINGS SHALL BE PROPERLY SEALED AND RESTORED IN KIND. FLASH AND COUNTERFLASH AT ROOF

ALL EQUIPMENT SHALL BE LISTED AND LABELED, UNLESS OTHERWISE APPROVED.

ALL WIRING SHALL MEET THE REQUIREMENTS LISTED IN THE ELECTRICAL SPECIFICATIONS. ALL CONTROL AND INTERLOCK WIRING AND CONDUIT (120V OR 24V) SHALL BE BY THE MECHANICAL CONTRACTOR.

EQUIPMENT SHALL BE INSTALLED IN ACCORDANCE WITH THE CONDITIONS OF LISTING AND THE MANUFACTURER'S INSTALLATION INSTRUCTIONS AND THIS CODE.

CLEANING: THIS CONTRACTOR SHALL REMOVE FROM THE PREMISES ALL ACCUMULATION OF DIRT, DEBRIS, WASTE MATERIALS AND RUBBISH CAUSED BY HIS EMPLOYEES OR WORK, AT LEAST ONCE A WEEK, EXCEPT THAT COMBUSTIBLE MATERIALS SHALL BE REMOVED DAILY.

DURING PROGRESS OF THE WORK, MAINTAIN ON DRAWINGS AT THE SITE, AN ACCURATE RECORD OF THE INSTALLATION

OF THE MECHANICAL SYSTEM, INDICATING ALL ITEMS WHICH HAVE BEEN CHANGED OR ADDED. APPLY FOR AND PAY FOR ALL PERMITS AND INSPECTIONS REQUIRED BY LOCAL AUTHORITY, FOR THE APPROVAL OF

A CERTIFICATE OF FINAL INSPECTION AND APPROVAL SHALL BE SUBMITTED WITH THE CONTRACTOR'S REQUEST FOR FINAL PAYMENT. NO FINAL PAYMENT WILL BE APPROVED WITHOUT THIS CERTIFICATE.

GUARANTEE ALL WORKMANSHIP, MATERIAL, AND EQUIPMENT AND REPLACE ANY FOUND DEFECTIVE WORK WITHOUT COST TO THE OWNER, FOR A PERIOD OF ONE YEAR AFTER FINAL ACCEPTANCE.

DO NOT REUSE REMOVED MECHANICAL MATERIALS UNLESS SPECIFICALLY INDICATED ON DRAWINGS. EXISTING SYSTEMS MAY BE UTILIZED ONLY TO THE EXTENT INDICATED ON DRAWINGS.

IF REQUIRED TO ACCOMMODATE CONSTRUCTION RELATED ACTIVITIES TEMPORARILY REMOVE. STORE IN PROTECTED LOCATION ON SITE, AND REINSTALL CONFLICTING MECHANICAL EQUIPMENT, OR DEVICES THAT ARE TO REMAIN OR TO BE

WHERE THE TERM "DEMOLITION" IS USED HEREIN, INTERPRET IT TO MEAN "DEMOLITION" OR "SELECTIVE DEMOLITION" WHERE APPLICABLE.

PROVIDE MECHANICAL DEMOLITION WORK AS REQUIRED TO ACCOMMODATE PROJECT DEMOLITION AND AS REQUIRED TO ACCOMMODATE NEW CONSTRUCTION. DISCONNECT AND REMOVE WORK TO BE ABANDONED, AND AS REQUIRED TO ACCOMMODATE WORK OF OTHER TRADES, IN AREAS AFFECTED BY THIS PROJECT.

LEGALLY DISPOSE OF MATERIALS TO SALVAGED OR RETAINED.

23 05 03 SUBMITTALS FOR MECHANICAL SYSTEMS

DESIGN BASIS MANUFACTURERS OF MATERIAL AND EQUIPMENT ARE SPECIFIED AND PLANS ARE DETAILED ACCORDING TO THIS MATERIAL. CONTRACTOR SHALL BASE HIS BID ON FURNISHING AND INSTALLING THIS MAKE OF MATERIAL AND

AN ACCEPTABLE MANUFACTURER'S NAME AND MODEL NUMBER OF A PRODUCT MAY BE PROVIDED IN THESE DOCUMENTS. THIS IS THE EQUIPMENT INCLUDED DURING THE DESIGN PROCESS AND FORMS THE BASIS OF A STANDARD OF QUALITY. WHERE MORE THAN ONE MAKE OF MATERIAL OR EQUIPMENT IS SPECIFIED, THE CONTRACTOR SHALL STATE IN HIS BID WHICH MAKE HE PROPOSES TO FURNISH AND INSTALL. SHOP DRAWING APPROVAL SHALL BE OBTAINED PRIOR TO SHIPMENT OF EQUIPMENT.

VERIFY THE MODEL NUMBER OR PRODUCT IS STILL ACCURATE AND MEETS ALL REQUIREMENTS SHOWN ON THE DRAWINGS. IF THERE IS A DISCREPANCY BETWEEN THE REQUIREMENTS AND THE PRODUCT OR MODEL NUMBER, THE STRICTER OF THE TWO SHALL GOVERN.

SUBMIT SHOP DRAWINGS AND/OR PRODUCT DATA (ELECTRONIC COPIES) ON THE FOLLOWING ITEMS FOR REVIEW BEFORE FABRICATION OR SHIPMENT:

- SPLIT SYSTEM CONDENSING UNITS
- AIR HANDLING UNITS TOILET EXHAUST FANS
- LOW VOLTAGE THERMOSTATS/REMOTE SENSORS
- DUCT
- DAMPERS DIFFUSERS, REGISTERS, AND LOUVERS

MAINTENANCE MANUALS: THE MANUALS SHALL INCLUDE WIRING DIAGRAMS, MAINTENANCE AND OPERATING INSTRUCTIONS, PARTS LISTINGS, AND COPIES OF OTHER SUBMITTALS INDICATED FOR INCLUSION.

REVIEW AND CORRECTIONS OR COMMENTS MADE ON SHOP DRAWINGS, PRODUCT DATA: CATALOGS, CUT SHEETS, CHARTS, AND OTHER ITEMS DURING CONSTRUCTION PHASE SUBMITTAL REVIEW DO NOT RELIEVE CONTRACTOR FROM COMPLIANCE WITH REQUIREMENTS OF THE CONTRACT DOCUMENTS, FOR PROVIDING A COMPLETE AND FUNCTIONING PROJECT, NOR SHALL THEY RELIEVE CONTRACTOR FROM RESPONSIBILITY FOR DEVIATIONS OR ERRORS OF ANY SORT. THIS REVIEW IS FOR THE LIMITED PURPOSE OF CHECKING FOR CONFORMANCE WITH INFORMATION GIVEN AND THE DESIGN CONCEPT EXPRESSED IN THE CONTRACT DOCUMENTS. CONTRACTOR REMAINS RESPONSIBLE FOR DETERMINING THE ACCURACY AND COMPLETENESS OF OTHER DETAILS SUCH AS DIMENSIONS AND QUANTITIES, FOR SUBSTANTIATING

INSTRUCTIONS FOR INSTALLATIONS, VERIFYING MATERIALS REQUIRED, OBTAINING FIELD MEASUREMENTS AND RELATED CRITERIA, COORDINATING WORK WITH OTHER DISCIPLINES AND PERFORMING WORK IN COMPLIANCE WITH THE CONTRACT DOCUMENTS.

ANY CHANGES TO ITEMS SPECIFIED MUST BE SUBMITTED IN WRITING AS A SUBSTITUTION, WITH COMPLETE DOCUMENTATION OF PRICE DIFFERENTIAL AND EQUIPMENT DETAILS. ANY SUBSTITUTIONS PROVIDED SHALL BE REVIEWED AT MARQUE ENGINEERING'S HOURLY RATES. REVIEW SHALL BE PAID FOR BY THE CONTRACTOR TO MARQUE ENGINEERING AT NO COST TO THE OWNER. BY USING PRE-APPROVED SUBSTITUTIONS, THE CONTRACTOR ACCEPTS ALL RESPONSIBILITY AND ASSOCIATED COSTS FOR ALL REQUIRED MODIFICATIONS TO THE CONTRACT DOCUMENTS TO INCLUDE BUT NOT LIMITED TO MATERIAL OR EQUIPMENT COSTS FOR THEIR OR OTHER TRADES, AND ENSURING THAT SUBSTITUTED MATERIALS AND EQUIPMENT TO BE FURNISHED FIT INTO SPACE AVAILABLE.

EXTENSIVE REVISIONS NECESSITATED TO THE CONTRACT DOCUMENTS, OR SUBSTITUTION ACTIONS RELATED TO ANY SPECIFIED PRODUCT NOT ABLE TO BE PROVIDED DUE TO A FAILURE TO COMMENCE WORK, RELEASE PRODUCT OR COORDINATE CONSTRUCTION ACTIVITIES SHALL BE PROVIDED AT MARQUE ENGINEERING'S HOURLY RATES. COSTS SHALL BE BORN BY THE CONTRACTOR AT NO COST TO THE OWNER.

23 05 29 HANGERS AND SUPPORTS

SUPPORT ALL PIPING. DUCTWORK AND EQUIPMENT BY HANGERS OR BRACKETS. FURNISH STRUCTURAL STEEL MEMBERS WHERE REQUIRED TO SUPPORT PIPING AND EQUIPMENT. NO PORTION OF PIPING OR VALVES SHALL BE SUPPORTED BY

DUCTWORK - SUPPORT BY MEANS OF HANGERS AS FOLLOWS: DUCT WIDTH 30 OR LESS

HANGER SIZE (16 GAUGE) TYPE MAX. SPACING 8

A PAIR OF HANGERS SHALL BE LOCATED AT EVERY TRANSVERSE JOINT AND ELSEWHERE ACCORDING TO THE TABLE.

23 05 93 HVAC SYSTEM TESTING , ADJUSTING AND BALANCING FOR HVAC

ALL SYSTEMS AND EQUIPMENT SHALL BE CAREFULLY ADJUSTED TO PROVIDE COMFORTABLE AND UNIFORM CONDITIONS IN EACH AND EVERY SPACE TO THE OWNER'S SATISFACTION. PROVIDE ANY REQUIRED DRIVES TO SATISFY QUANTITIES INDICATED. PROVIDE A CERTIFIED AIR BALANCE OF THE DIFFUSERS AND AIR HANDLERS.

AIR BALANCE AND TESTING SHALL NOT BEGIN UNTIL THE SYSTEM HAS BEEN COMPLETED AND IS IN FULL WORKING ORDER. CONTRACTOR SHALL PUT ALL HEATING, VENTILATING AND AIR CONDITIONING SYSTEM AND EQUIPMENT INTO FULL OPERATION AND SHALL CONTINUE THE OPERATION OF SAME DURING EACH WORKING DAY OF TESTING AND BALANCING. CONTRACTOR SHALL SUBMIT WITHIN 30 DAYS AFTER RECEIPT OF CONTRACT, COPIES OF SUBMITTAL DATA FOR THE TESTING AND BALANCING OF THE AIR CONDITIONING, HEATING, AND VENTILATING SYSTEMS. THE AIR BALANCE AND TESTING AGENCY SHALL PROVIDE PROOF OF HAVING SUCCESSFULLY COMPLETED AT LAST FIVE PROJECTS OF SIMILAR

CONTRACTOR SHALL PROCURE THE SERVICES OF AN INDEPENDENT AIR BALANCE AND TESTING AGENCY, APPROVED BY THE ENGINEER, AND A MEMBER OF AABC OR NEBB, WHICH SPECIALIZES IN THE BALANCING AND TESTING OF HEATING VENTILATION AND AIR CONDITIONING SYSTEMS, TO BALANCE, ADJUST AND TEST AIR MOVING EQUIPMENT AND AIR DISTRIBUTION OR EXHAUST SYSTEMS AS HEREIN SPECIFIED.

ALL WORK BY THIS AGENCY SHALL BE DONE UNDER THE DIRECT SUPERVISION OF A QUALIFIED HEATING AND VENTILATING ENGINEER EMPLOYED BY THIS AGENCY. ALL INSTRUMENTS USED BY THIS AGENCY SHALL BE ACCURATELY CALIBRATED AND MAINTAINED IN GOOD WORKING ORDER.

23 07 13 DUCT INSTALLATION

INSULATE ALL SUPPLY, DIFFUSER PLENUMS, AND OUTSIDE AIR DUCTWORK OF ALL UNITS WITH OWENS CORNING "ALL SERVICE DUCT WRAP" TYPE 150 GLASS FIBER INSULATION UNLESS OTHERWISE NOTED. INSULATION SHALL BE 1-1/2" THICK (2" THICK FOR SUPPLY AND RETURN IN TRUSS SPACE). 1.5 PCF. DENSITY WITH FRK JACKET .002 THICK REINFORCED ALUMINUM FOIL VAPOR BARRIER. INSULATION SHALL CONFORM TO NFPA 90A AND 90B PER ASTM E-84 FOR FLAME SPREAD AND SMOKE DEVELOPED RATING.

INSULATE ALL EXTERIOR SUPPLY AND RETURN DUCTWORK WITH RIGID FIBERGLASS BOARD INSULATION WITH OUTDOOR JACKET. INSULATION SHALL BE 2" THICK WITH A 'K' VALUE OF 0.23 AT 75 F. INSTALL ON DUCTWORK USING IMPALE ANCHORS AND WIRES. SEAL VAPOR BARRIER WITH VAPOR BARRIER ADHESIVE.

PROVIDE INSULATION ON ALL CONCEALED SUPPLY, RETURN DUCTWORK. ALL LINERS, INSULATION AND ADHESIVES SHALL HAVE A FLAME SPREAD INDEX NOT MORE THAN 25 AND A SMOKE DEVELOPED INDEX OF NOT MORE THAN 50.

RIGID FIBERGLASS DUCTWORK INSULATION: GLASS FIBERS BONDED WITH A THERMOSETTING RESIN. COMPLY WITH ASTM C 612, TYPE IB, WITHOUT FACING AND WITH VAPOR BARRIER ALL-SERVICE JACKET MANUFACTURED FROM KRAFT PAPER, REINFORCING SCRIM, ALUMINUM FOIL, AND VINYL FILM. INSULATION SHALL HAVE A MINIMUM R VALUE AS REQUIRED BY CODE.

FLEXIBLE FIBERGLASS DUCTWORK INSULATION: GLASS FIBERS BONDED WITH A THERMOSETTING RESIN. COMPLY WITH ASTM C 553. TYPE II. WITHOUT FACING AND WITH VAPOR BARRIER ALL-SERVICE JACKET MANUFACTURED FROM KRAFT PAPER, REINFORCING SCRIM, ALUMINUM FOIL, AND VINYL FILM. INSULATION SHALL HAVE A MINIMUM R VALUE AS REQUIRED BY CODE

VAPOR BARRIER MATERIAL FOR DUCTWORK: PAPER-BACKED ALUMINUM-FOIL, EXCEPT AS OTHERWISE INDICATED; STRENGTH AND PERMEABILITY RATING EQUIVALENT TO FACTORY-APPLIED VAPOR BARRIERS ON ADJOINING DUCTWORK INSULATION, WHERE AVAILABLE; WITH FOLLOWING ADDITIONAL CONSTRUCTION CHARACTERISTICS:

HIGH PUNCTURE RESISTANCE: LOW VAPOR TRANSMISSION (FOR DUCTS IN EXPOSED AREAS: MECH. ROOMS, ETC.) MODERATE PUNCTURE RESISTANCE: MEDIUM VAPOR TRANSMISSION (FOR DUCTS IN CONCEALED AREAS).

INSTALLATION IS NOT PERMITTED ABOVE DRYWALL CEILINGS AND INACCESSIBLE CEILINGS.

23 09 93 SEQUENCE OF OPERATION

AIR HANDLING UNIT

STARTUP THE UNIT SHALL OPERATE ON A 7 DAY/NIGHT PROGRAMMABLE THERMOSTAT, DURING STARTUP, THE FAN SHALL RUN WITH THE DAMPERS IN THE FULL RECIRCULATION POSITION. PROVIDE OCCUPIED CHANGEOVER SEQUENCE WITH OPTIMUM START FUNCTION. WHEN THE RETURN AIR TEMPERATURE REACHES OCCUPIED SETPOINT (ADJUSTABLE), THE MINIMUM OUTSIDE AIR DAMPER SHALL OPEN TO THE CONTROLLED MINIMUM OUTDOOR AIR POSITION.

SUPPLY FAN CONTROL

THE SUPPLY FAN SPEED SHALL BE CONSTANT AND SET TO THE REQUIRED CFM.

SPACE TEMPERATURE CONTROL

PROVIDE LOCAL WALL MOUNTED ROOM TEMPERATURE THERMOSTAT WITH DIGITAL DISPLAY OFROOMTEMPERATURE AND SETPOINT (+/- DEG. F. ADJUSTABLE), AND OVERRIDE FEATURE. PROVIDE REMOTE SENSOR TO MONITOR SPACE TEMPERATURE AND MAINTAIN THERMOSTAT SETPOINT.

MINIMUM OUTSIDE AIR CONTROL

DURING OCCUPIED MODE THE MINIMUM OUTSIDE AIR DAMPER SHALL BE OPEN. PROVIDE MOTORIZED OUTDOOR AIR

COOLING CONTROL

COOLING SHALL BE CONTROLLED TO MAINTAIN SPACE TEMPERATURE SETPOINT. ON A CALL FOR COOLING THE HEATING SHALL BE OFF. ON A FURTHER CALL FOR COOLING, ENABLE THE ECONOMIZER MODE. ON A FURTHER CALL FOR COOLING, DISABLE THE ECONOMIZER MODE AND THE MECHANICAL COOLING SHALL BE STAGED ON.

HEATING CONTROL

HEATING SHALL BE CONTROLLED TO MAINTAIN SPACE TEMPERATURE SETPOINT. ON A CALL FOR HEATING, THE MECHANICAL COOLING SHALL BE OFF. ON A FURTHER CALL FOR HEATING, THE ECONOMIZER MODE SHALL BE DISABLED. ON A FURTHER CALL FOR HEATING THE GAS HEATING SHALL BE STAGED ON.

DURING THE UNOCCUPIED MODE OF OPERATION, THE AHU SHALL GO INTO NIGHT SETBACK MODE. AT NIGHT SETBACK/SHUTDOWN THE AHU SHALL GO TO FAIL SAFE POSITION. FAIL SAFE POSITION IS DEFINED BY THE FOLLOWING: THE SUPPLY FAN IS OFF. THE OUTDOOR AIR INTAKE DAMPER IS CLOSED. THE HEATING IS OFF AND THE MECHANICAL COOLING IS OFF. THE SUPPLY FAN SHALL CYCLE IN CONJUNCTION WITH EITHER THE HEATING OR COOLING SYSTEM TO MAINTAIN A MINIMUM/MAXIMUM SPACE TEMPERATURE DEPENDING ON THE SEASON.

LOW VOLTAGE THERMOSTATS SHALL BE PROVIDED AND WIRED BY THE HVAC CONTRACTOR. ELECTRICAL CONTRACTOR SHALL PROVIDE 4" SQUARE X 1- 1/2" DEEP WALL OUTLET BOXES (WITH SINGLE-GANG RINGS) FOR ALL THERMOSTATS/SENSORS. ELECTRICAL CONTRACTOR SHALL PROVIDE ONE 3/4" EMPTY CONDUIT FROM EACH THERMOSTAT/SENSOR LOCATION, TURNED OUT ABOVE ACCESSIBLE CEILINGS (IN JOIST SPACE OR AGAINST OVERHEAD SLAB/DECK). HVAC/TEMPERATURE CONTROL CONTRACTOR SHALL PROVIDE ALL OTHER NECESSARY CONDUIT, RACEWAY AND WIRING RELATED WORK. CONDUIT SHALL BE IDENTIFIED IN CEILING CAVITY AND SHALL BE PROVIDED WITH SWEEP BENDS, BUSHINGS AND DRAGLINE.

EXHAUST FANS SHALL BE TIED TO SWITCH, WHICH SHALL BE FURNISHED, INSTALLED AND WIRED BY ELECTRICAL CONTRACTOR, WHEN ACTIVATED, EXHAUST FAN MOTOR DAMPER SHALL OPEN AND FAN SHALL START.

INSTALL TRAP AT EVAPORATOR COIL DRAIN. EXTEND DRAIN LINE FROM COIL TRAP TO DRAIN. PIPING SHALL BE STANDARD

WEIGHT, PVC PIPE AND FITTINGS AND WITH JOINTS OF PVC SOLVENT CEMENT. PROVIDE CLEANOUTS THROUGHOUT RUN

23 30 00 AIR DISTRIBUTION SYSTEM

CEILING AIR DIFFUSERS:

SQUARE: SQUARE HOUSING, CORE OF SQUARE CONCENTRIC LOUVERS, SQUARE OR ROUND DUCT CONNECTION.

LINEAR: EXTRUDED ALUMINUM CONTINUOUS SLOT, SINGLE OR MULTIPLE.

DIFFUSER MOUNTINGS:

SURFACE MOUNT: DIFFUSER SHALL HAVE ROLLED EDGE BELOW FINISHED CEILING FOR SURFACE MOUNTING OR DIFFUSER SHALL BE FURNISHED WITH ACCESSORY PLASTER FRAME.

LAY-IN: DIFFUSER HOUSING SIZED TO FIT BETWEEN CEILING EXPOSED SUSPENSION TEE BARS AND REST ON TOP SURFACE

DIFFUSER ACOUSTIC PERFORMANCE: NC LESS THAN OR EQUAL TO 30

DIFFUSER ACCESSORIES: PLASTER RING: PERIMETER RING DESIGNED TO ACT AS PLASTER STOP AND DIFFUSER ANCHOR.

DIFFUSER FINISHES: WHITE ENAMEL: SEMI-GLOSS WHITE ENAMEL PRIME FINISH.

CEILING AND WALL REGISTERS & GRILLES:

STEEL CONSTRUCTION: MANUFACTURER'S STANDARD STAMPED SHEET STEEL FRAME AND ADJUSTABLE BLADES.

REGISTER AND GRILLE FINISHES: WHITE ENAMEL: SEMI-GLOSS WHITE ENAMEL PRIME FINISH.

REGISTER AND GRILLE ACOUSTIC PERFORMANCE: NC LESS THAN OR EQUAL TO 30

CONSTRUCTION, INSTALLATION AND SUPPORT OF ALL DUCTWORK SHALL CONFORM TO THE LATEST EDITION OF SMACNA "HVAC DUCT CONSTRUCTION STANDARD -METAL AND FLEXIBLE".

ASSEMBLE AND INSTALL DUCTWORK IN ACCORDANCE WITH RECOGNIZED INDUSTRY PRACTICES TO ACHIEVE AIR-TIGHT (5% LEAKAGE FOR SYSTEMS RATED 3" AND UNDER; 1% FOR SYSTEMS RATED OVER 3") AND NOISELESS (NO OBJECTIONABLE NOISE) SYSTEMS. INSTALL EACH RUN WITH MINIMUM NUMBER OF JOINTS. ALIGN DUCTWORK ACCURATELY AT CONNECTIONS, WITHIN 1/8" MISALIGNMENT TOLERANCE AND WITH INTERNAL SURFACES SMOOTH.

SUPPORT VERTICAL DUCTS AT EVERY FLOOR. SUPPORT DUCT WITH APPROVED HANGERS AT INTERVALS NOT EXCEEDING

DUCTS SHALL BE GALVANIZED SHEET METAL OF STANDARD GAUGES. DUCTWORK SHALL HAVE A MINIMUM THICKNESS

WHERE DUCTWORK IS INDICATED TO BE EXPOSED IN OCCUPIED SPACES, PROVIDE MATERIALS WHICH ARE FREE FROM VISUAL IMPERFECTIONS INCLUDING PITTING, SEAM MARKS, ROLLER MARKS, STAINS AND DISCOLORATIONS, AND OTHER IMPERFECTIONS, INCLUDING THOSE WHICH WOULD IMPAIR PAINTING.

EXPOSED DUCTWORK WHICH IS TO BE PAINTED SHALL HAVE PAINT GRIP APPLIED.

OF 24 GAUGE. ALL DUCT ELBOWS SHALL BE EITHER FULL RADIUS OR WITH TURNING VANES.

PROVIDE VOLUME DAMPERS IN ALL BRANCH DUCTS OR AS REQUIRED FOR BALANCING TO REQUIRED AIR FLOWS.

PROVIDE RADIUS TYPE FITTINGS FABRICATED OF MULTIPLE SECTIONS WITH MAXIMUM 15 DEG. CHANGE OF DIRECTION PER SECTION. UNLESS DETAILED OTHERWISE, USE 45 DEG. LATERALS AND 45 DEG. ELBOWS FOR BRANCH TAKEOFF CONNECTIONS. WHERE 90 DEG. BRANCHES ARE INDICATED, PROVIDE CONICAL TYPE TEES.

PROVIDE DUCT SEALANT AND/OR CEMENT WHICH IS NON-HARDENING, NON-MIGRATING MASTIC OR OF LIQUID ELASTIC SEALANT, TYPE APPLICABLE FOR FABRICATION/INSTALLATION DETAIL, AS COMPOUNDED AND RECOMMENDED BY MANUFACTURER SPECIFICALLY FOR SEALING JOINTS AND SEAMS IN DUCTWORK.

FLEXIBLE DUCTS SHALL EITHER BE SPIRAL-WOUND SPRING STEEL WITH FLAMEPROOF VINYL SHEATHING OR CORRUGATED ALUMINUM. THE MAXIMUM LENGTH OF FLEX DUCT ON THE SUPPLY EQUALS 5 FEET. FLEX IS NOT ALLOWED FOR RETURN, RELIEF OR EXHAUST APPLICATIONS.

WHERE INSTALLED IN UNCONDITIONED SPACES OTHER THAN RETURN AIR PLENUMS, PROVIDE 1" THICK 1-1/2 LB.

FLEXIBLE DUCTS SHALL CONFORM TO THE REQUIREMENTS OF UL 181 FOR CLASS 0 OR CLASS 1 FLEXIBLE AIR DUCTS AND

SHOP FABRICATE DUCTWORK IN 4, 8, 10 OR 12-FT LENGTHS, OR REQUIRED TO COMPLETE RUNS.

CONTINUOUS FLEXIBLE FIBERGLASS SHEATH WITH VINYL VAPOR BARRIER JACKET.

FABRICATE DUCTWORK WITH DUCT LINER IN EACH SECTION OF DUCT WHERE INDICATED. LAMINATE LINER TO INTERNAL SURFACES OF DUCT IN ACCORDANCE WITH INSTRUCTIONS BY MANUFACTURERS OF LINING AND ADHESIVE, AND FASTEN WITH MECHANICAL FASTENERS. DUCT LINER TO BE 3-LB DENSITY FOR ACOUSTIC REQUIREMENTS 1" THICK OR AS NOTED. SIZE OF DUCTWORK SHOWN ON THE DRAWINGS IS FREE NET AREA, OUTSIDE DIMENSION OF DUCTS WILL NEED TO BE

DUCT LINER SHALL BE OF FIBROUS GLASS OF THICKNESS INDICATED. 3-LB DENSITY. ALL LINERS, INSULATION AND ADHESIVES SHALL HAVE A FLAME SPREAD INDEX NOT MORE THAN 25 AND A SMOKE DEVELOPED INDEX OF NOT MORE

23 33 13 DAMPERS

DAMPERS WITH LOCKING DEVICE, WHERE ACCESSIBLE, SHALL BE RUSKIN MD-35. OPPOSED BLADE FOR RECTANGULAR DUCTS 12 INCHES AND ABOVE, AND MODEL MD-25 PARALLEL BLADE FOR DUCTS 10 INCHES AND BELOW, AND MODEL MDRS-25 FOR ROUND DUCTS. INSTALL PER MANUFACTURER'S INSTRUCTIONS. SINGLE BLADE ROUND DAMPERS WITH LOCKING DEVICE SHALL BE IN SPIN-IN COLLARS.

FIRE DAMPERS SHALL BE RUSKIN MODEL IBD. STYLE B WITH BLADE PACKAGE OUT OF AIR STREAM. HORIZONTAL. INSTALL WHERE INDICATED ON DRAWINGS AND AS REQUIRED BY AUTHORITY HAVING LOCAL JURISDICTION.

ELECTRIC MOTORIZED DAMPER SHALL BE SIZED TO OPERATE WITH SUFFICIENT RESERVE POWER TO PROVIDE SMOOTH MODULATING ACTION OR TWO-POSITION ACTION. INSTALL PER MANUFACTURER'S INSTRUCTIONS.

23 81 26 - CONDENSING UNITS

CONDENSING UNIT/HEAT PUMP:

AIR COOLED CONDENSING UNIT/HEAT PUMP AS SCHEDULED, OR EQUIVALENT. COOLING CAPACITY SHALL BE AS LISTED.

CASING: STEEL, FINISHED WITH BAKED ENAMEL IN COLOR SELECTED BY ARCHITECT, WITH REMOVABLE PANELS FOR ACCESS TO CONTROLS, WEEP HOLES FOR WATER DRAINAGE, AND MOUNTING HOLES IN BASE. PROVIDE BRASS SERVICE VALVES, FITTINGS, AND GAGE PORTS ON EXTERIOR OF CASING.

COMPRESSOR: HERMETICALLY SEALED SCROLL COMPRESSOR WITH CRANKCASE HEATER AND MOUNTED ON VIBRATION ISOLATION DEVICE. COMPRESSOR MOTOR SHALL HAVE THERMAL- AND CURRENT-SENSITIVE OVERLOAD DEVICES, START CAPACITOR, RELAY, AND CONTACTOR.

REFRIGERANT CHARGE: R-410A. REFRIGERANT COIL: COPPER TUBE, WITH MECHANICALLY BONDED ALUMINUM FINS AND LIQUID SUBCOOLER. COMPLY WITH ARI 210/240.

23 82 39 WALL HEATERS (WH)

SATISFIED AND UNTIL THE HEATING ELEMENT IS COOL.

EQUIVALENT (ETL).

THE HEATING EQUIPMENT SHALL INCLUDE ELECTRIC, AUTOMATIC FAN FORCED AIR HEATER SUITABLE FOR LARGE AREA HEATING. THE HEATER SHALL BE DESIGNED FOR WALL RECESS OR SURFACE MOUNTING. HEATERS SHALL BE UL LISTED OR

HEATER ASSEMBLY: THE HEATER ASSEMBLY WHICH FITS INTO THE BACK BOX SHALL CONSIST OF A FAN PANEL UPON WHICH IS MOUNTED ALL OF THE OPERATIONAL PARTS OF THE HEATER. HEATING ELEMENT: THE HEATING ELEMENT SHALL BE OF THE NON-GLOWING DESIGN CONSISTING OF A SPECIAL

RESISTANCE WIRE ENCLOSED IN A STEEL SHEATH TO WHICH STEEL PLATE FINS ARE COPPER BRAZED. IT SHALL BE

FAN AND MOTOR: FAN SHALL BE FIVE-BLADED ALUMINUM. FAN MOTOR SHALL BE TOTALLY ENCLOSED. FAN DELAY SWITCH: FAN CONTROL SHALL BE OF BI-METALLIC, SNAP-ACTION TYPE AND SHALL ACTIVATE FAN AFTER HEATING ELEMENT REACHES OPERATING TEMPERATURE. THE FAN SHALL CONTINUE TO OPERATE AFTER THE THERMOSTAT IS

THERMOSTAT: THE TAMPER-PROOF THERMOSTAT SHALL BE OF THE BI-METALLIC SNAP-ACTION TYPE WITH ENCLOSED CONTACTS. IT SHALL BE COMPLETELY CONCEALED BEHIND THE FRONT COVER TO BECOME TAMPER PROOF. THERMAL CUTOUT: A MANUAL-RESET THERMAL CUTOUT SHALL BE BUILT INTO THE SYSTEM TO SHUT OFF THE HEATER IN THE EVENT OF OVERHEATING.

POWER ON/OFF SWITCH: A DOUBLE-POLE, SINGLE THROW ON/OFF SWITCH SHALL BE MOUNTED ON THE BACK BOX FOR POSITIVE DISCONNECT OF POWER SUPPLY. IT WILL BE COMPLETELY CONCEALED BEHIND THE FRONT GRILLE PANEL. BACK BOX: THE BACK BOX SHALL BE DESIGNED FOR DUTY AS A RECESSED ROUGH-IN BOX IN EITHER MASONRY OR FRAME INSTALLATIONS, AND IS ALSO USED WITH THE SURFACE MOUNTING FRAME IN SURFACE MOUNTING INSTALLATIONS. THE BACK BOX SHALL BE 20-GAUGE GALVANIZED STEEL AND SHALL CONTAIN KNOCKOUTS THROUGH WHICH POWER LEADS

SWITCH: A DOUBLE-POLE, SINGLE THROW ON/OFF SWITCH SHALL BE MOUNTED ON THE BACK BOX FOR POSITIVE DISCONNECT OF POWER SUPPLY. IT WILL BE COMPLETELY CONCEALED BEHIND THE FRONT GRILLE PANEL.

FRONT PANEL: THE FRONT PANEL SHALL BE OF THE BAR GRILLE TYPE AND SHALL BE CONSTRUCTED OF 16-GAUGE COLD-ROLLED STEEL, WELDED INTO A UNIFORM GRILLE TO DIRECT THE WARMED AIR TOWARD THE FLOOR.

OH COA #4715

08/18/2023

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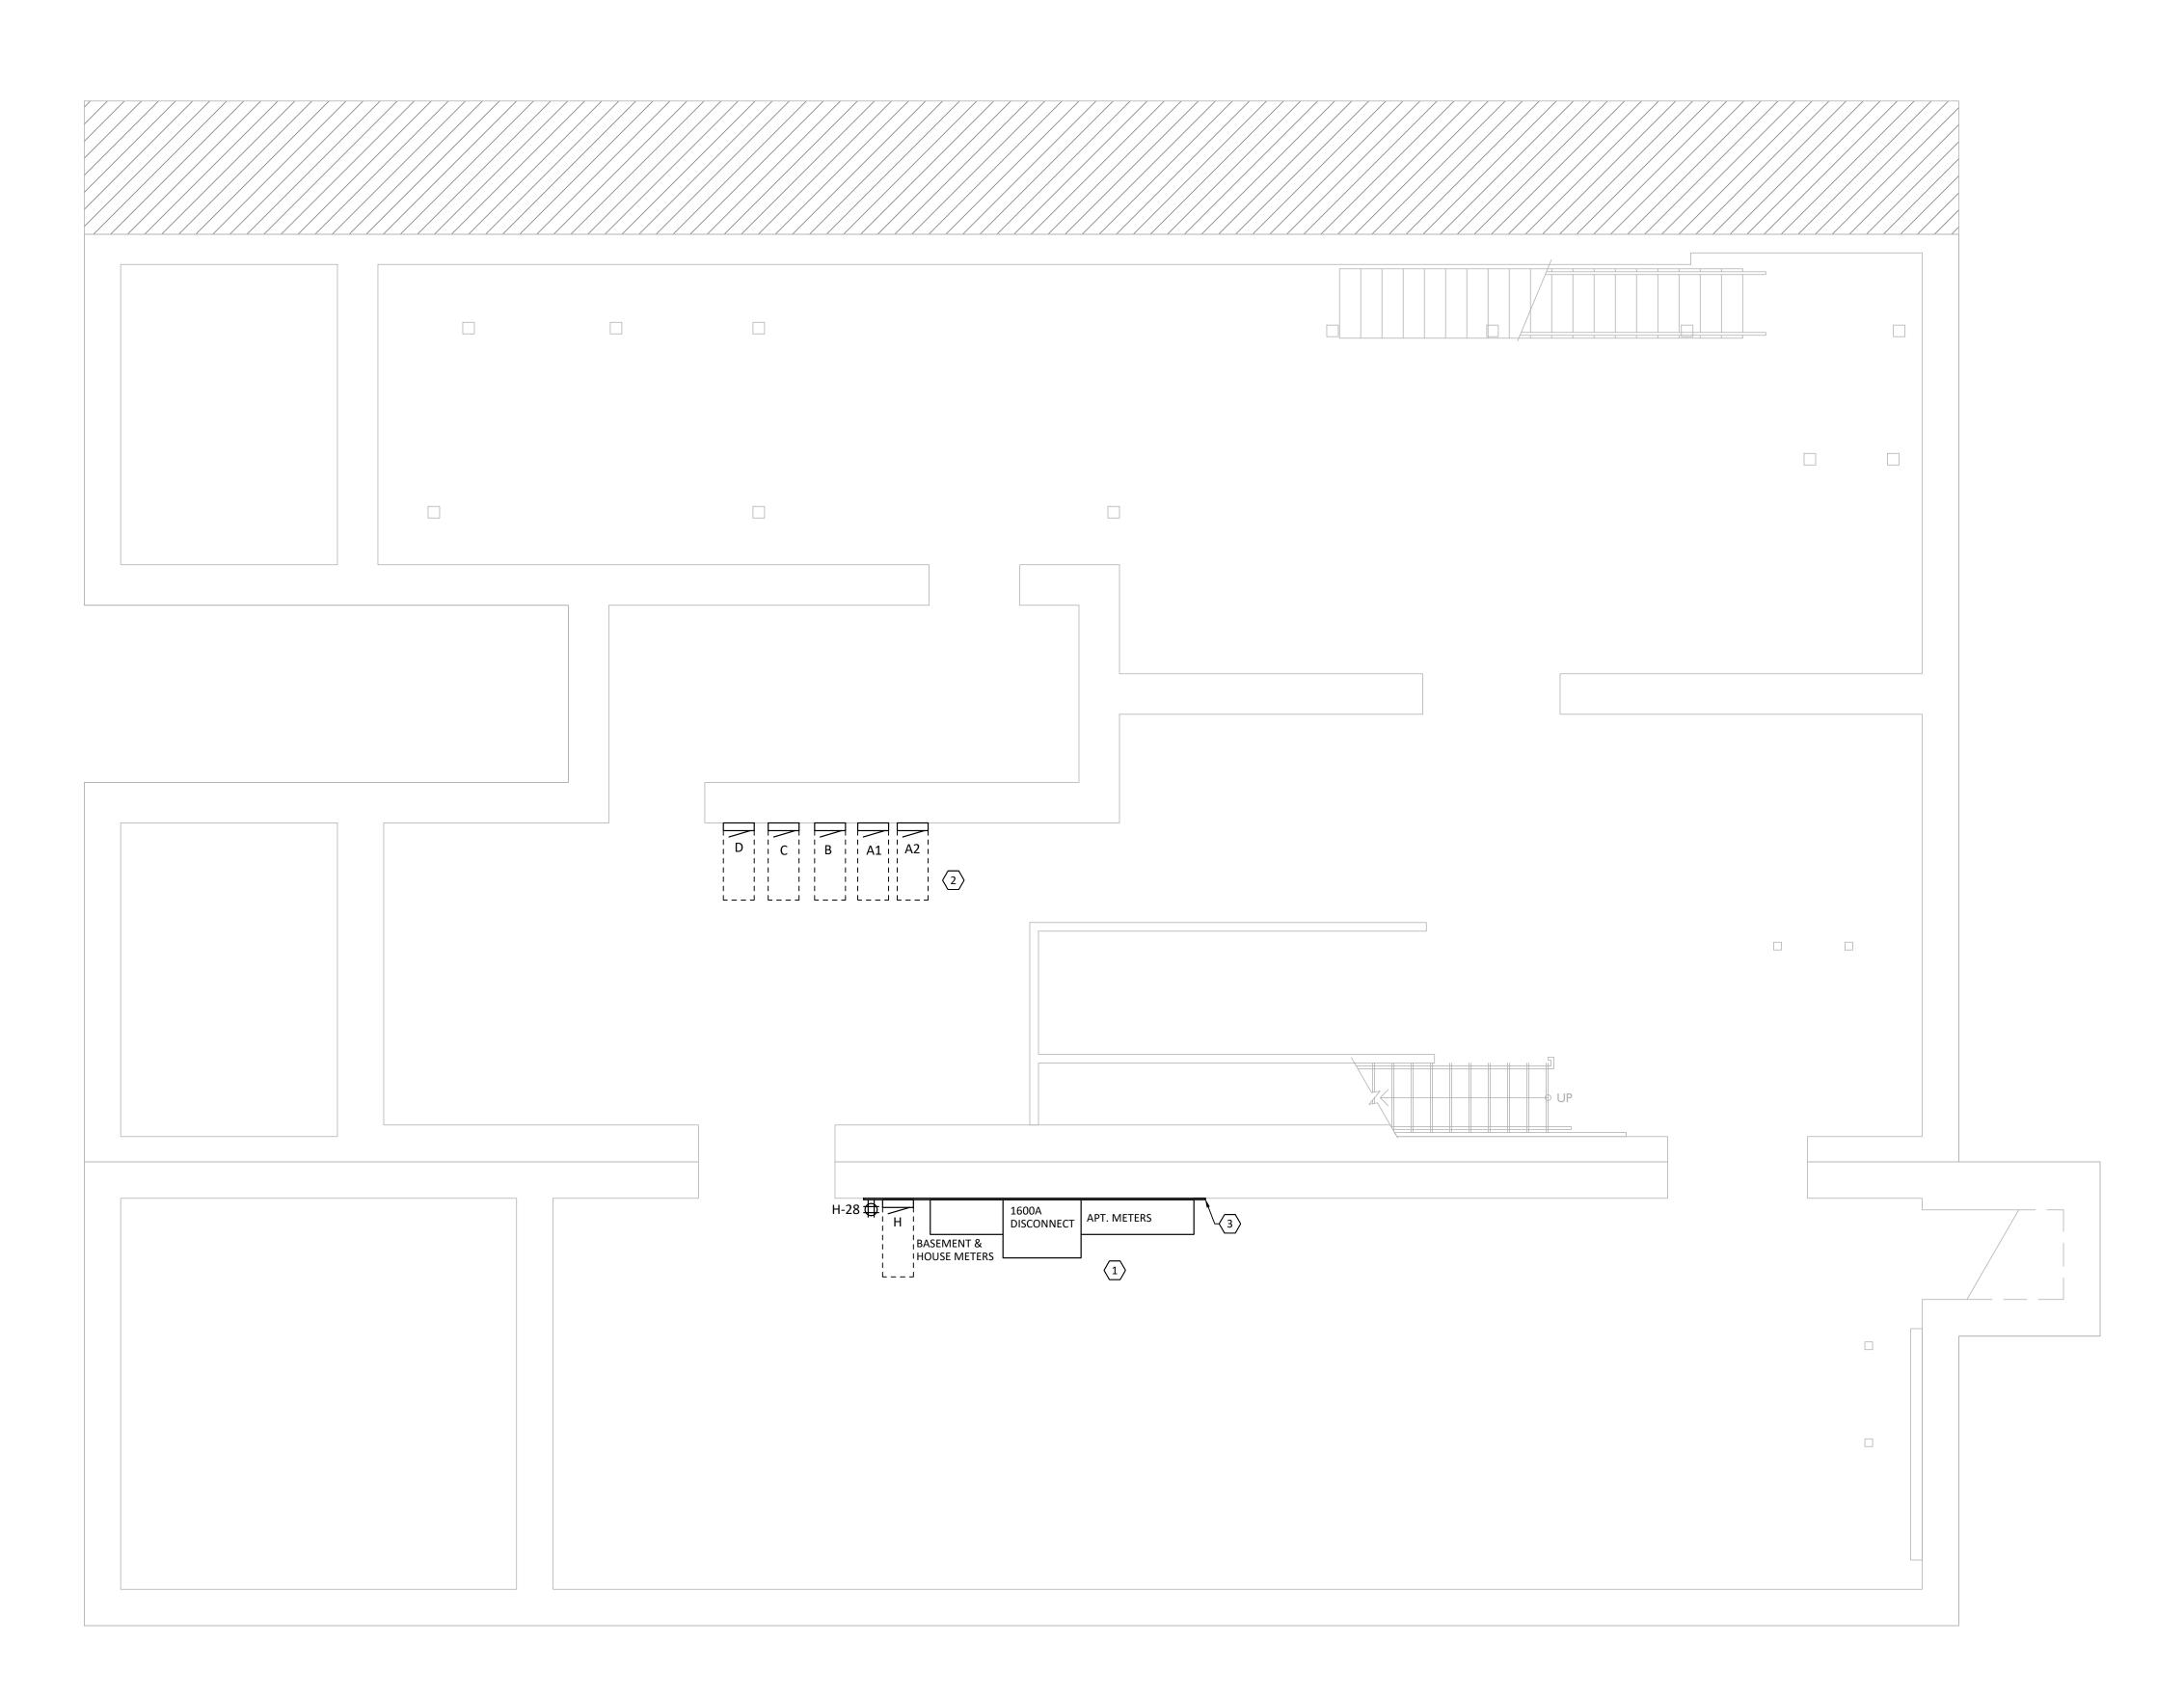
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BASEMENT POWER PLAN

E100 1/4" = 1'-0"

GENERAL NOTES

- ALL RECEPTACLES IN KITCHENS/BARS AND/OR WITHIN 6'-0" OF A WATER SOURCE MUST BE GFCI PROTECTED PER NEC. PROVIDE GFCI RECEPTACLES OR GFCI BREAKERS AS REQUIRED, REGARDLESS OF WHETHER OR NOT IT IS INDICATED ON PLANS.
- PROVIDE ALL SAW CUTTING AND PATCHING OF EXISTING FLOORS AND WALLS AS REQUIRED FOR INSTALLATION OF HIS WORK.
- UNLESS SPECIFICALLY NOTED OTHERWISE, ALL BRANCH CIRCUITS SHALL BE PROVIDED WITH (2)#12 (CU) THHN AND (1)#12 (CU) THHN GND IN 3/4" EMT CONDUIT FOR EACH 20 AMP CIRCUIT.
- ALL WORK SHOWN IS NEW, UNLESS OTHERWISE NOTED.
- ANY PENETRATIONS THROUGH FIRE-RESISTANT/RATED WALLS, PARTITIONS, FLOORS, AND CEILINGS SHALL BE FIRESTOPPED USING APPROVED METHODS TO MAINTAIN THE FIRE RESISTANCE RATING. REFER TO ELECTRICAL SPECIFICATIONS FOR ELECTRICAL DEVICE TYPES AND RATINGS.
- ALL CONDUITS SHALL BE CONCEALED IN WALLS AND OUTLET BOXES SHALL BE FLUSH WITH FINISHED WALL UNLESS OTHERWISE NOTED.
- RECEPTACLES TO BE MOUNTED AT 1'-6" ABOVE FINISHED FLOOR TO CENTER OF RECEPTACLE UNLESS NOTED OTHERWISE.
- PROVIDE JUNCTION BOX AND RACEWAY FOR THERMOSTATS AND HVAC LOW VOLTAGE CONTROLS AT 48" A.F.F. THERMOSTATS AND HVAC LOW VOLTAGE CONTROLS INSTALLED AND WIRED BY M.C.. COORDINATE EXACT LOCATIONS WITH M.C.. TYPICAL OF ALL.
- REFER TO ARCHITECTURAL DRAWINGS FOR DEVICE COLORS AND PART NUMBERS. IN THE CASE OF A CONFLICT BETWEEN LOCATIONS ON THE ELECTRICAL DRAWINGS AND LOCATIONS ON THE ARCHITECTURAL DRAWINGS, THE ARCHITECTURAL DRAWINGS SHALL TAKE PRIORITY.
- ALL RECEPTACLES MOUNTED ON EXPOSED BRICK/MASONRY WALLS SHALL HAVE SURFACE MOUNT CONDUIT RUN FROM BELOW.
- REFER TO SPECIFICATIONS FOR WIRE SIZING.
- ALL WORK SHALL BE PERFORMED IN STRICT CONFORMANCE TO THE LATEST NATIONAL ELECTRIC CODE (NEC) AND BY TRAINED AND LICENSED ELECTRICIANS.
- LIST OF EQUIPMENT, TABULATIONS OF DATA, SCHEDULES, ETC. APPEARING IN THE SPECIFICATIONS OR ON THE DRAWINGS ARE INCLUDED FOR REFERENCE BY THE CONTRACTOR IN ARRIVING AT A MORE COMPLETE UNDERSTANDING OF THE INTENDED INSTALLATION. THEY ARE NOT INTENDED TO BE CONSTRUED AS RELIEVING THE RESPONSIBILITY OF THE CONTRACTOR IN MAKING HIS/HER OWN TAKE-OFF AND PROVIDING ALL REQUIRED WORK.
- COORDINATE EXACT LOCATIONS OF EQUIPMENT WITH CONTRACTOR FURNISHING SUCH. COORDINATE EXACT ELECTRICAL WIRING AND CONNECTION REQUIREMENTS WITH SUBMITTAL DRAWINGS PRIOR TO ROUGH-IN. ALL WIRING REQUIREMENTS SHOWN ARE SCHEMATIC IN NATURE.
- O.A. COORDINATE ALL HVAC AND PLUMBING EQUIPMENT OVER-CURRENT PROTECTIVE DEVICES WITH RESPECTIVE DIVISIONAL PRODUCT DATA SUBMITTALS AND INSTALLING CONTRACTOR PRIOR TO FURNISHING SAID OVER-CURRENT PROTECTIVE DEVICES.
- O.B. COORDINATE SPECIALTY RECEPTACLE AND/OR OUTLET TYPES WITH EQUIPMENT REQUIREMENTS. O.C. WHEN LOOSE DISCONNECT SWITCHES ARE FURNISHED UNDER MECHANICAL CONTRACT, RECEIVE AND INSTALL AND PROVIDE ALL FINAL TERMINATIONS NECESSARY.
- ALL DEVICES SHOWN ON EXTERIOR OF THE BUILDING SHALL BE WEATHER PROOF TYPE.
- REFER TO ALL OTHER CONSTRUCTION TRADES' DRAWINGS AND SPECIFICATIONS FOR ADDITIONAL ELECTRICAL WORK THAT IS INCLUDED IN DIVISION 26'S SCOPE
- IN ADA UNITS, MOUNTING HEIGHT FOR BRANCH CIRCUIT BREAKER(S) SHALL NOT BE GREATER THAN 48"
- SMOKE DETECTORS SHALL BE INTERCONNECTED IN SUCH A MANNER THAT ACTIVATION OF ONE ALARM WILL ACTIVATE ALL ALARMS IN INDIVIDUAL UNITS.
- ALL RECEPTACLES WITHIN DWELLING UNITS SHALL BE TAMPER PROOF TYPE.
- ALL 120-VOLT, SINGLE PHASE 15 AND 20 AMP BRANCH CIRCUITS SUPPLYING OUTLETS OR DEVICES IN DWELLING UNITS SHALL HAVE AFCI PROTECTION. AFCI PROTECTION MAY BE ACHIEVED BY ANY APPROVED METHOD DETAILED IN NFPA 70, SECTION 201.12 (A).
- FOR ALL WASHERS/DRYERS WITHIN DWELLING UNITS, PROVIDE EITHER DIRECT OR CORD-AND-PLUG CONNECTIONS AS DETERMINED BY THE APPLIANCE(S) NAMEPLATE(S). AT WASHERS, PROVIDE A 120V 20A BRANCH CIRCUIT AND GFCI RECEPTACLE. AT DRYERS, PROVIDE A 30A/2P BRANCH CIRCUIT AND FLUSH 14-30A NEMA RECEPTACLE. NOTE WASHER/DRYER MAY BE EITHER DISPARATE APPLIANCES OR OF STACK-ABLE NATURE.
- . FOR ALL ELECTRIC RANGES, OVENS, AND COOK-TOP WITHIN DWELLING UNITS; PROVIDE 50A FLUSH NEMA RECEPTACLE AND MATCHING 50A/2P CIRCUIT BREAKER AND WIRE. CONTRACTOR SHALL FIELD VERIFY PRIOR TO INSTALLATION WITH APPLIANCE PACKAGE. FOR ALL GAS RANGES, OVENS, AND COOK-TOP; PROVIDE 120V 20A BRANCH CIRCUIT AND RECEPTACLE.

KEYED NOTES

- APPROXIMATE LOCATION OF NEW METER CENTER.
- EXISTING PANELS TO REMAIN. SUPPLEMENT/EXTEND/TERMINATE AS NEEDED EXISTING CONDUIT TO
- PROVIDE FIRE RESISTANT 3/4" PLYWOOD BACKBOARD FOR ELECTRICAL EQUIPMENT. COORDINATE EXACT DIMENSIONS IN FIELD TO ENSURE ADEQUATE SPACE FOR TELECOM/DATA EQUIPMENT MOUNTING.

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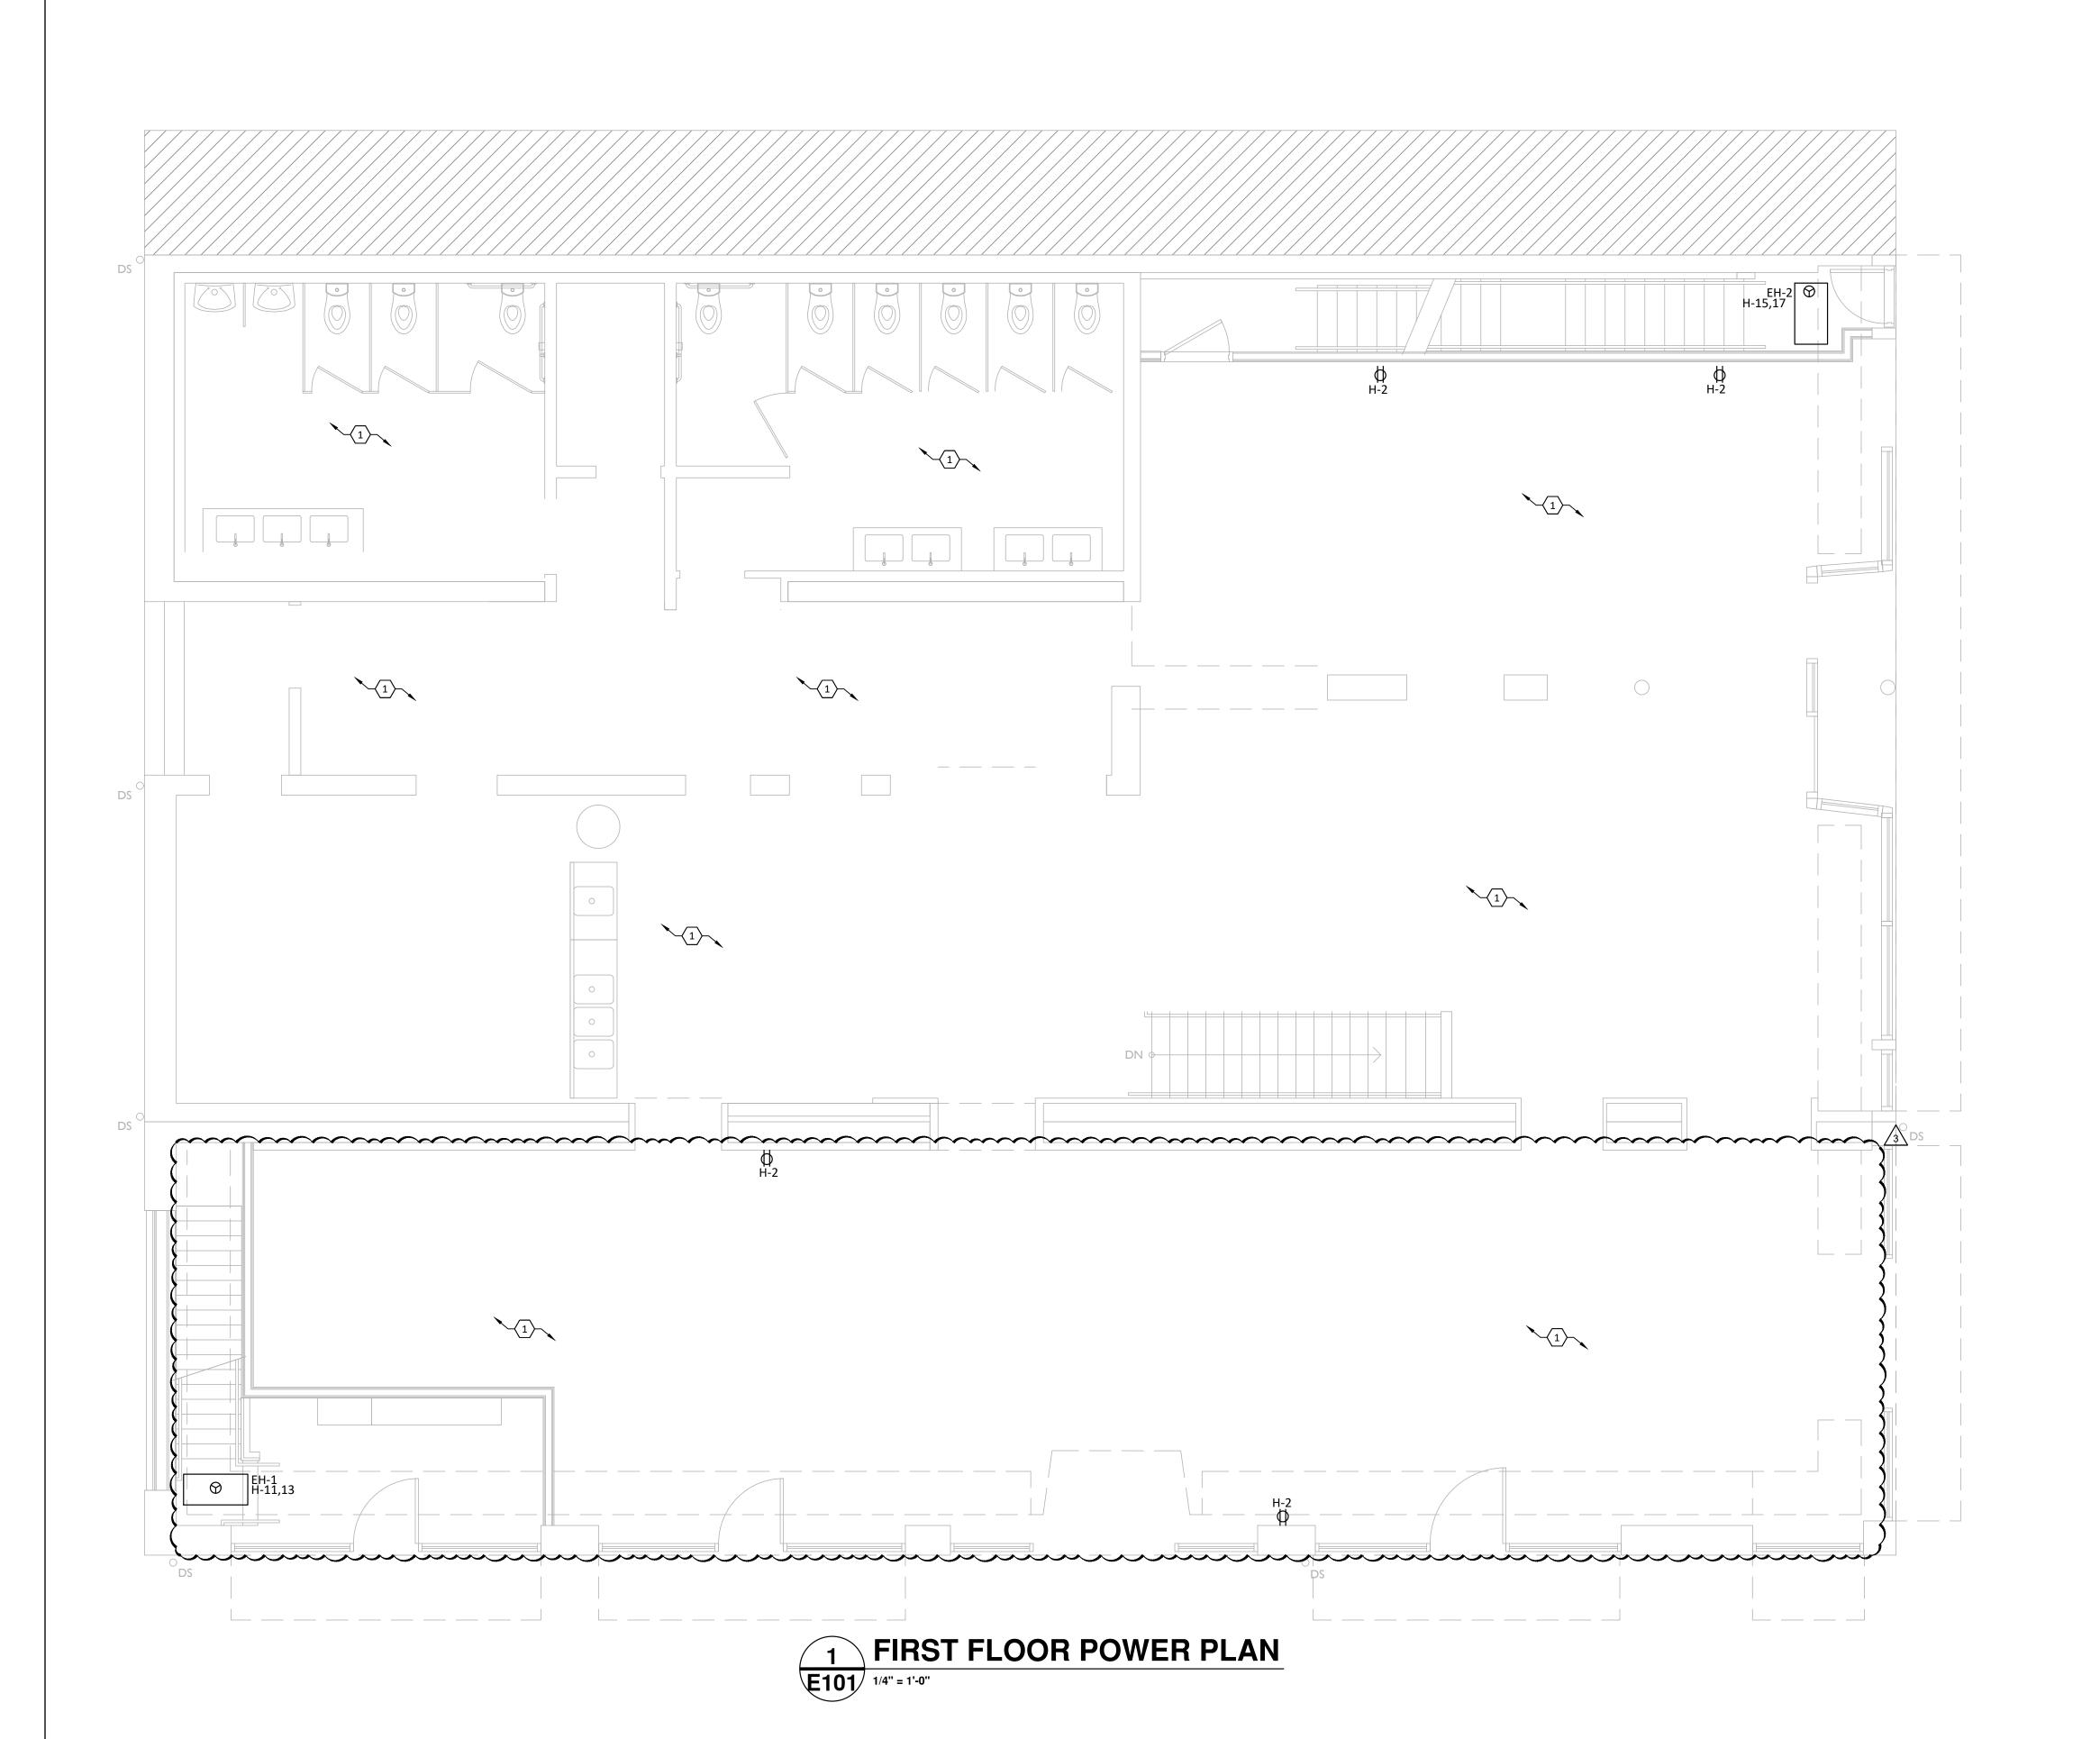
Progress Dates

08.15.2022 - BID SET

/i\ 05.27.2022 - REVISION #I 3 08.18.2023 - REVISION #3

> Design Team:
> MARQUE ENGINEERING Drawn by: MARQUE ENGINEERING

Job No: 11920 04.26.2022



- A. ALL RECEPTACLES IN KITCHENS/BARS AND/OR WITHIN 6'-0" OF A WATER SOURCE MUST BE GFCI PROTECTED PER NEC. PROVIDE GFCI RECEPTACLES OR GFCI BREAKERS AS REQUIRED, REGARDLESS OF WHETHER OR NOT IT IS INDICATED ON PLANS.
- . PROVIDE ALL SAW CUTTING AND PATCHING OF EXISTING FLOORS AND WALLS AS REQUIRED FOR INSTALLATION OF HIS WORK.
- C. UNLESS SPECIFICALLY NOTED OTHERWISE, ALL BRANCH CIRCUITS SHALL BE PROVIDED WITH (2)#12 (CU) THHN AND (1)#12 (CU) THHN GND IN 3/4" EMT CONDUIT FOR EACH 20 AMP CIRCUIT.
- ALL WORK SHOWN IS NEW, UNLESS OTHERWISE NOTED.
- E. ANY PENETRATIONS THROUGH FIRE-RESISTANT/RATED WALLS, PARTITIONS, FLOORS, AND CEILINGS SHALL BE FIRESTOPPED USING APPROVED METHODS TO MAINTAIN THE FIRE RESISTANCE RATING.
 F. REFER TO ELECTRICAL SPECIFICATIONS FOR ELECTRICAL DEVICE TYPES AND RATINGS.
- G. ALL CONDUITS SHALL BE CONCEALED IN WALLS AND OUTLET BOXES SHALL BE FLUSH WITH FINISHED WALL UNLESS OTHERWISE NOTED.
- H. RECEPTACLES TO BE MOUNTED AT 1'-6" ABOVE FINISHED FLOOR TO CENTER OF RECEPTACLE UNLESS NOTED OTHERWISE.
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- J. REFER TO ARCHITECTURAL DRAWINGS FOR DEVICE COLORS AND PART NUMBERS. IN THE CASE OF A CONFLICT BETWEEN LOCATIONS ON THE ELECTRICAL DRAWINGS AND LOCATIONS ON THE ARCHITECTURAL DRAWINGS, THE ARCHITECTURAL DRAWINGS SHALL TAKE PRIORITY.
- C. ALL RECEPTACLES MOUNTED ON EXPOSED BRICK/MASONRY WALLS SHALL HAVE SURFACE MOUNT CONDUIT RUN FROM BELOW.
- REFER TO SPECIFICATIONS FOR WIRE SIZING.
- M. ALL WORK SHALL BE PERFORMED IN STRICT CONFORMANCE TO THE LATEST NATIONAL ELECTRIC CODE (NEC) AND BY TRAINED AND LICENSED ELECTRICIANS.
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- INSTALL AND PROVIDE ALL FINAL TERMINATIONS NECESSARY.

 P. ALL DEVICES SHOWN ON EXTERIOR OF THE BUILDING SHALL BE WEATHER PROOF TYPE.
- Q. REFER TO ALL OTHER CONSTRUCTION TRADES' DRAWINGS AND SPECIFICATIONS FOR ADDITIONAL ELECTRICAL WORK THAT IS INCLUDED IN DIVISION 26'S SCOPE
- R. IN ADA UNITS, MOUNTING HEIGHT FOR BRANCH CIRCUIT BREAKER(S) SHALL NOT BE GREATER THAN 48"
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- T. ALL RECEPTACLES WITHIN DWELLING UNITS SHALL BE TAMPER PROOF TYPE.
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KEYED NOTES

1. EXISTING ELECTRICAL WORK ON THIS FLOOR TO REMAIN. FIRST FLOOR SPACES ARE SERVED BY EXISTING PANELS A1, A2, B, C, & D. REFER TO SINGLE LINE DIAGRAM AND METER CENTER LOAD SUMMARY FOR MORE INFORMATION

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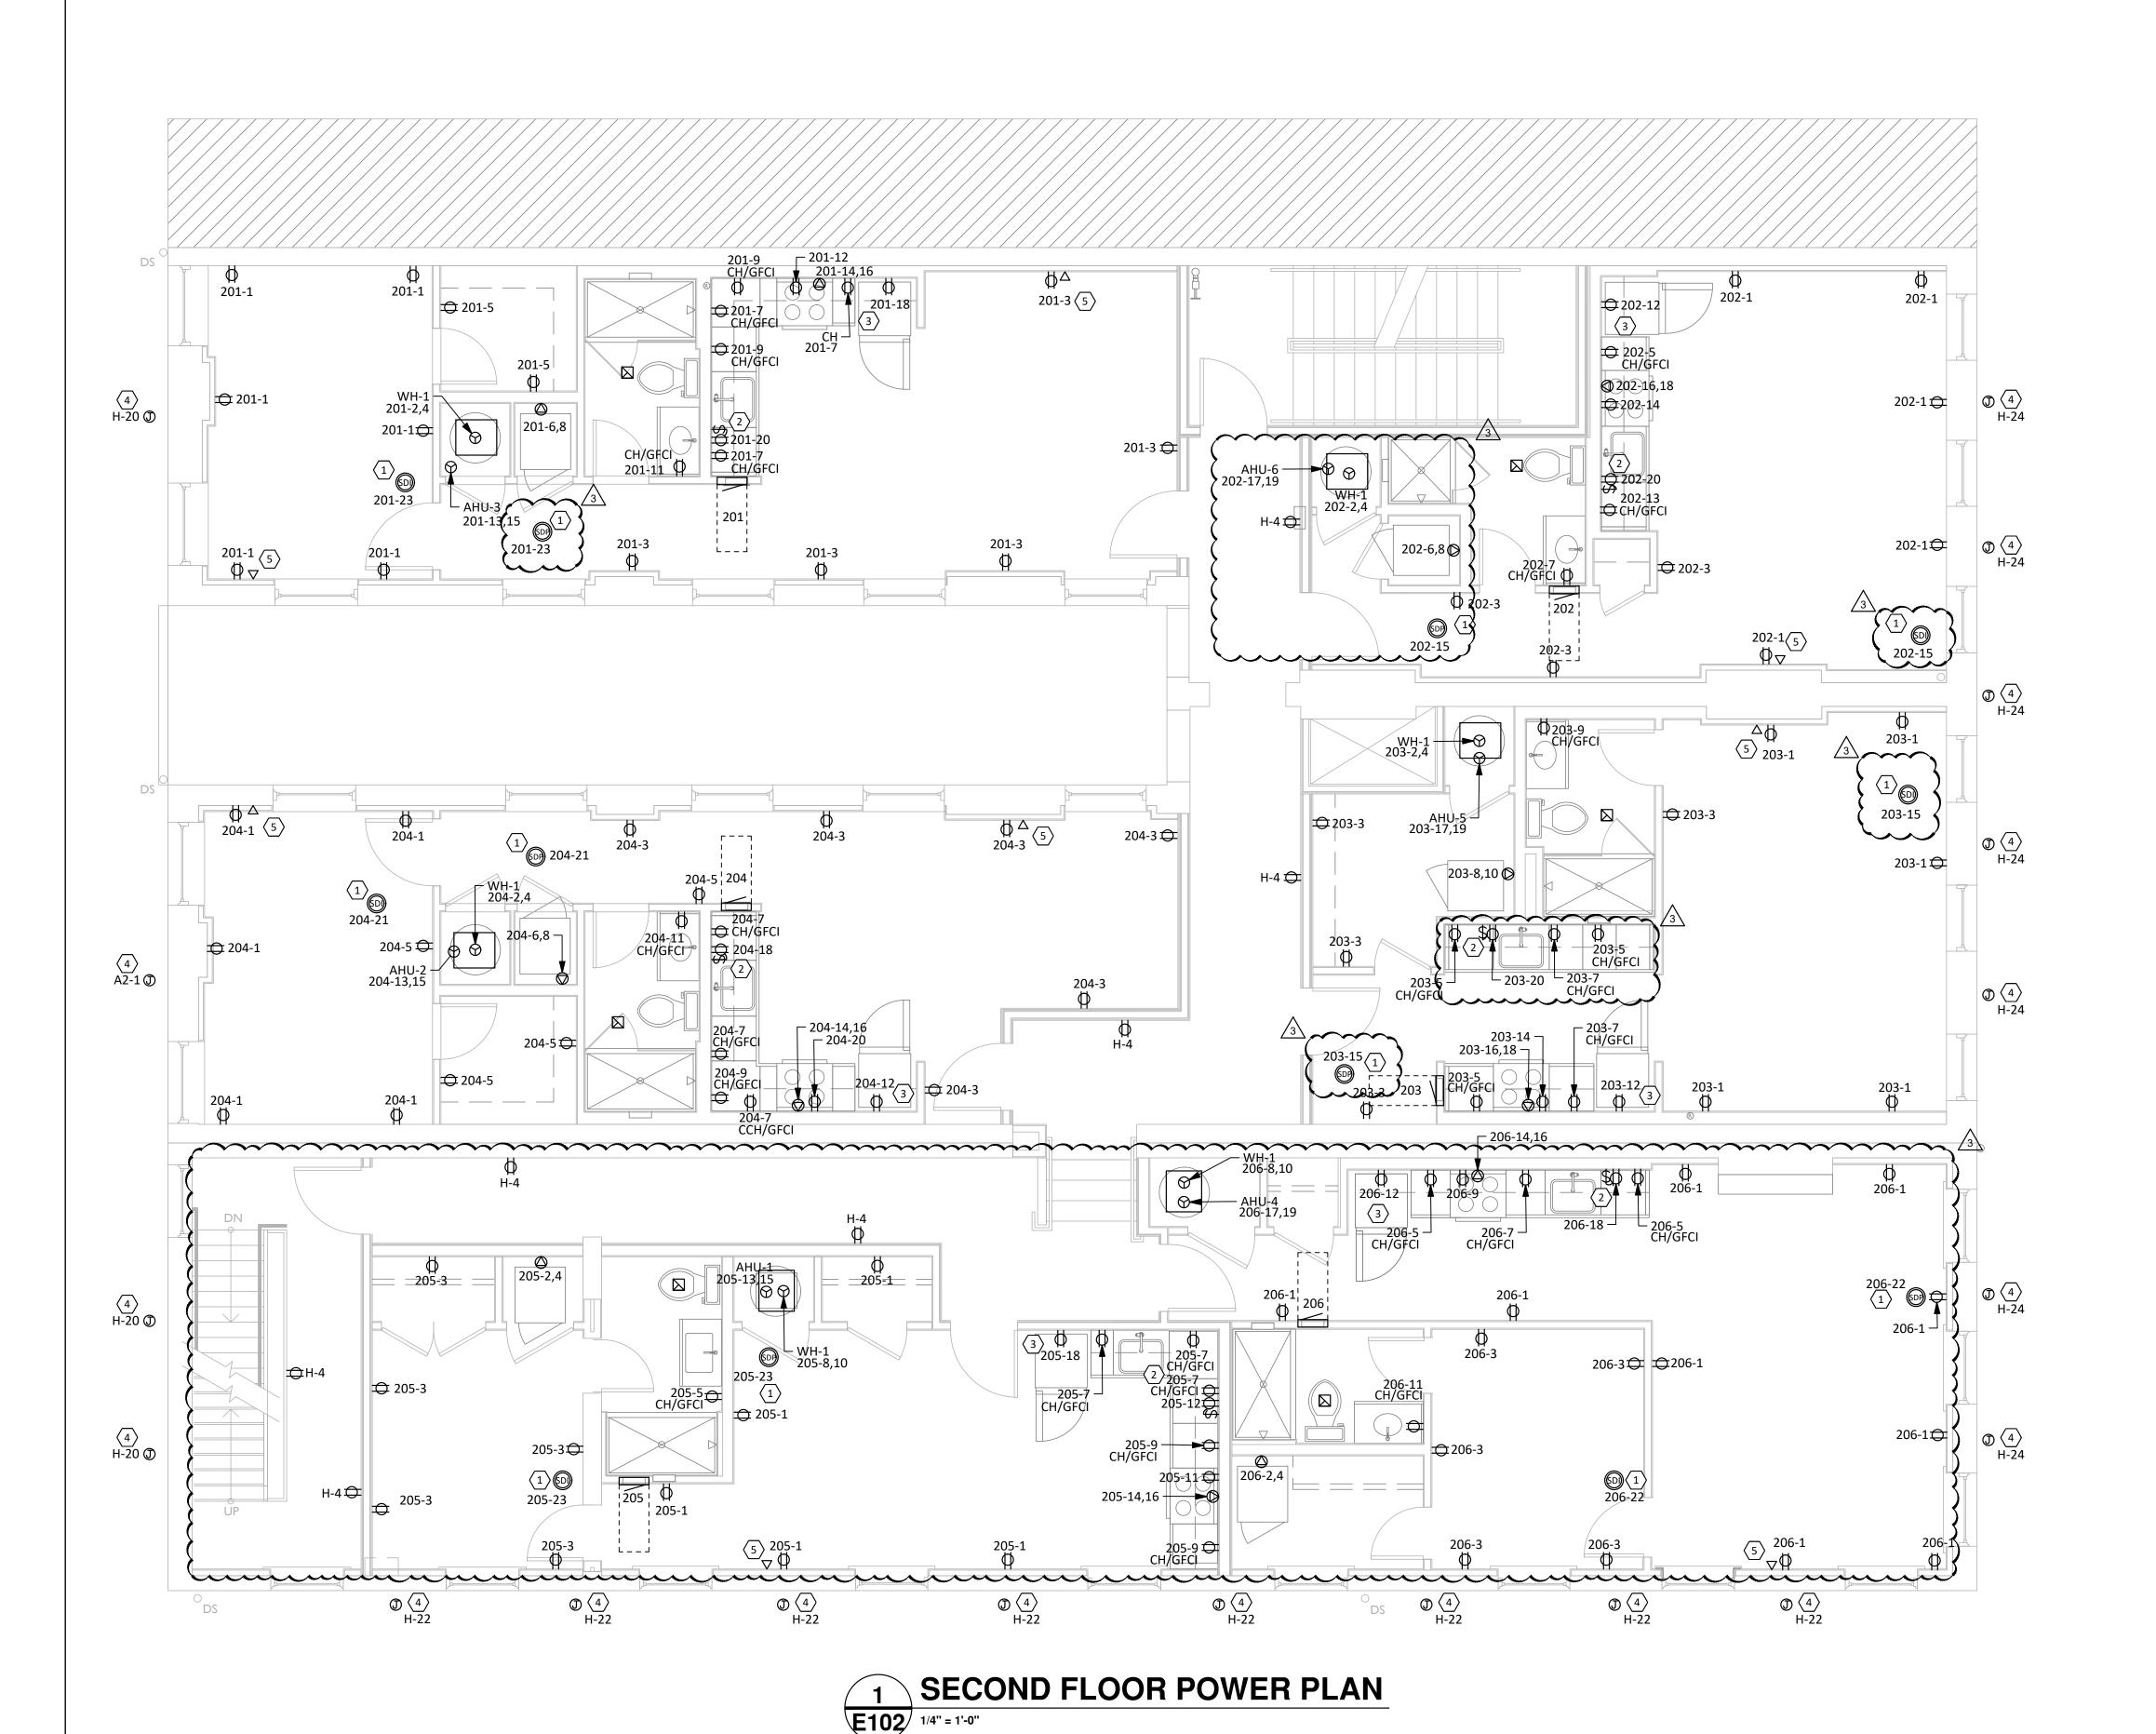
08.18.2023 - REVISION #3

Design Team:
MARQUE ENGINEERING
Drawn by:
MARQUE ENGINEERING

FLDER STREET

FINDL,

ob No: 11920 04.26.2



- A. ALL RECEPTACLES IN KITCHENS/BARS AND/OR WITHIN 6'-0" OF A WATER SOURCE MUST BE GFCI PROTECTED PER NEC. PROVIDE GFCI RECEPTACLES OR GFCI BREAKERS AS REQUIRED, REGARDLESS OF WHETHER OR NOT IT IS INDICATED ON PLANS.
- B. PROVIDE ALL SAW CUTTING AND PATCHING OF EXISTING FLOORS AND WALLS AS REQUIRED FOR INSTALLATION OF HIS WORK.
- C. UNLESS SPECIFICALLY NOTED OTHERWISE, ALL BRANCH CIRCUITS SHALL BE PROVIDED WITH (2)#12 (CU) THHN AND (1)#12 (CU) THHN GND IN 3/4" EMT CONDUIT FOR EACH 20 AMP CIRCUIT.
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- V. FOR ALL WASHERS/DRYERS WITHIN DWELLING UNITS, PROVIDE EITHER DIRECT OR CORD-AND-PLUG CONNECTIONS AS DETERMINED BY THE APPLIANCE(S) NAMEPLATE(S). AT WASHERS, PROVIDE A 120V 20A BRANCH CIRCUIT AND GFCI RECEPTACLE. AT DRYERS, PROVIDE A 30A/2P BRANCH CIRCUIT AND FLUSH 14-30A NEMA RECEPTACLE. NOTE WASHER/DRYER MAY BE EITHER DISPARATE APPLIANCES OR OF STACK-ABLE NATURE.
- W. FOR ALL ELECTRIC RANGES, OVENS, AND COOK-TOP WITHIN DWELLING UNITS; PROVIDE 50A FLUSH NEMA RECEPTACLE AND MATCHING 50A/2P CIRCUIT BREAKER AND WIRE. CONTRACTOR SHALL FIELD VERIFY PRIOR TO INSTALLATION WITH APPLIANCE PACKAGE. FOR ALL GAS RANGES, OVENS, AND COOK-TOP; PROVIDE 120V 20A BRANCH CIRCUIT AND RECEPTACLE.

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KEYED NOTES

- PROVIDE SMOKE DETECTOR WITH DIRECT ELECTRICAL CONNECTION AND INTEGRAL BATTERY BACKUP.
- 2. PROVIDE SWITCH FOR DISHWASHER MAINTENANCE BELOW COUNTER IN CABINET IN ACCESSIBLE AREA.
- 3. INTERNET DEMARC LOCATION IN CABINET ABOVE FRIDGE.
- 4. PROVIDE RECESSED JUNCTION BOX WITH PAINTED COVER TO MATCH HOST WALL. REFER TO ARCHITECTURAL EXTERIOR ELEVATIONS FOR MORE INFORMATION.
- 5. PROVIDE DATA JACK FOR T.V. ROUTE DATA CABLE TO DEMARC LOCATION WITHIN UNIT.

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Revisions

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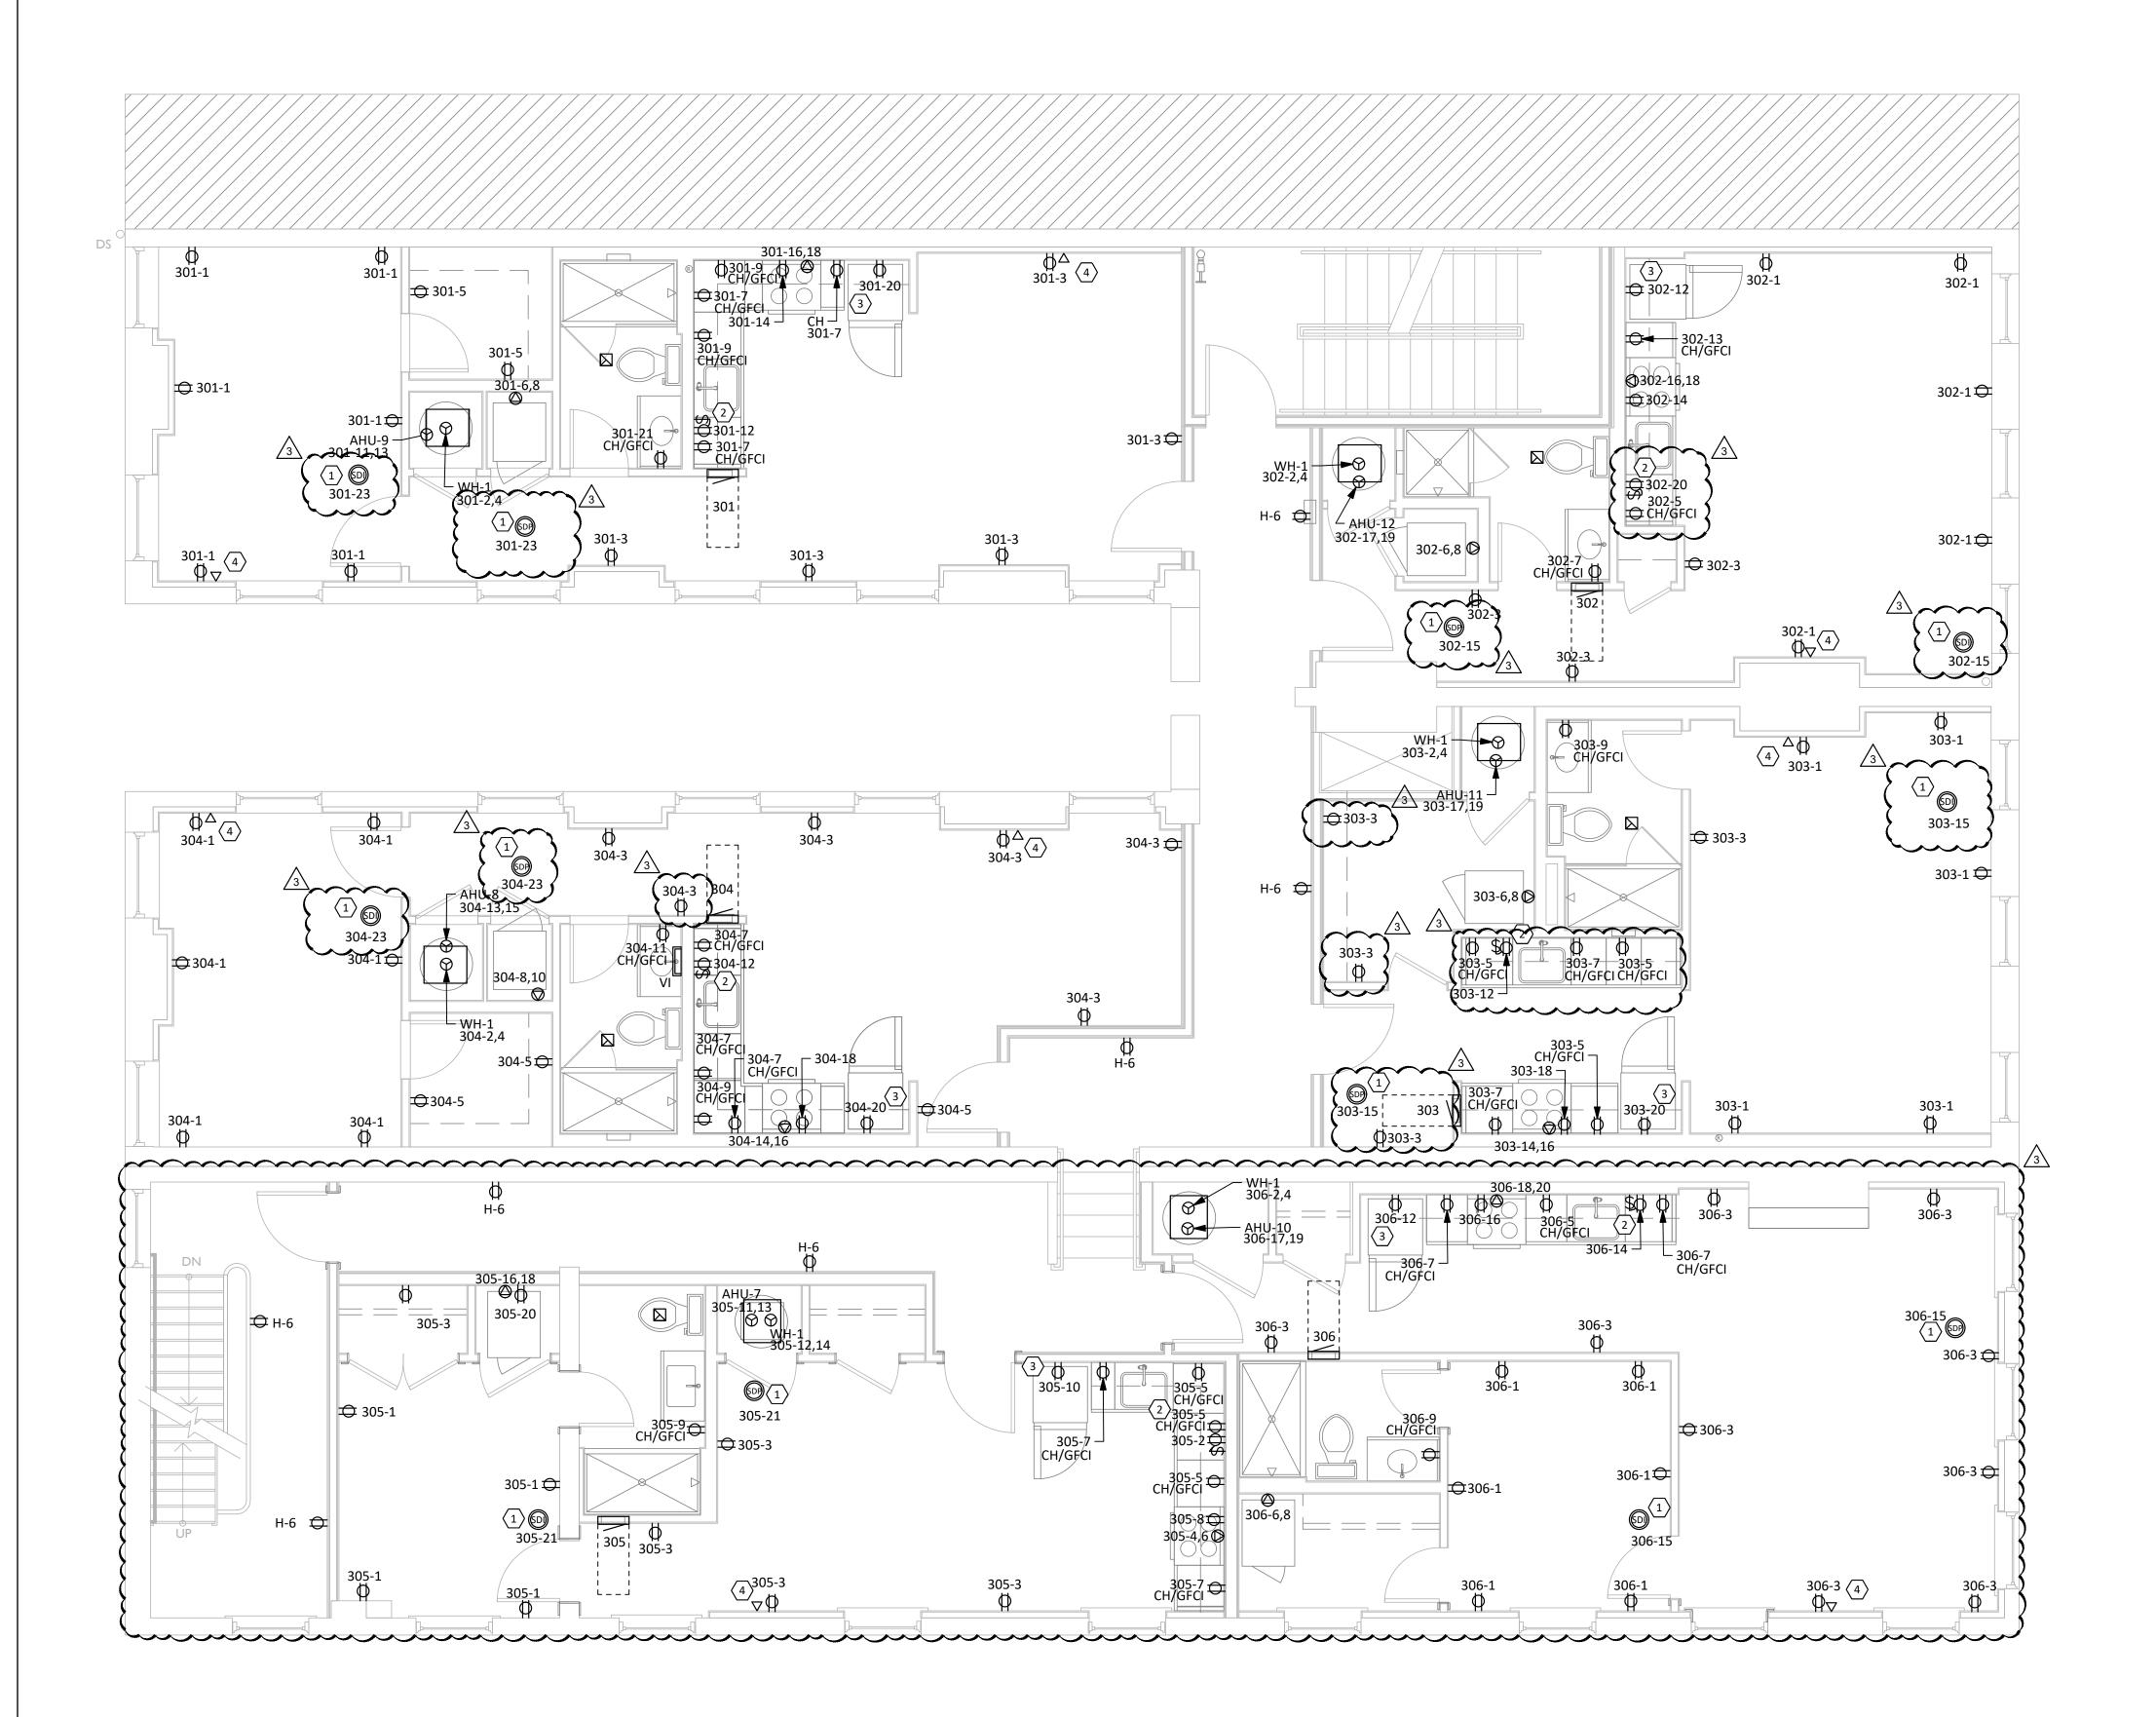
Design Team:
MARQUE ENGINEERING
Drawn by:

MARQUE ENGINEERING
Drawn by:
MARQUE ENGINEERING

HANGE

V. ELDER STREET
STREET

Job No: 11920 04.26.2022



THIRD FLOOR POWER PLAN

E103 1/4" = 1'-0"

GENERAL NOTES

- ALL RECEPTACLES IN KITCHENS/BARS AND/OR WITHIN 6'-0" OF A WATER SOURCE MUST BE GFCI PROTECTED PER NEC. PROVIDE GFCI RECEPTACLES OR GFCI BREAKERS AS REQUIRED, REGARDLESS OF WHETHER OR NOT IT IS INDICATED ON PLANS.
- PROVIDE ALL SAW CUTTING AND PATCHING OF EXISTING FLOORS AND WALLS AS REQUIRED FOR INSTALLATION OF HIS WORK.
- UNLESS SPECIFICALLY NOTED OTHERWISE, ALL BRANCH CIRCUITS SHALL BE PROVIDED WITH (2)#12 (CU) THHN AND (1)#12 (CU) THHN GND IN 3/4" EMT CONDUIT FOR EACH 20 AMP CIRCUIT.
- ALL WORK SHOWN IS NEW, UNLESS OTHERWISE NOTED.
- ANY PENETRATIONS THROUGH FIRE-RESISTANT/RATED WALLS, PARTITIONS, FLOORS, AND CEILINGS SHALL BE FIRESTOPPED USING APPROVED METHODS TO MAINTAIN THE FIRE RESISTANCE RATING. REFER TO ELECTRICAL SPECIFICATIONS FOR ELECTRICAL DEVICE TYPES AND RATINGS.
- ALL CONDUITS SHALL BE CONCEALED IN WALLS AND OUTLET BOXES SHALL BE FLUSH WITH FINISHED WALL UNLESS OTHERWISE NOTED.
- RECEPTACLES TO BE MOUNTED AT 1'-6" ABOVE FINISHED FLOOR TO CENTER OF RECEPTACLE UNLESS NOTED OTHERWISE.
- PROVIDE JUNCTION BOX AND RACEWAY FOR THERMOSTATS AND HVAC LOW VOLTAGE CONTROLS AT 48" A.F.F. THERMOSTATS AND HVAC LOW VOLTAGE CONTROLS INSTALLED AND WIRED BY M.C.. COORDINATE EXACT LOCATIONS WITH M.C.. TYPICAL OF ALL.
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KEYED NOTES

- PROVIDE SMOKE DETECTOR WITH DIRECT ELECTRICAL CONNECTION AND INTEGRAL BATTERY BACKUP.
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PROVIDE DATA JACK FOR T.V. ROUTE DATA CABLE TO DEMARC LOCATION WITHIN UNIT.

OH COA #4715

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Design Team: MARQUE ENGINEERING


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E104 1/4" = 1'-0"

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- PROVIDE JUNCTION BOX AND RACEWAY FOR THERMOSTATS AND HVAC LOW VOLTAGE CONTROLS AT 48" A.F.F. THERMOSTATS AND HVAC LOW VOLTAGE CONTROLS INSTALLED AND WIRED BY M.C.. COORDINATE EXACT LOCATIONS WITH M.C.. TYPICAL OF ALL.
- REFER TO ARCHITECTURAL DRAWINGS FOR DEVICE COLORS AND PART NUMBERS. IN THE CASE OF A CONFLICT BETWEEN LOCATIONS ON THE ELECTRICAL DRAWINGS AND LOCATIONS ON THE ARCHITECTURAL DRAWINGS, THE ARCHITECTURAL DRAWINGS SHALL TAKE PRIORITY.
- ALL RECEPTACLES MOUNTED ON EXPOSED BRICK/MASONRY WALLS SHALL HAVE SURFACE MOUNT CONDUIT RUN FROM BELOW.
- REFER TO SPECIFICATIONS FOR WIRE SIZING.
- ALL WORK SHALL BE PERFORMED IN STRICT CONFORMANCE TO THE LATEST NATIONAL ELECTRIC CODE (NEC) AND BY TRAINED AND LICENSED ELECTRICIANS.
- LIST OF EQUIPMENT, TABULATIONS OF DATA, SCHEDULES, ETC. APPEARING IN THE SPECIFICATIONS OR ON THE DRAWINGS ARE INCLUDED FOR REFERENCE BY THE CONTRACTOR IN ARRIVING AT A MORE COMPLETE UNDERSTANDING OF THE INTENDED INSTALLATION. THEY ARE NOT INTENDED TO BE CONSTRUED AS RELIEVING THE RESPONSIBILITY OF THE CONTRACTOR IN MAKING HIS/HER OWN TAKE-OFF AND PROVIDING ALL REQUIRED WORK.
- COORDINATE EXACT LOCATIONS OF EQUIPMENT WITH CONTRACTOR FURNISHING SUCH. COORDINATE EXACT ELECTRICAL WIRING AND CONNECTION REQUIREMENTS WITH SUBMITTAL DRAWINGS PRIOR TO ROUGH-IN. ALL WIRING REQUIREMENTS SHOWN ARE SCHEMATIC IN NATURE.
- O.A. COORDINATE ALL HVAC AND PLUMBING EQUIPMENT OVER-CURRENT PROTECTIVE DEVICES WITH RESPECTIVE DIVISIONAL PRODUCT DATA SUBMITTALS AND INSTALLING CONTRACTOR PRIOR TO FURNISHING SAID OVER-CURRENT PROTECTIVE DEVICES.
- O.B. COORDINATE SPECIALTY RECEPTACLE AND/OR OUTLET TYPES WITH EQUIPMENT REQUIREMENTS. O.C. WHEN LOOSE DISCONNECT SWITCHES ARE FURNISHED UNDER MECHANICAL CONTRACT, RECEIVE AND
- INSTALL AND PROVIDE ALL FINAL TERMINATIONS NECESSARY. ALL DEVICES SHOWN ON EXTERIOR OF THE BUILDING SHALL BE WEATHER PROOF TYPE.
- REFER TO ALL OTHER CONSTRUCTION TRADES' DRAWINGS AND SPECIFICATIONS FOR ADDITIONAL ELECTRICAL WORK THAT IS INCLUDED IN DIVISION 26'S SCOPE
- IN ADA UNITS, MOUNTING HEIGHT FOR BRANCH CIRCUIT BREAKER(S) SHALL NOT BE GREATER THAN 48"
- SMOKE DETECTORS SHALL BE INTERCONNECTED IN SUCH A MANNER THAT ACTIVATION OF ONE ALARM WILL ACTIVATE ALL ALARMS IN INDIVIDUAL UNITS.
- ALL RECEPTACLES WITHIN DWELLING UNITS SHALL BE TAMPER PROOF TYPE.
- ALL 120-VOLT, SINGLE PHASE 15 AND 20 AMP BRANCH CIRCUITS SUPPLYING OUTLETS OR DEVICES IN DWELLING UNITS SHALL HAVE AFCI PROTECTION. AFCI PROTECTION MAY BE ACHIEVED BY ANY APPROVED METHOD DETAILED IN NFPA 70, SECTION 201.12 (A).
- FOR ALL WASHERS/DRYERS WITHIN DWELLING UNITS, PROVIDE EITHER DIRECT OR CORD-AND-PLUG CONNECTIONS AS DETERMINED BY THE APPLIANCE(S) NAMEPLATE(S). AT WASHERS, PROVIDE A 120V 20A BRANCH CIRCUIT AND GFCI RECEPTACLE. AT DRYERS, PROVIDE A 30A/2P BRANCH CIRCUIT AND FLUSH 14-30A NEMA RECEPTACLE. NOTE WASHER/DRYER MAY BE EITHER DISPARATE APPLIANCES OR OF STACK-ABLE NATURE.
- FOR ALL ELECTRIC RANGES, OVENS, AND COOK-TOP WITHIN DWELLING UNITS; PROVIDE 50A FLUSH NEMA RECEPTACLE AND MATCHING 50A/2P CIRCUIT BREAKER AND WIRE. CONTRACTOR SHALL FIELD VERIFY PRIOR TO INSTALLATION WITH APPLIANCE PACKAGE. FOR ALL GAS RANGES, OVENS, AND COOK-TOP; PROVIDE 120V 20A BRANCH CIRCUIT AND RECEPTACLE.

KEYED NOTES

- PROVIDE SMOKE DETECTOR WITH DIRECT ELECTRICAL CONNECTION AND INTEGRAL BATTERY BACKUP.
- PROVIDE SWITCH FOR DISHWASHER MAINTENANCE BELOW COUNTER IN CABINET IN ACCESSIBLE AREA.
- INTERNET DEMARC LOCATION IN CABINET ABOVE FRIDGE.
- PROVIDE DATA JACK FOR T.V. ROUTE DATA CABLE TO DEMARC LOCATION WITHIN UNIT. PROVIDE 120V CIRCUIT IN JUNCTION BOX FOR FUTURE CONNECTION TO RADON FAN.

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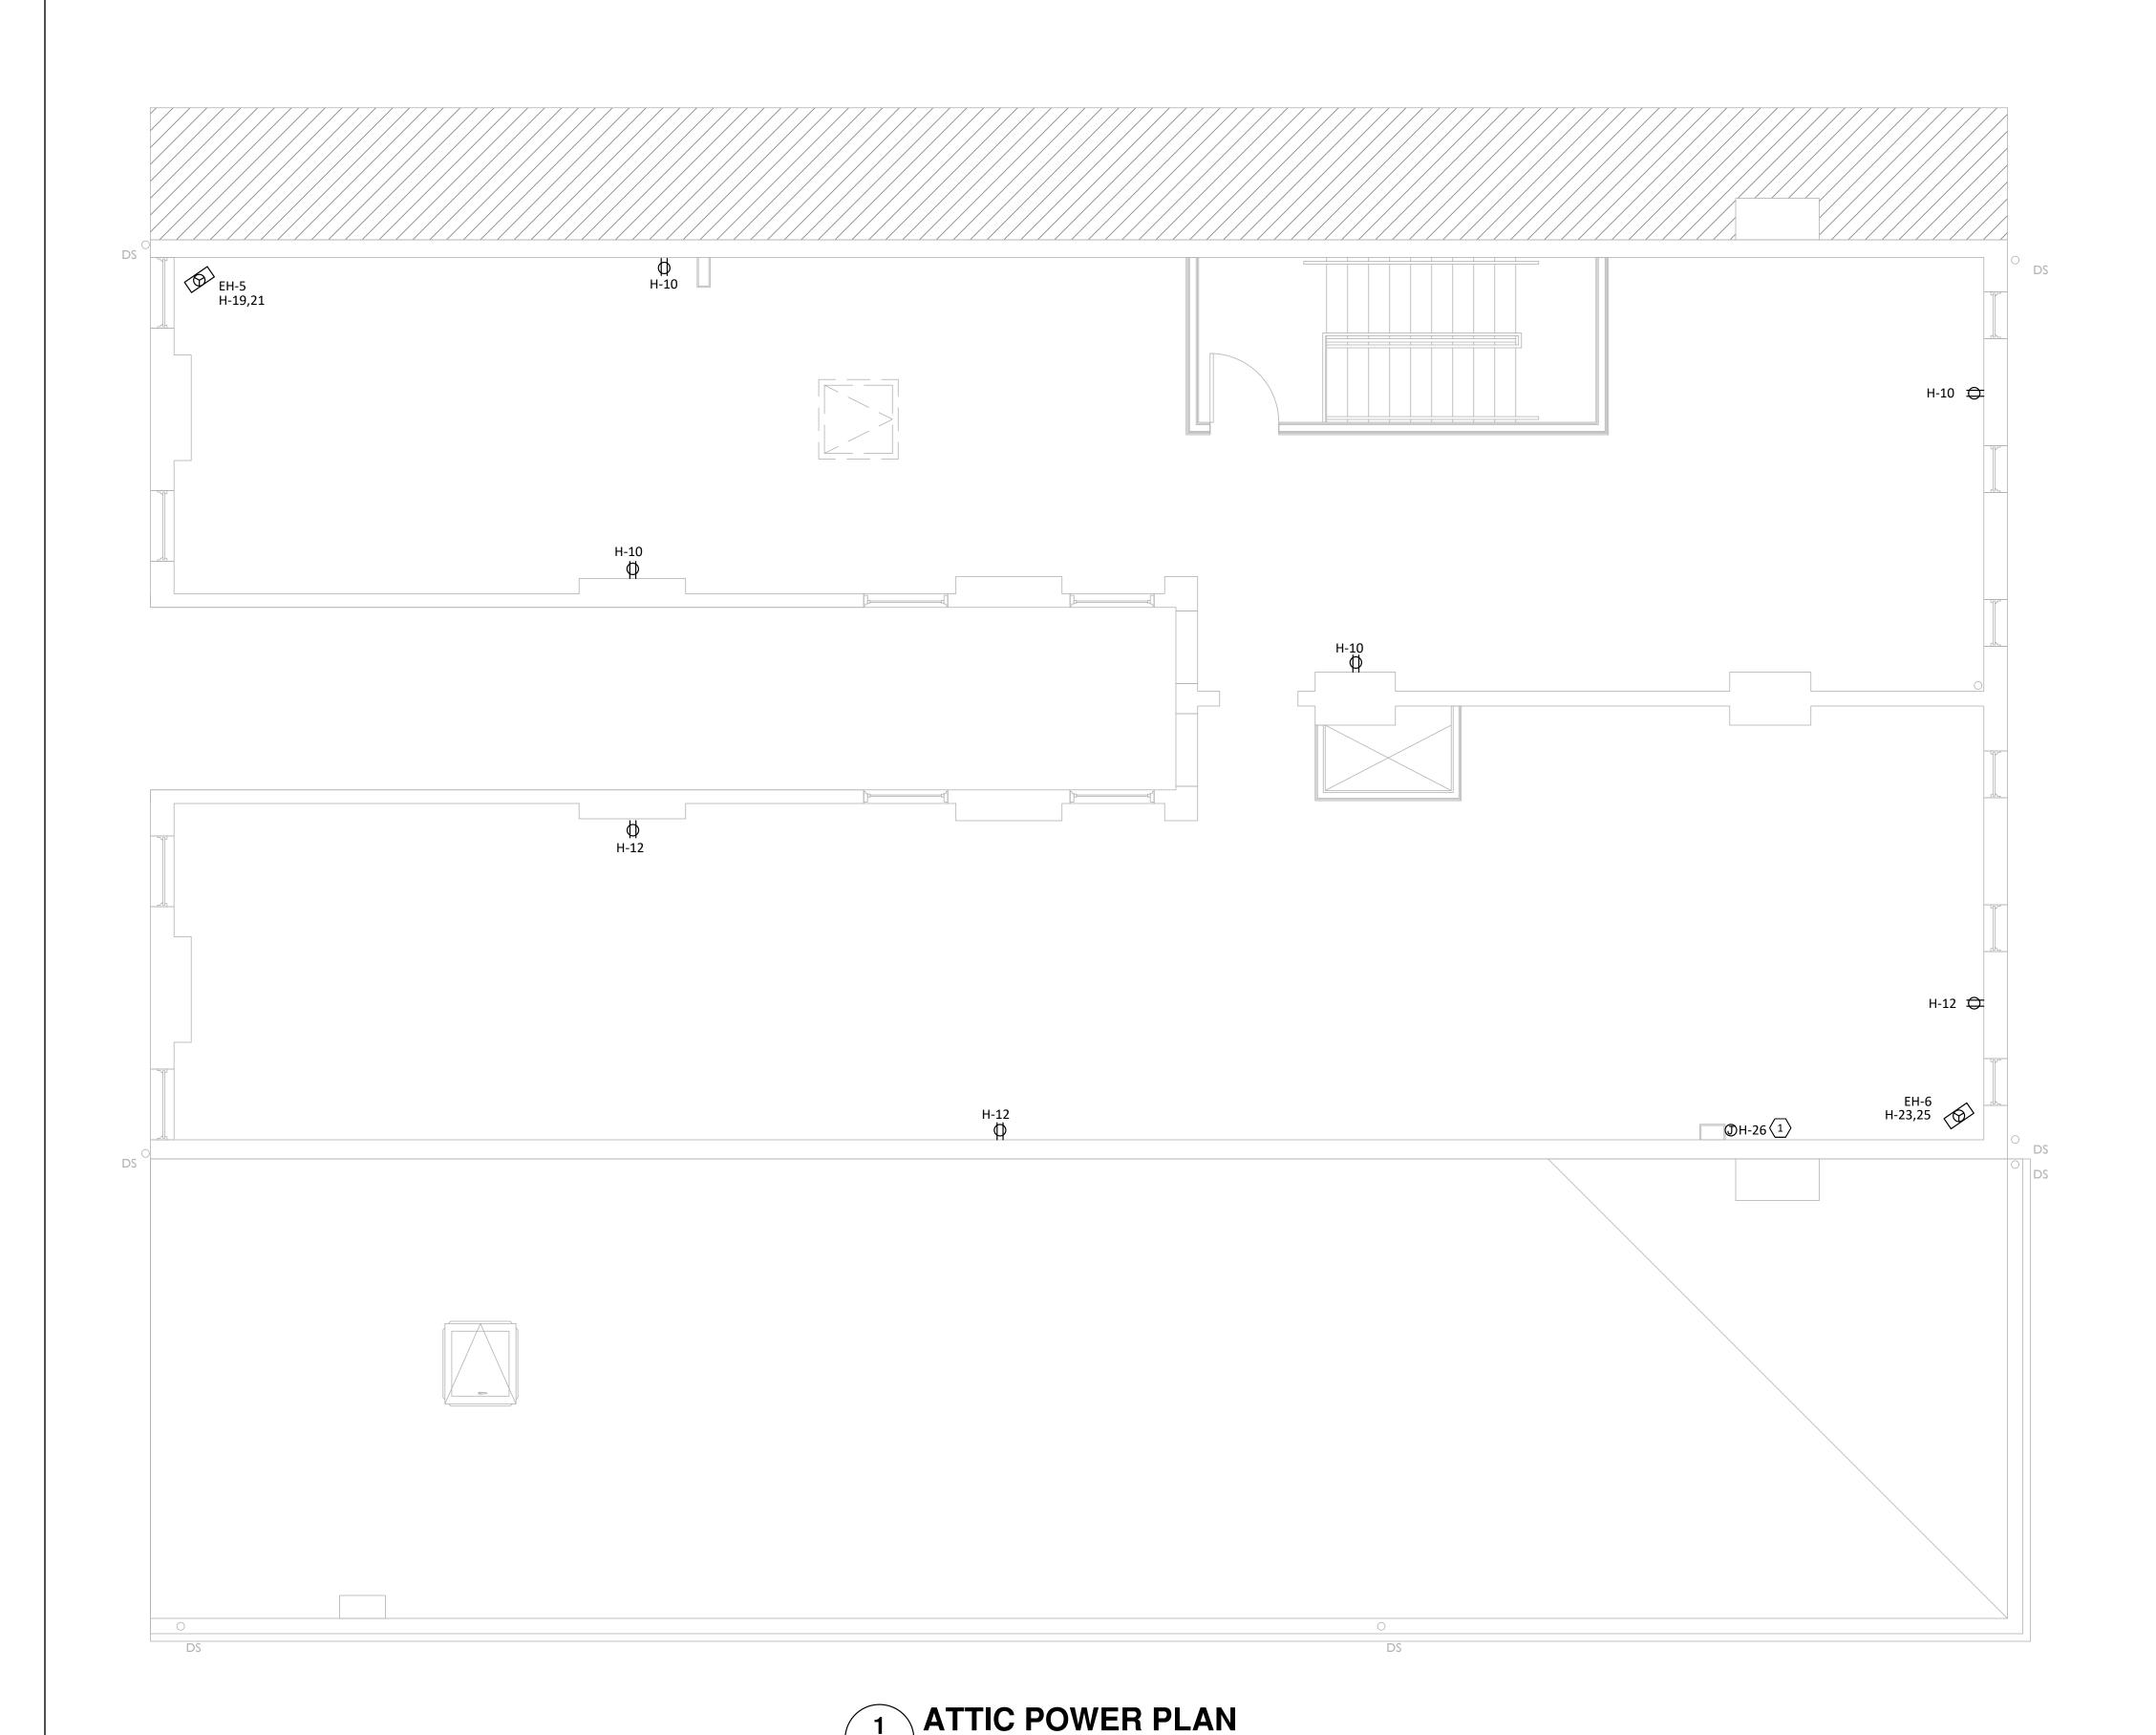
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E105 1/4" = 1'-0"

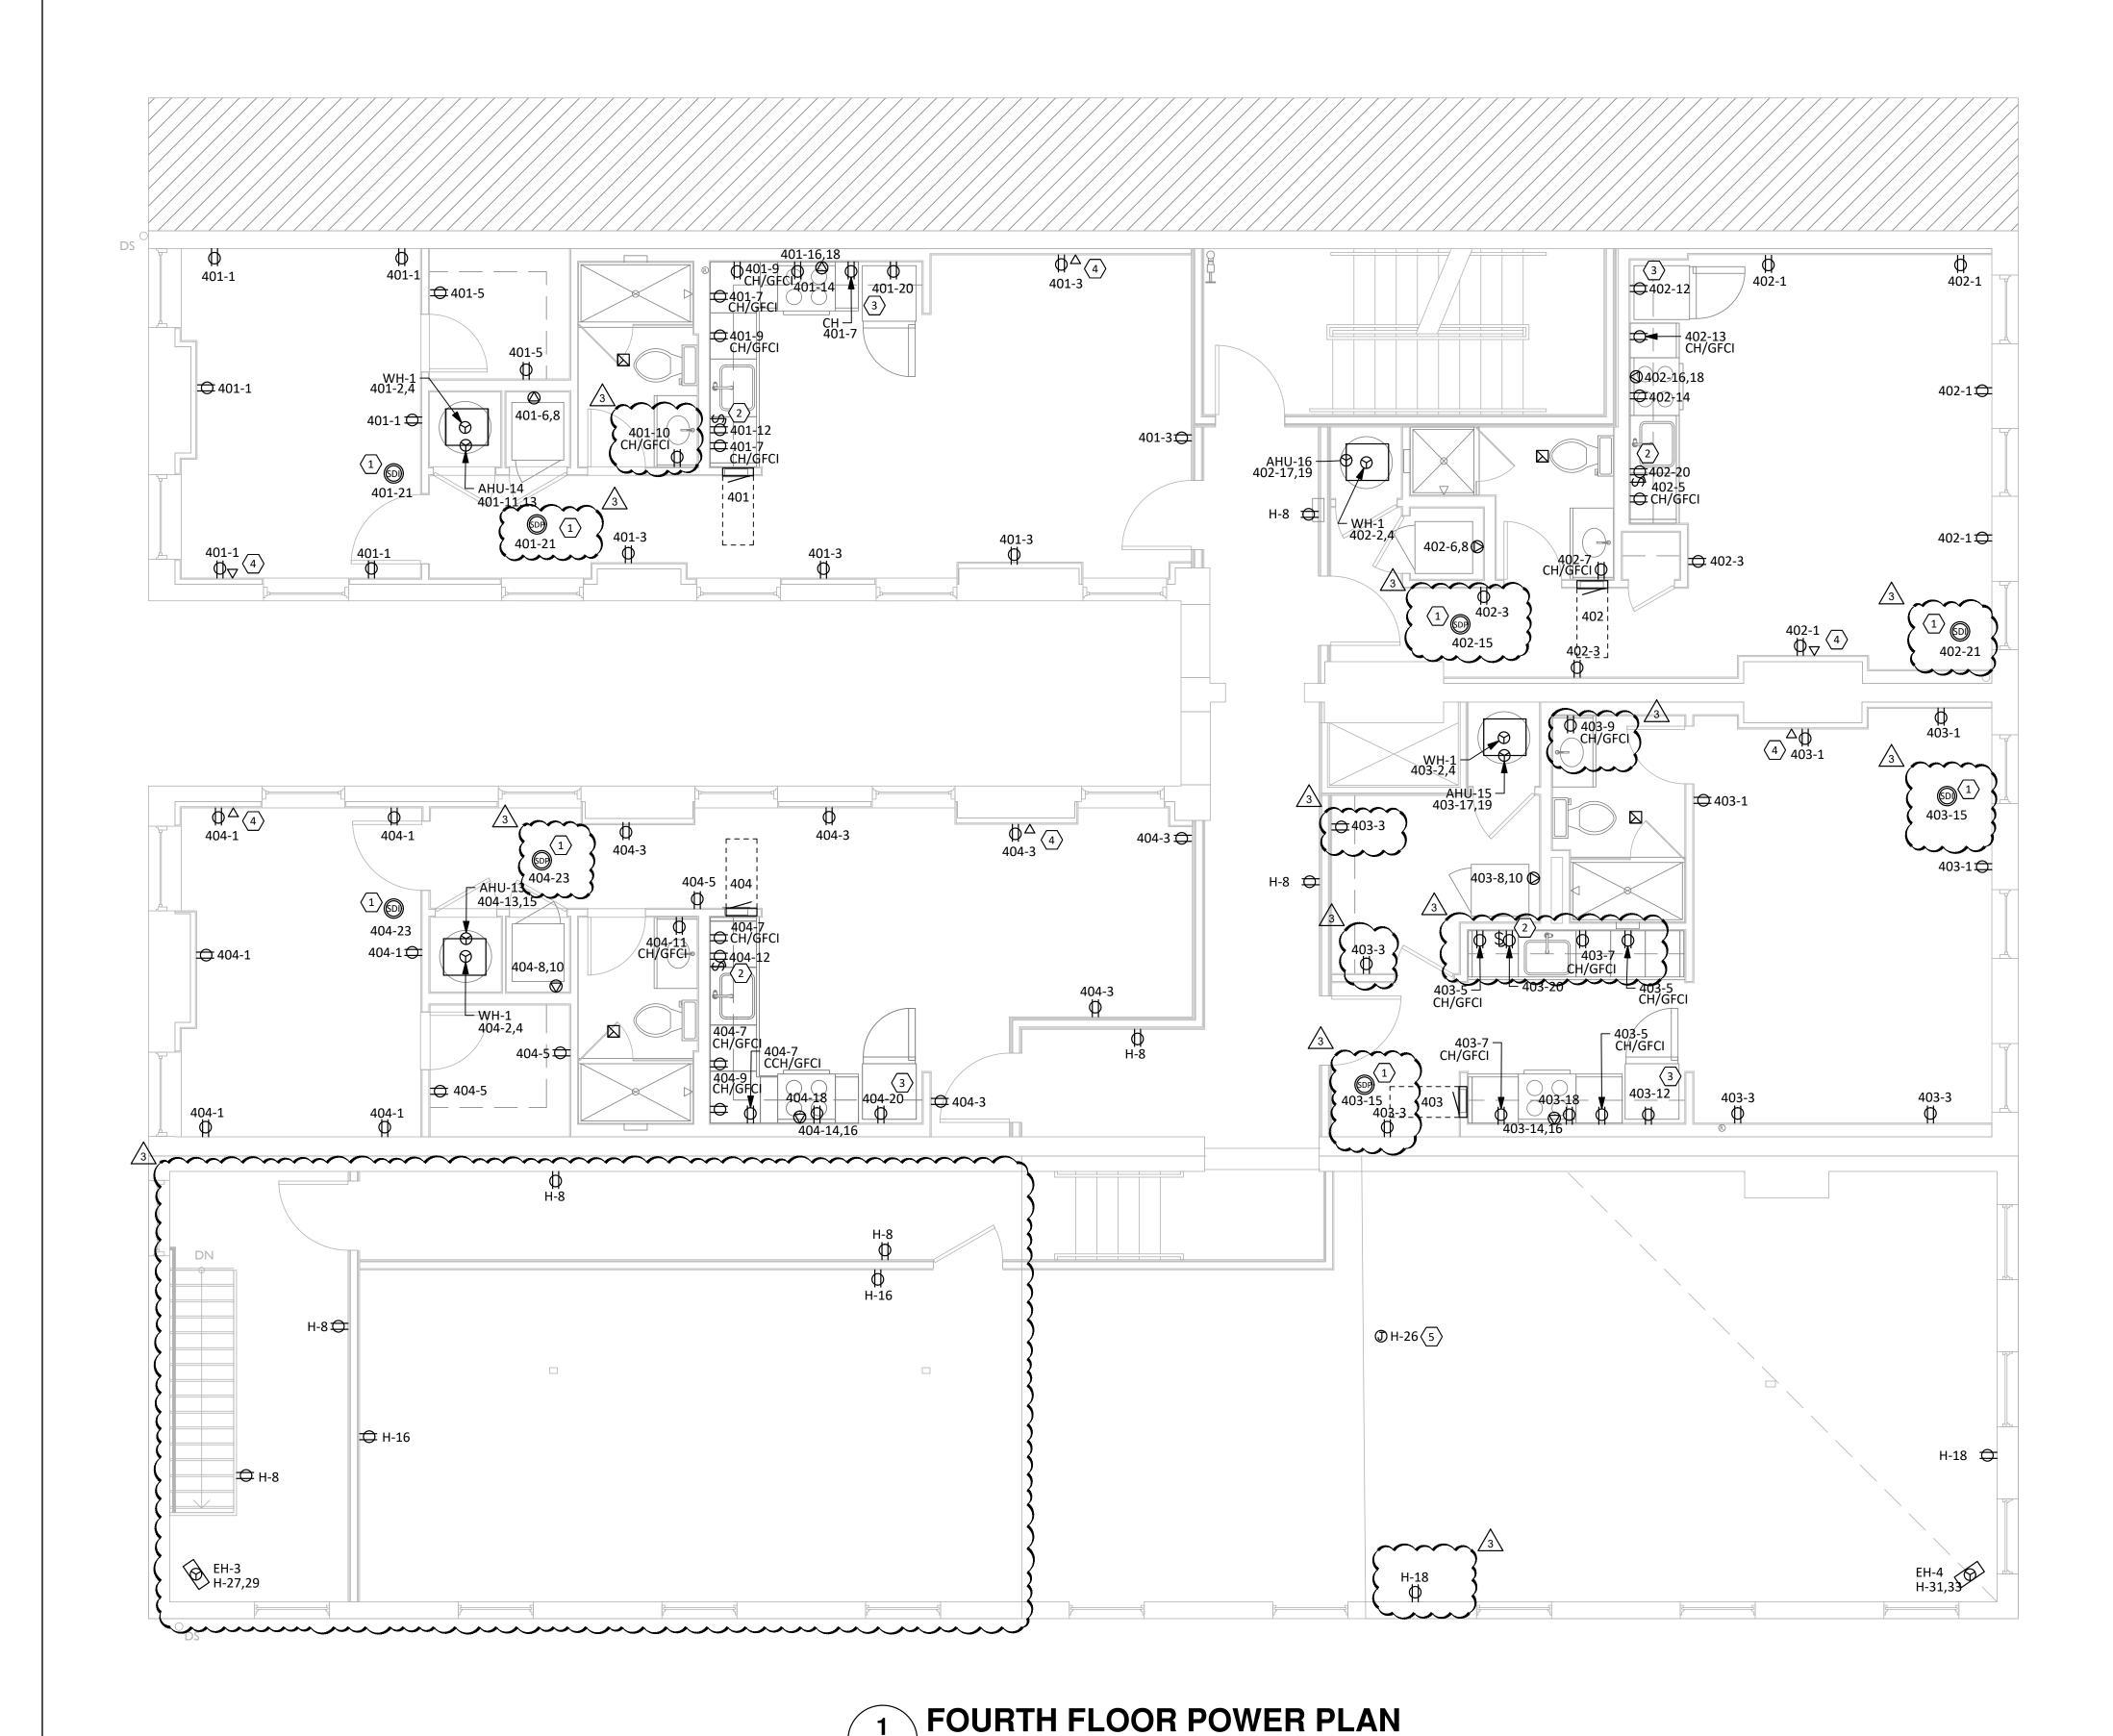GENERAL NOTES

- ALL RECEPTACLES IN KITCHENS/BARS AND/OR WITHIN 6'-0" OF A WATER SOURCE MUST BE GFCI PROTECTED PER NEC. PROVIDE GFCI RECEPTACLES OR GFCI BREAKERS AS REQUIRED, REGARDLESS OF WHETHER OR NOT IT IS INDICATED ON PLANS.
- PROVIDE ALL SAW CUTTING AND PATCHING OF EXISTING FLOORS AND WALLS AS REQUIRED FOR INSTALLATION OF HIS WORK.
- UNLESS SPECIFICALLY NOTED OTHERWISE, ALL BRANCH CIRCUITS SHALL BE PROVIDED WITH (2)#12 (CU) THHN AND (1)#12 (CU) THHN GND IN 3/4" EMT CONDUIT FOR EACH 20 AMP CIRCUIT.
- ALL WORK SHOWN IS NEW, UNLESS OTHERWISE NOTED.
- ANY PENETRATIONS THROUGH FIRE-RESISTANT/RATED WALLS, PARTITIONS, FLOORS, AND CEILINGS SHALL BE FIRESTOPPED USING APPROVED METHODS TO MAINTAIN THE FIRE RESISTANCE RATING. REFER TO ELECTRICAL SPECIFICATIONS FOR ELECTRICAL DEVICE TYPES AND RATINGS.
- ALL CONDUITS SHALL BE CONCEALED IN WALLS AND OUTLET BOXES SHALL BE FLUSH WITH FINISHED WALL UNLESS OTHERWISE NOTED.
- RECEPTACLES TO BE MOUNTED AT 1'-6" ABOVE FINISHED FLOOR TO CENTER OF RECEPTACLE UNLESS NOTED OTHERWISE.
- PROVIDE JUNCTION BOX AND RACEWAY FOR THERMOSTATS AND HVAC LOW VOLTAGE CONTROLS AT 48" A.F.F. THERMOSTATS AND HVAC LOW VOLTAGE CONTROLS INSTALLED AND WIRED BY M.C.. COORDINATE EXACT LOCATIONS WITH M.C.. TYPICAL OF ALL.
- REFER TO ARCHITECTURAL DRAWINGS FOR DEVICE COLORS AND PART NUMBERS. IN THE CASE OF A CONFLICT BETWEEN LOCATIONS ON THE ELECTRICAL DRAWINGS AND LOCATIONS ON THE ARCHITECTURAL DRAWINGS, THE ARCHITECTURAL DRAWINGS SHALL TAKE PRIORITY.
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- FOR ALL ELECTRIC RANGES, OVENS, AND COOK-TOP WITHIN DWELLING UNITS; PROVIDE 50A FLUSH NEMA RECEPTACLE AND MATCHING 50A/2P CIRCUIT BREAKER AND WIRE. CONTRACTOR SHALL FIELD VERIFY PRIOR TO INSTALLATION WITH APPLIANCE PACKAGE. FOR ALL GAS RANGES, OVENS, AND COOK-TOP; PROVIDE 120V 20A BRANCH CIRCUIT AND RECEPTACLE.



KEYED NOTES

PROVIDE 120V CIRCUIT IN JUNCTION BOX FOR FUTURE CONNECTION TO RADON FAN.

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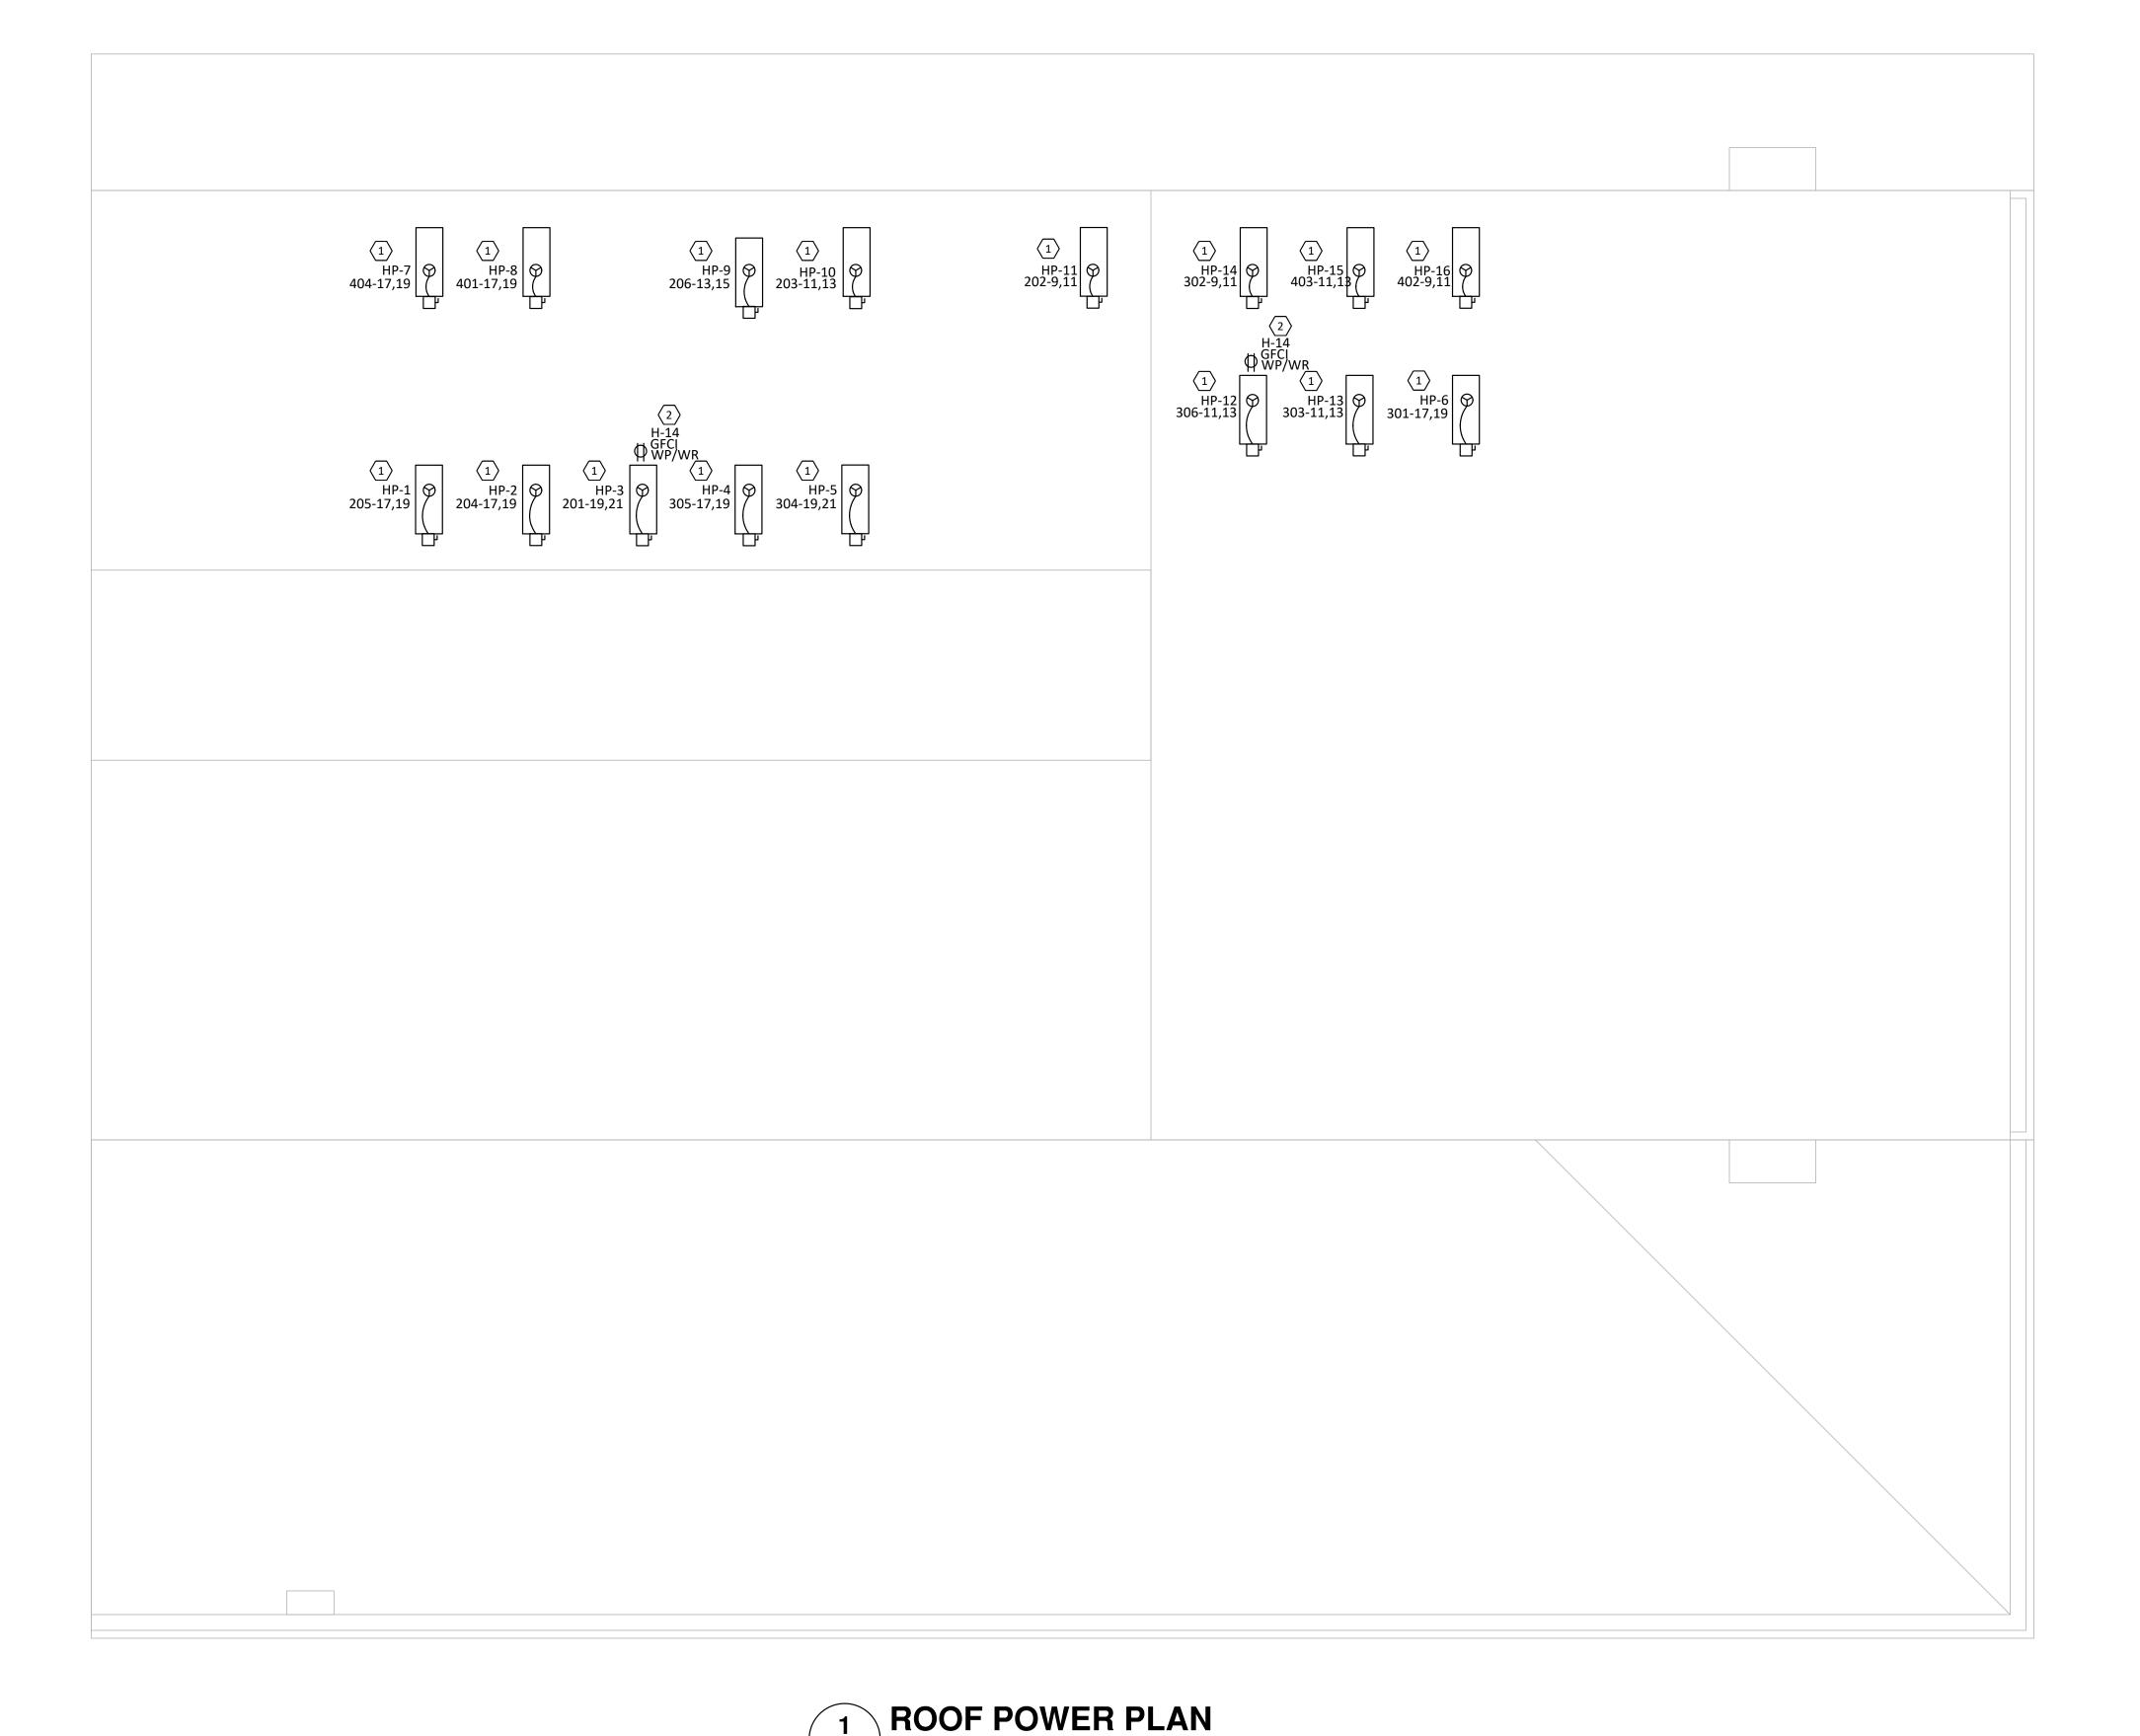
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Design Team:
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- ALL RECEPTACLES IN KITCHENS/BARS AND/OR WITHIN 6'-0" OF A WATER SOURCE MUST BE GFCI PROTECTED PER NEC. PROVIDE GFCI RECEPTACLES OR GFCI BREAKERS AS REQUIRED, REGARDLESS OF WHETHER OR NOT IT IS INDICATED ON PLANS.
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KEYED NOTES

- PROVIDE 30A/3P/NF 208V NEMA-3R DISCONNECT SWITCH AND FINAL CONNECTION TO MECHANICAL EQUIPMENT. REFER TO PANELBOARD SCHEDULES AND MECHANICAL DRAWINGS FOR ADDITIONAL
- PROVIDE 120V GFCI WP/WR SERVICE RECEPTACLE FOR ROOFTOP HVAC EQUIPMENT.

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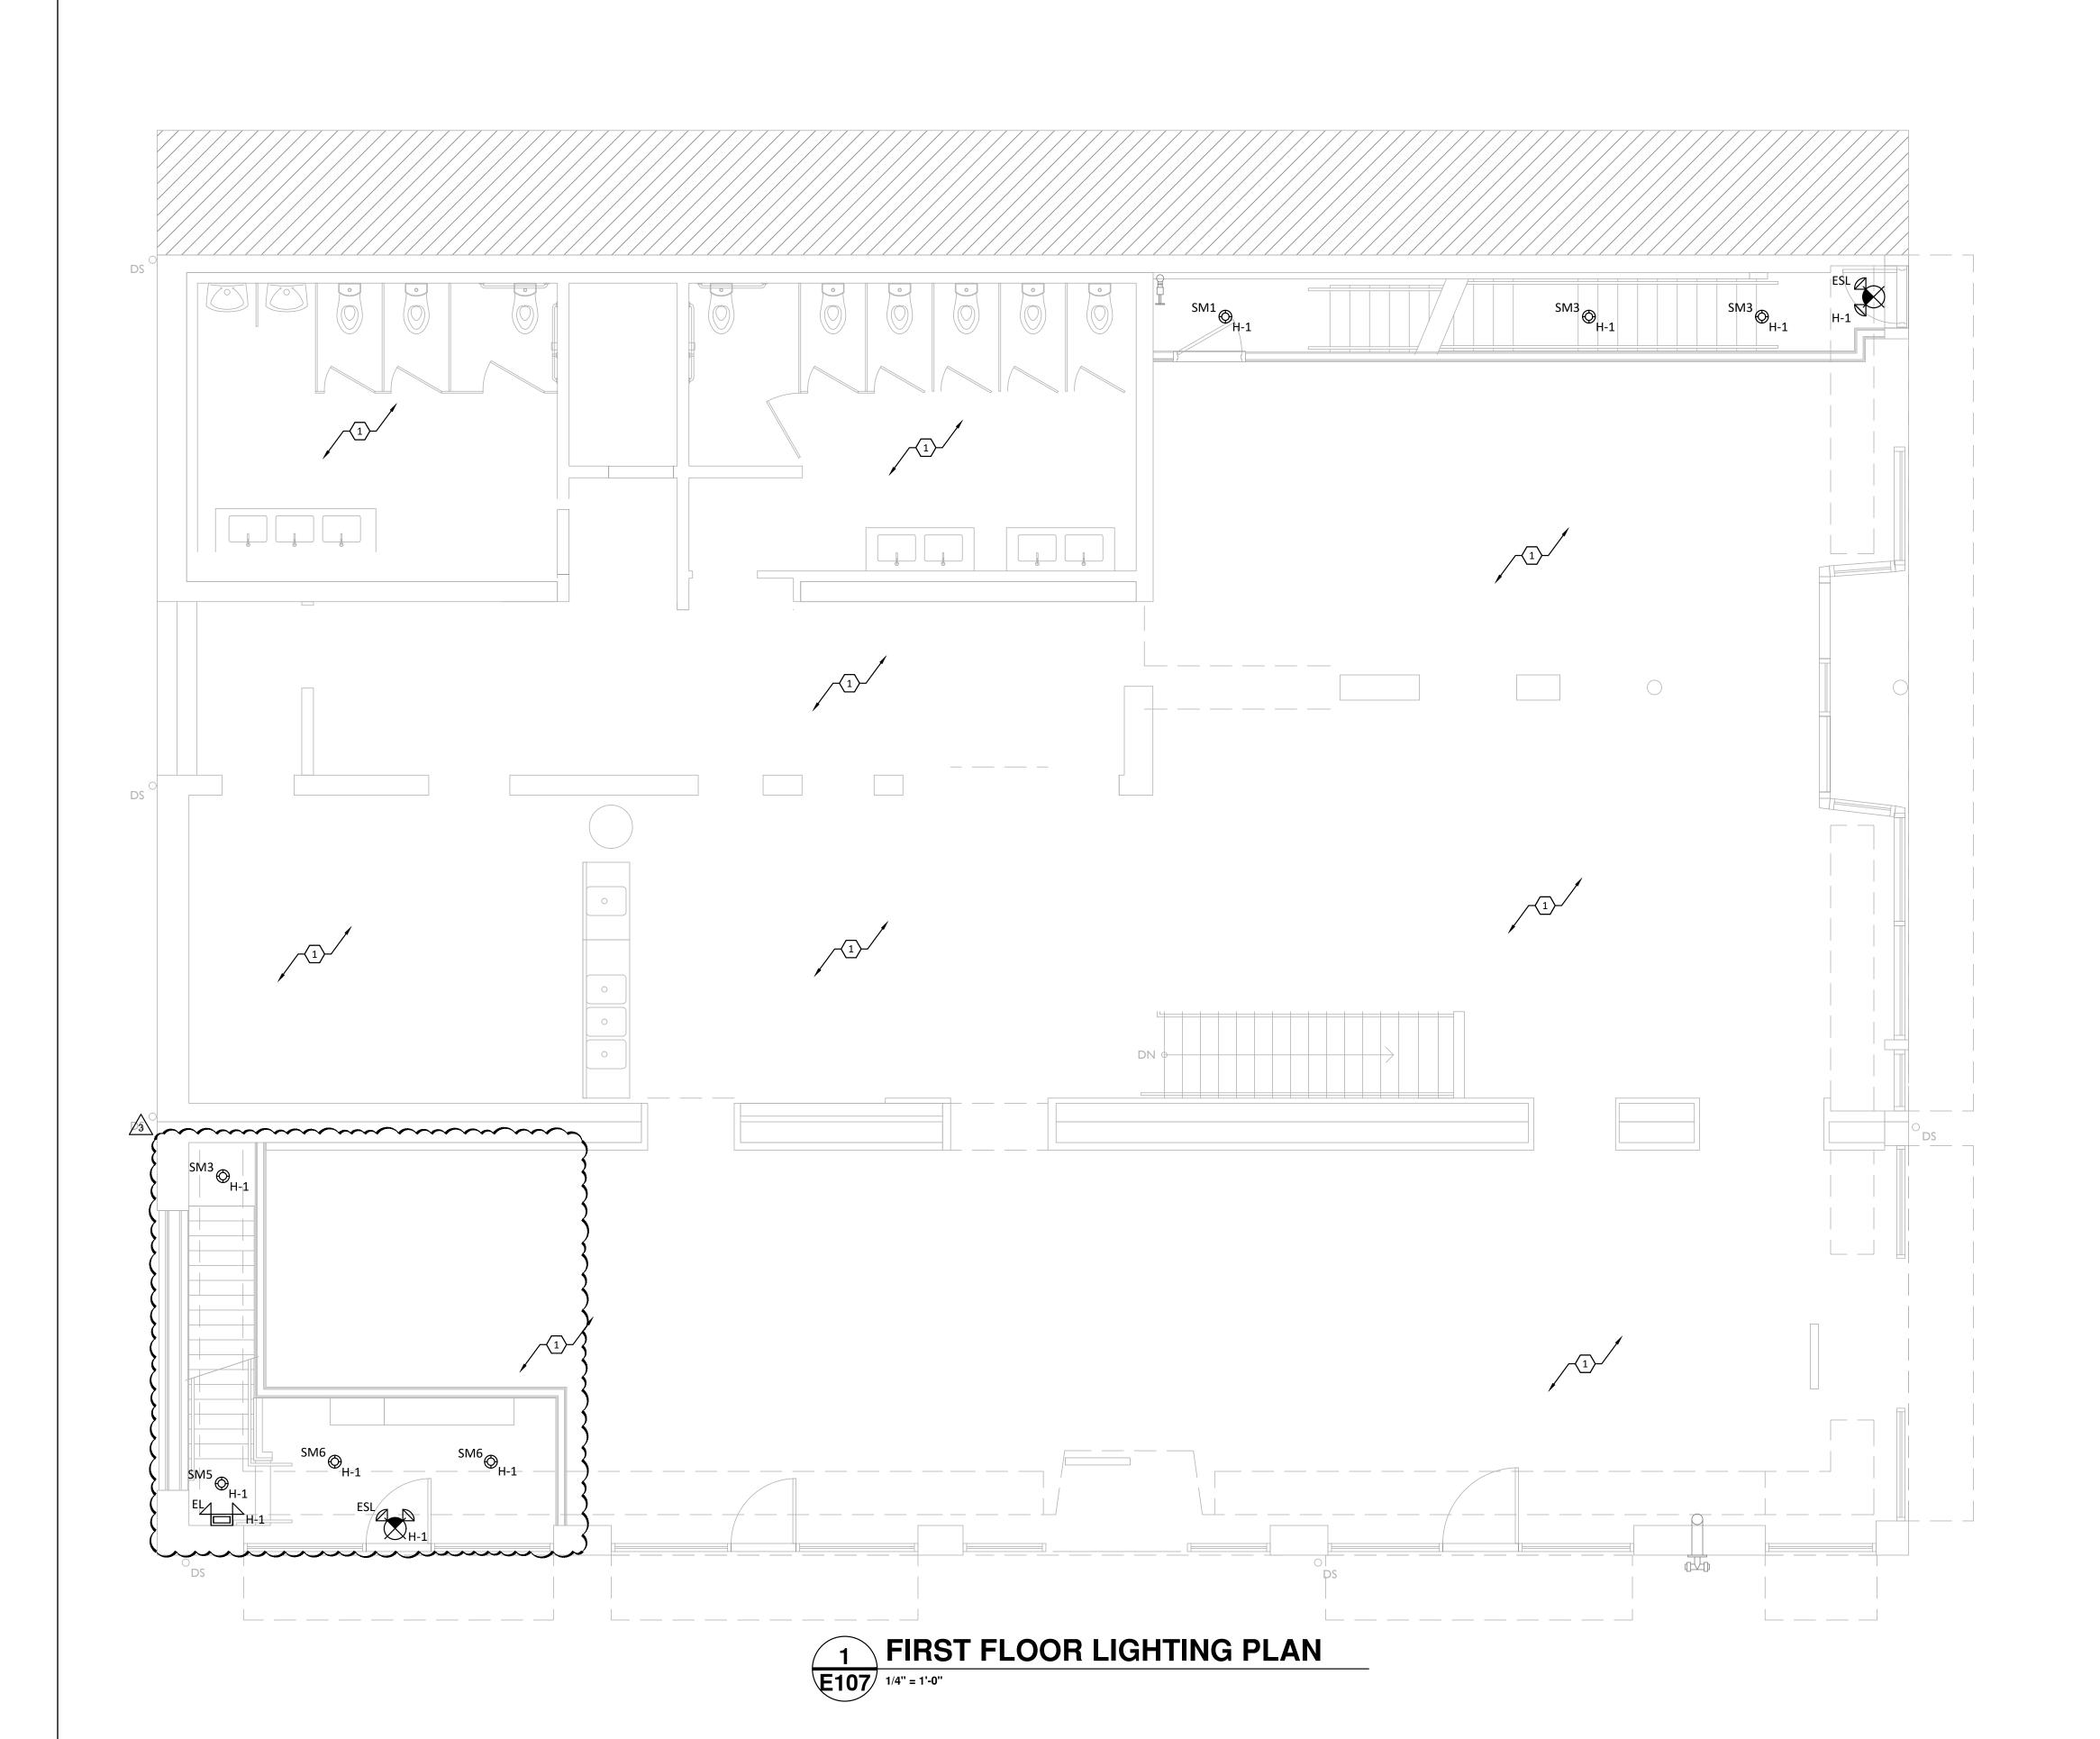
> Design Team:
> MARQUE ENGINEERING Drawn by: MARQUE ENGINEERING

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LIGHTING GENERAL NOTES

- A. EMERGENCY AND EXIT FIXTURES SHALL BE INSTALLED AND CIRCUITED PER LOCAL AND LATEST NATIONAL ELECTRICAL CODES.
- B. EMERGENCY DEVICES SHALL BE PROVIDED WITH AN UNSWITCHED "HOT" TO PROVIDE CONTINUOUS POWER TO DEVICE EVEN WHEN FIXTURE IS OFF.
- C. PROVIDE EMERGENCY LIGHTS TO PROVIDE A MINIMUM OF 1 FOOT CANDLE FOR 90 MINUTES AT FLOOR
- D. COORDINATE ALL WORK WITH OTHER TRADES PRIOR TO ROUGH-IN. VERIFY EXACT LOCATIONS AND MOUNTING HEIGHTS FOR ALL DEVICES PRIOR TO ROUGH-IN.
- ALL NIGHT LIGHTS (SHOWN WITH "NL" DESIGNATION) SHALL BE WIRED AHEAD OF SWITCHING.
- G. LABEL JUNCTION BOXES WITH THE PANEL AND CIRCUIT USED TO FEED THE LUMINARES. AS BUILTS SHALL REFLECT AND SHOW THE CIRCUIT USED BY EACH FIXTURE.
- H. ALL LUMINAIRES, LIGHT SWITCH COVERPLATES, EXIT SIGNS SHALL MATCH ARCHITECTURAL DECOR. PROVIDE PRODUCT SUBMITTAL FOR ARCHITECT AND OWNER APPROVAL.
 I. LUMINAIRES IN CONTACT WITH INSULATION SHALL BE U.L. LISTED FOR THERMAL BARRIER OR BE
- PROVIDED WITH 3" MINIMUM CLEARANCE.

 LIGHTS AND PANELS SHALL NOT BE RECESSED IN FIRE RATED ASSEMBLIES UNLESS BOXED WITH EQUIVALENT CONSTRUCTION AS UTILIZED TO MAINTAINED INTEGRITY OF FIRE RATING.
- K. LIGHTING SHALL BE CIRCUITED AS SHOWN ON PLANS. CIRCUITING SHALL BE THRU-WIRING WHEREVER POSSIBLE. MULTIPLE CONNECTIONS TO A SINGLE LIGHT FIXTURE FOR VOLTAGE DROP CONDITIONS OR AS A RESULT OF A FIELD CONDITION ARE ACCEPTABLE. LUMINAIRES SHALL BE MANUFACTURED TO

ACCOMMODATE THRU-WIRING, ANY RELATED COSTS FOR MULTIPLE CONNECTIONS SHALL BE INCLUDED IN

- PROVIDE LIFTING MEANS TO ACCESS ALL LUMINAIRES DURING FINAL AIMING. AIM DIRECTIONAL LUMINAIRES AFTER INSTALLATION PER DIRECTION FROM OWNER.
- л. PROVIDE UPDATED PANEL SCHEDULES UPON COMPLETION OF WORK.
- ALL CONDUITS RUN IN AREAS WITHOUT SUSPENDED CEILINGS SHALL BE RUN INCONSPICUOUSLY AS POSSIBLE, HIDDEN BEHIND BEAMS, TIGHT TO DECK, ETC. PAINT ALL CONDUIT TO MATCH FINISH OF EACH SPECIFIC AREA.
- O. CONDUIT SHALL NOT BE INSTALLED WITHIN FIRE PROOFING. PROVIDE ALL REQUIRED DROP HANGERS.
- ALL WIRING SHALL BE COPPER, MINIMUM SIZE SHALL BE #12, UNLESS OTHERWISE NOTED.
- Q. BRANCH CIRCUIT CONDUCTORS SHALL BE SIZED FOR A MAXIMUM OF 3% VOLTAGE DROP.
- R. LOCATIONS OF LUMINAIRES WITHIN MECHANICAL EQUIPMENT ROOMS SHALL BE COORDINATED IN FIELD WITH INSTALLED EQUIPMENT. LUMINAIRES SHALL BE LOCATED OVER ACCESS PATHWAYS AROUND EQUIPMENT AND NOT OVER TOP OF DUCTWORK WHERE INACCESSIBLE. DO NOT SUSPEND LUMINAIRES FROM PIPING OR DUCTWORK. PROVIDE APPROPRIATE MOUNTING HARDWARE, UNISTRUT, ALL THREAD, ETC., AS REQUIRED TO SUPPORT FIXTURES.
- . ALL LUMINAIRES WITHIN A ROOM OR AREA SHALL BE CONTROLLED BY SWITCHES/OCCUPANCY SENSORS SHOWN IN THAT ROOM OR AREA UNLESS OTHERWISE NOTED.



KEYED NOTES

1. EXISTING LIGHTING IN THIS AREA TO REMAIN.

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Design Team:

MARQUE ENGINEERING

Drawn by:

MARQUE ENGINEERING

ELDER STREET

NDLAY EXCHANG

| 6 W. ELDER STRE

ob No: 11920 04.26.



SECOND FLOOR LIGHTING PLAN

LIGHTING GENERAL NOTES

- A. EMERGENCY AND EXIT FIXTURES SHALL BE INSTALLED AND CIRCUITED PER LOCAL AND LATEST NATIONAL ELECTRICAL CODES.
- B. EMERGENCY DEVICES SHALL BE PROVIDED WITH AN UNSWITCHED "HOT" TO PROVIDE CONTINUOUS POWER TO DEVICE EVEN WHEN FIXTURE IS OFF.
- C. PROVIDE EMERGENCY LIGHTS TO PROVIDE A MINIMUM OF 1 FOOT CANDLE FOR 90 MINUTES AT FLOOR LEVEL FOR EMERGENCY EGRESS
- D. COORDINATE ALL WORK WITH OTHER TRADES PRIOR TO ROUGH-IN. VERIFY EXACT LOCATIONS AND MOUNTING HEIGHTS FOR ALL DEVICES PRIOR TO ROUGH-IN.
 F. NOTLISED
- ALL NIGHT LIGHTS (SHOWN WITH "NL" DESIGNATION) SHALL BE WIRED AHEAD OF SWITCHING.
- G. LABEL JUNCTION BOXES WITH THE PANEL AND CIRCUIT USED TO FEED THE LUMINARES. AS BUILTS SHALL REFLECT AND SHOW THE CIRCUIT USED BY EACH FIXTURE.

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- PROVIDE PRODUCT SUBMITTAL FOR ARCHITECT AND OWNER APPROVAL.

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- PROVIDED WITH 3" MINIMUM CLEARANCE.
- LIGHTS AND PANELS SHALL NOT BE RECESSED IN FIRE RATED ASSEMBLIES UNLESS BOXED WITH EQUIVALENT CONSTRUCTION AS UTILIZED TO MAINTAINED INTEGRITY OF FIRE RATING.
- K. LIGHTING SHALL BE CIRCUITED AS SHOWN ON PLANS. CIRCUITING SHALL BE THRU-WIRING WHEREVER POSSIBLE. MULTIPLE CONNECTIONS TO A SINGLE LIGHT FIXTURE FOR VOLTAGE DROP CONDITIONS OR AS A RESULT OF A FIELD CONDITION ARE ACCEPTABLE. LUMINAIRES SHALL BE MANUFACTURED TO ACCOMMODATE THRU-WIRING, ANY RELATED COSTS FOR MULTIPLE CONNECTIONS SHALL BE INCLUDED IN
- PROVIDE LIFTING MEANS TO ACCESS ALL LUMINAIRES DURING FINAL AIMING. AIM DIRECTIONAL LUMINAIRES AFTER INSTALLATION PER DIRECTION FROM OWNER.
- M. PROVIDE UPDATED PANEL SCHEDULES UPON COMPLETION OF WORK.
- N. ALL CONDUITS RUN IN AREAS WITHOUT SUSPENDED CEILINGS SHALL BE RUN INCONSPICUOUSLY AS POSSIBLE, HIDDEN BEHIND BEAMS, TIGHT TO DECK, ETC. PAINT ALL CONDUIT TO MATCH FINISH OF EACH SPECIFIC AREA.
- O. CONDUIT SHALL NOT BE INSTALLED WITHIN FIRE PROOFING. PROVIDE ALL REQUIRED DROP HANGERS.
- P. ALL WIRING SHALL BE COPPER, MINIMUM SIZE SHALL BE #12, UNLESS OTHERWISE NOTED.
- Q. BRANCH CIRCUIT CONDUCTORS SHALL BE SIZED FOR A MAXIMUM OF 3% VOLTAGE DROP.
- R. LOCATIONS OF LUMINAIRES WITHIN MECHANICAL EQUIPMENT ROOMS SHALL BE COORDINATED IN FIELD WITH INSTALLED EQUIPMENT. LUMINAIRES SHALL BE LOCATED OVER ACCESS PATHWAYS AROUND EQUIPMENT AND NOT OVER TOP OF DUCTWORK WHERE INACCESSIBLE. DO NOT SUSPEND LUMINAIRES FROM PIPING OR DUCTWORK. PROVIDE APPROPRIATE MOUNTING HARDWARE, UNISTRUT, ALL THREAD, ETC., AS REQUIRED TO SUPPORT FIXTURES.
- S. ALL LUMINAIRES WITHIN A ROOM OR AREA SHALL BE CONTROLLED BY SWITCHES/OCCUPANCY SENSORS SHOWN IN THAT ROOM OR AREA UNLESS OTHERWISE NOTED.



KEYED NOTES

1. CONNECT EXHAUST FAN TO LOCAL LIGHTING BRANCH CIRCUIT. PROVIDE DEDICATED TOGGLE SWITCH FOR EXHAUST FAN CONTROL.

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2230 PARK AVE., STE. 100, CINCINNATI, OF

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Design Team:

MARQUE ENGINEERING

Drawn by:

MARQUE ENGINEERING

LDER STREET

INDLAY EXCHANGE

| 6 W. El Deb street

No: 11920 04.26.20



THIRD FLOOR LIGHTING PLAN

LIGHTING GENERAL NOTES

- A. EMERGENCY AND EXIT FIXTURES SHALL BE INSTALLED AND CIRCUITED PER LOCAL AND LATEST NATIONAL ELECTRICAL CODES.
- B. EMERGENCY DEVICES SHALL BE PROVIDED WITH AN UNSWITCHED "HOT" TO PROVIDE CONTINUOUS POWER TO DEVICE EVEN WHEN FIXTURE IS OFF.
- C. PROVIDE EMERGENCY LIGHTS TO PROVIDE A MINIMUM OF 1 FOOT CANDLE FOR 90 MINUTES AT FLOOR LEVEL FOR EMERGENCY EGRESS
- D. COORDINATE ALL WORK WITH OTHER TRADES PRIOR TO ROUGH-IN. VERIFY EXACT LOCATIONS AND MOUNTING HEIGHTS FOR ALL DEVICES PRIOR TO ROUGH-IN.
 F. NOTLISED
- ALL NIGHT LIGHTS (SHOWN WITH "NL" DESIGNATION) SHALL BE WIRED AHEAD OF SWITCHING.
- G. LABEL JUNCTION BOXES WITH THE PANEL AND CIRCUIT USED TO FEED THE LUMINARES. AS BUILTS SHALL REFLECT AND SHOW THE CIRCUIT USED BY EACH FIXTURE.

ALL LUMINAIRES, LIGHT SWITCH COVERPLATES, EXIT SIGNS SHALL MATCH ARCHITECTURAL DECOR.

- PROVIDE PRODUCT SUBMITTAL FOR ARCHITECT AND OWNER APPROVAL.

 I. LUMINAIRES IN CONTACT WITH INSULATION SHALL BE U.L. LISTED FOR THERMAL BARRIER OR BE
- PROVIDED WITH 3" MINIMUM CLEARANCE.

 LIGHTS AND PANELS SHALL NOT BE RECESSED IN FIRE RATED ASSEMBLIES UNLESS BOXED WITH
- EQUIVALENT CONSTRUCTION AS UTILIZED TO MAINTAINED INTEGRITY OF FIRE RATING.

 LIGHTING SHALL BE CIRCUITED AS SHOWN ON PLANS. CIRCUITING SHALL BE THRU-WIRING WHEREVER
- POSSIBLE. MULTIPLE CONNECTIONS TO A SINGLE LIGHT FIXTURE FOR VOLTAGE DROP CONDITIONS OR AS A RESULT OF A FIELD CONDITION ARE ACCEPTABLE. LUMINAIRES SHALL BE MANUFACTURED TO ACCOMMODATE THRU-WIRING, ANY RELATED COSTS FOR MULTIPLE CONNECTIONS SHALL BE INCLUDED IN
- PROVIDE LIFTING MEANS TO ACCESS ALL LUMINAIRES DURING FINAL AIMING. AIM DIRECTIONAL LUMINAIRES AFTER INSTALLATION PER DIRECTION FROM OWNER.
- M. PROVIDE UPDATED PANEL SCHEDULES UPON COMPLETION OF WORK.
- N. ALL CONDUITS RUN IN AREAS WITHOUT SUSPENDED CEILINGS SHALL BE RUN INCONSPICUOUSLY AS POSSIBLE, HIDDEN BEHIND BEAMS, TIGHT TO DECK, ETC. PAINT ALL CONDUIT TO MATCH FINISH OF EACH SPECIFIC AREA.
- O. CONDUIT SHALL NOT BE INSTALLED WITHIN FIRE PROOFING. PROVIDE ALL REQUIRED DROP HANGERS.
- . ALL WIRING SHALL BE COPPER, MINIMUM SIZE SHALL BE #12, UNLESS OTHERWISE NOTED.
- Q. BRANCH CIRCUIT CONDUCTORS SHALL BE SIZED FOR A MAXIMUM OF 3% VOLTAGE DROP.
- R. LOCATIONS OF LUMINAIRES WITHIN MECHANICAL EQUIPMENT ROOMS SHALL BE COORDINATED IN FIELD WITH INSTALLED EQUIPMENT. LUMINAIRES SHALL BE LOCATED OVER ACCESS PATHWAYS AROUND EQUIPMENT AND NOT OVER TOP OF DUCTWORK WHERE INACCESSIBLE. DO NOT SUSPEND LUMINAIRES FROM PIPING OR DUCTWORK. PROVIDE APPROPRIATE MOUNTING HARDWARE, UNISTRUT, ALL THREAD, ETC., AS REQUIRED TO SUPPORT FIXTURES.
- S. ALL LUMINAIRES WITHIN A ROOM OR AREA SHALL BE CONTROLLED BY SWITCHES/OCCUPANCY SENSORS SHOWN IN THAT ROOM OR AREA UNLESS OTHERWISE NOTED.



KEYED NOTES

CONNECT EXHAUST FAN TO LOCAL LIGHTING BRANCH CIRCUIT. PROVIDE DEDICATED TOGGLE SWITCH FOR EXHAUST FAN CONTROL.

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Design Team:
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Drawn by:


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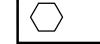
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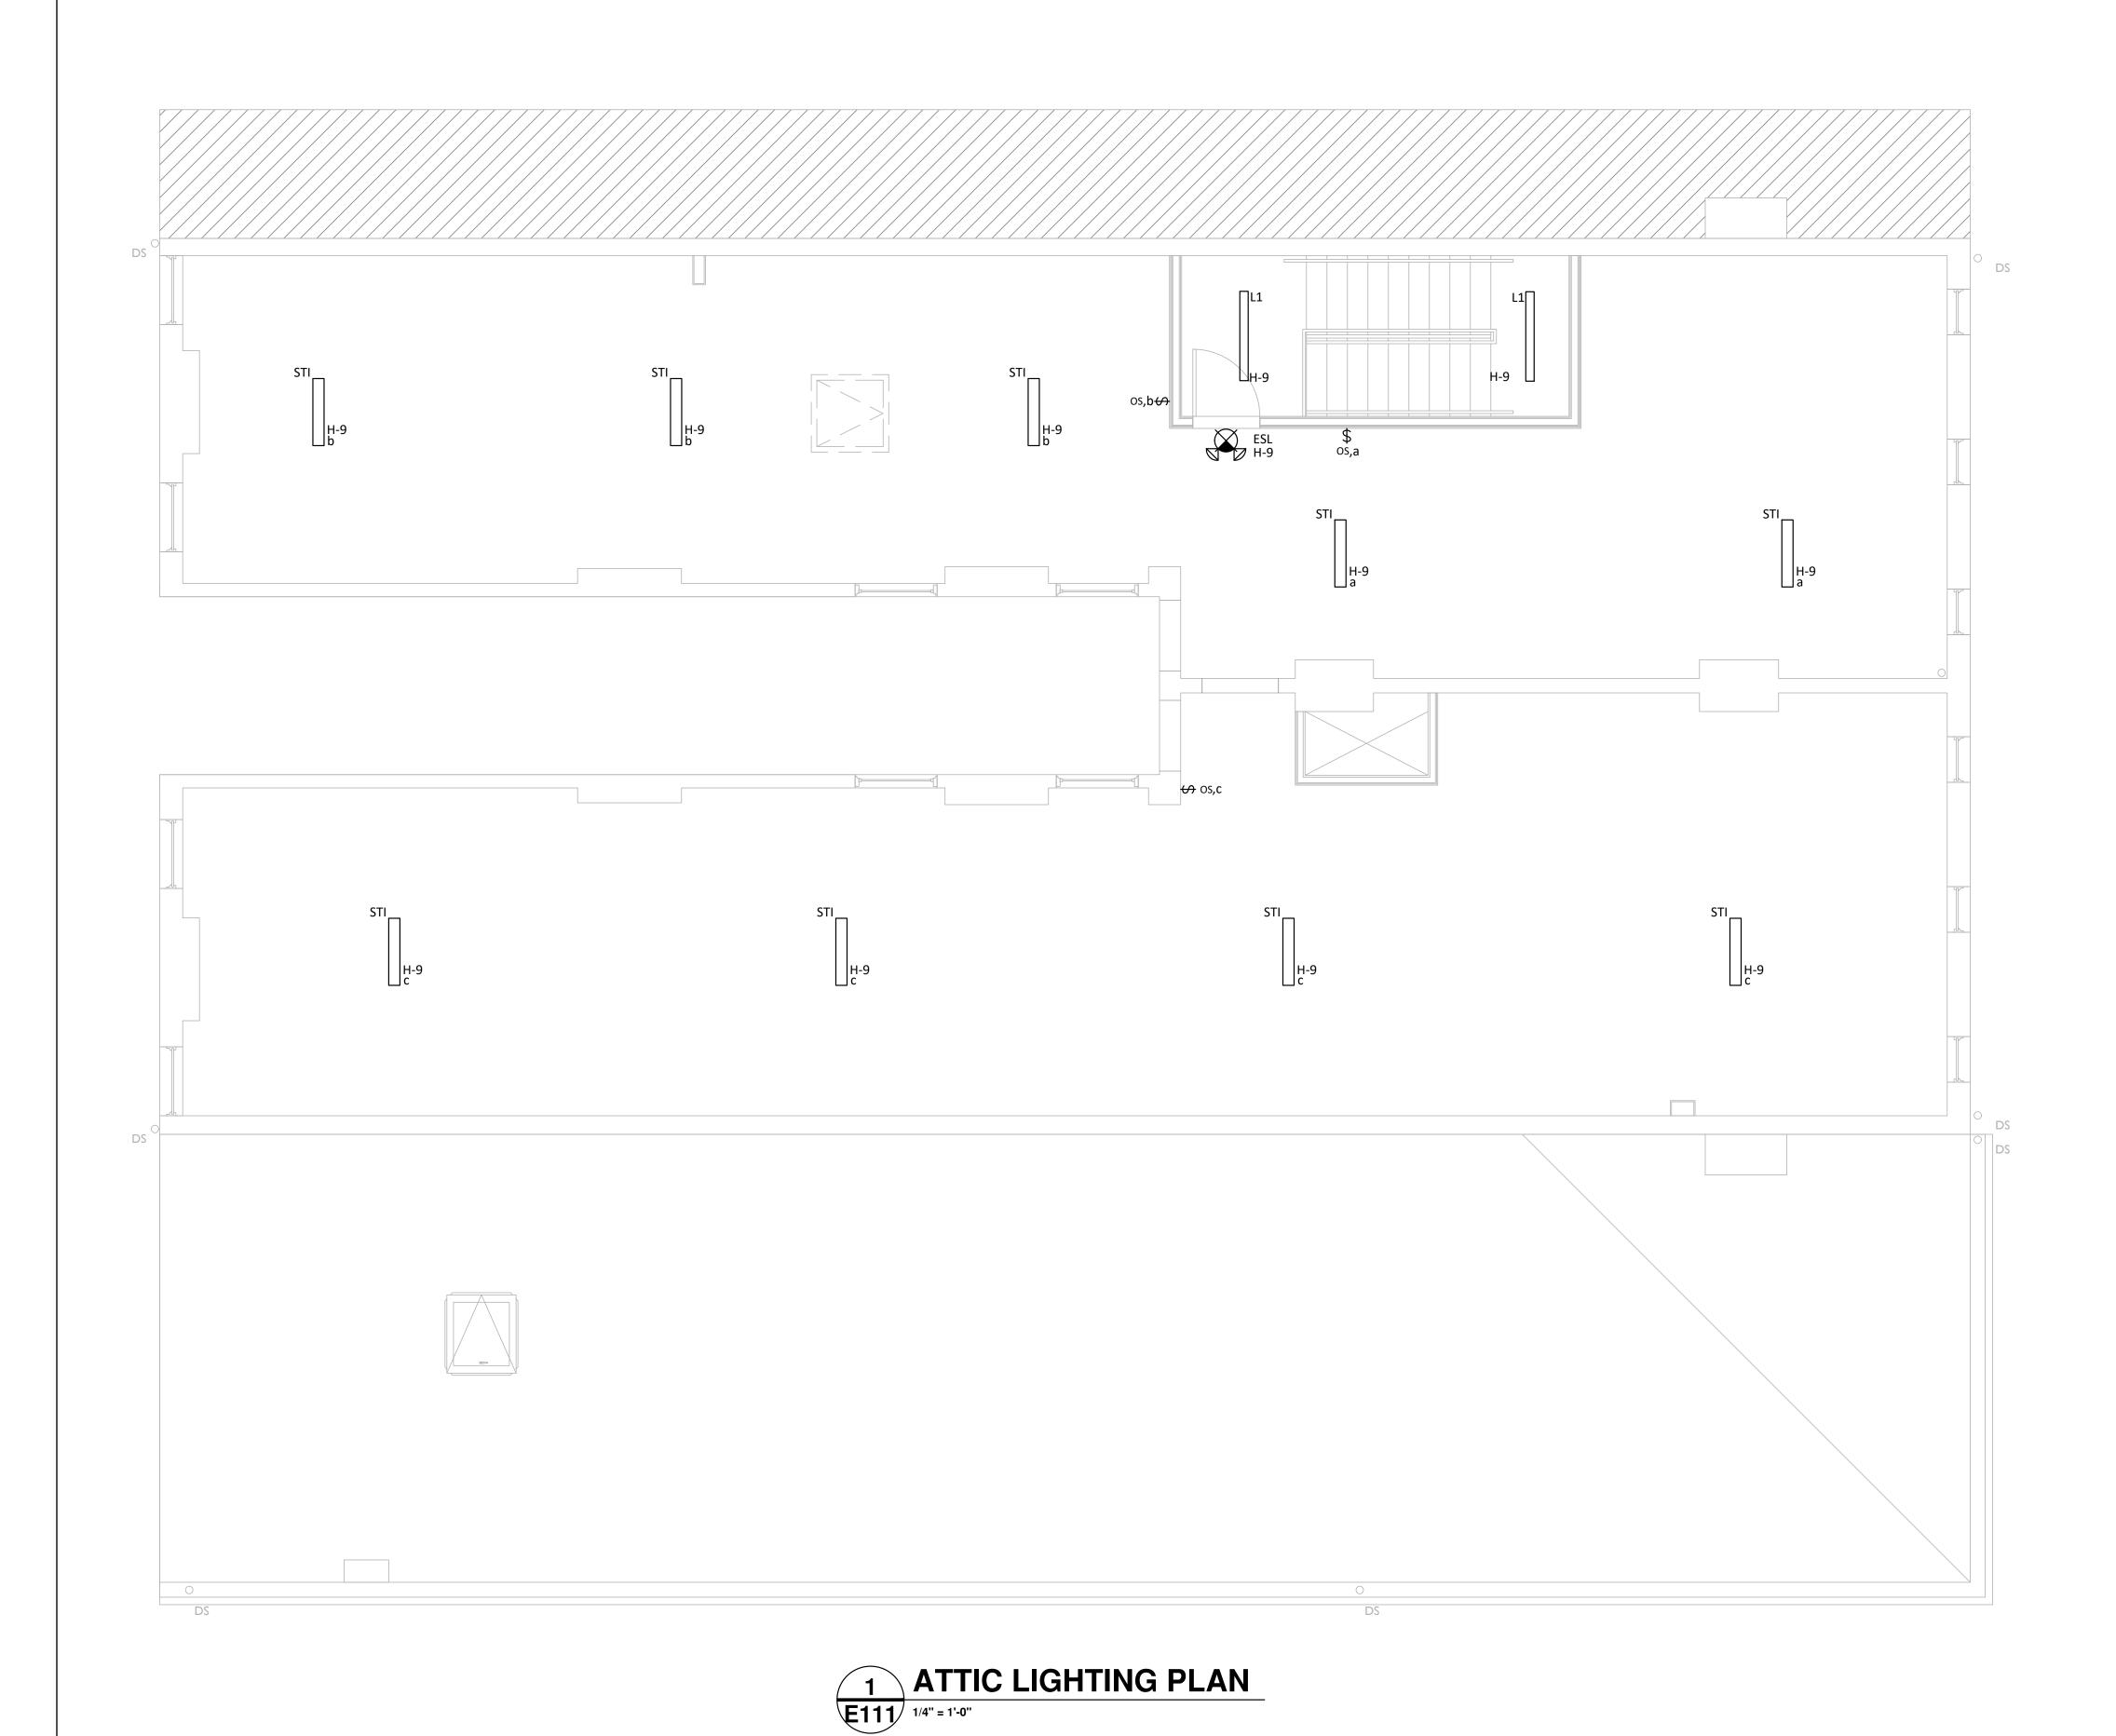
Design Team:
MARQUE ENGINEERING
Drawn by:

Drawn by:
MARQUE ENGINEERING

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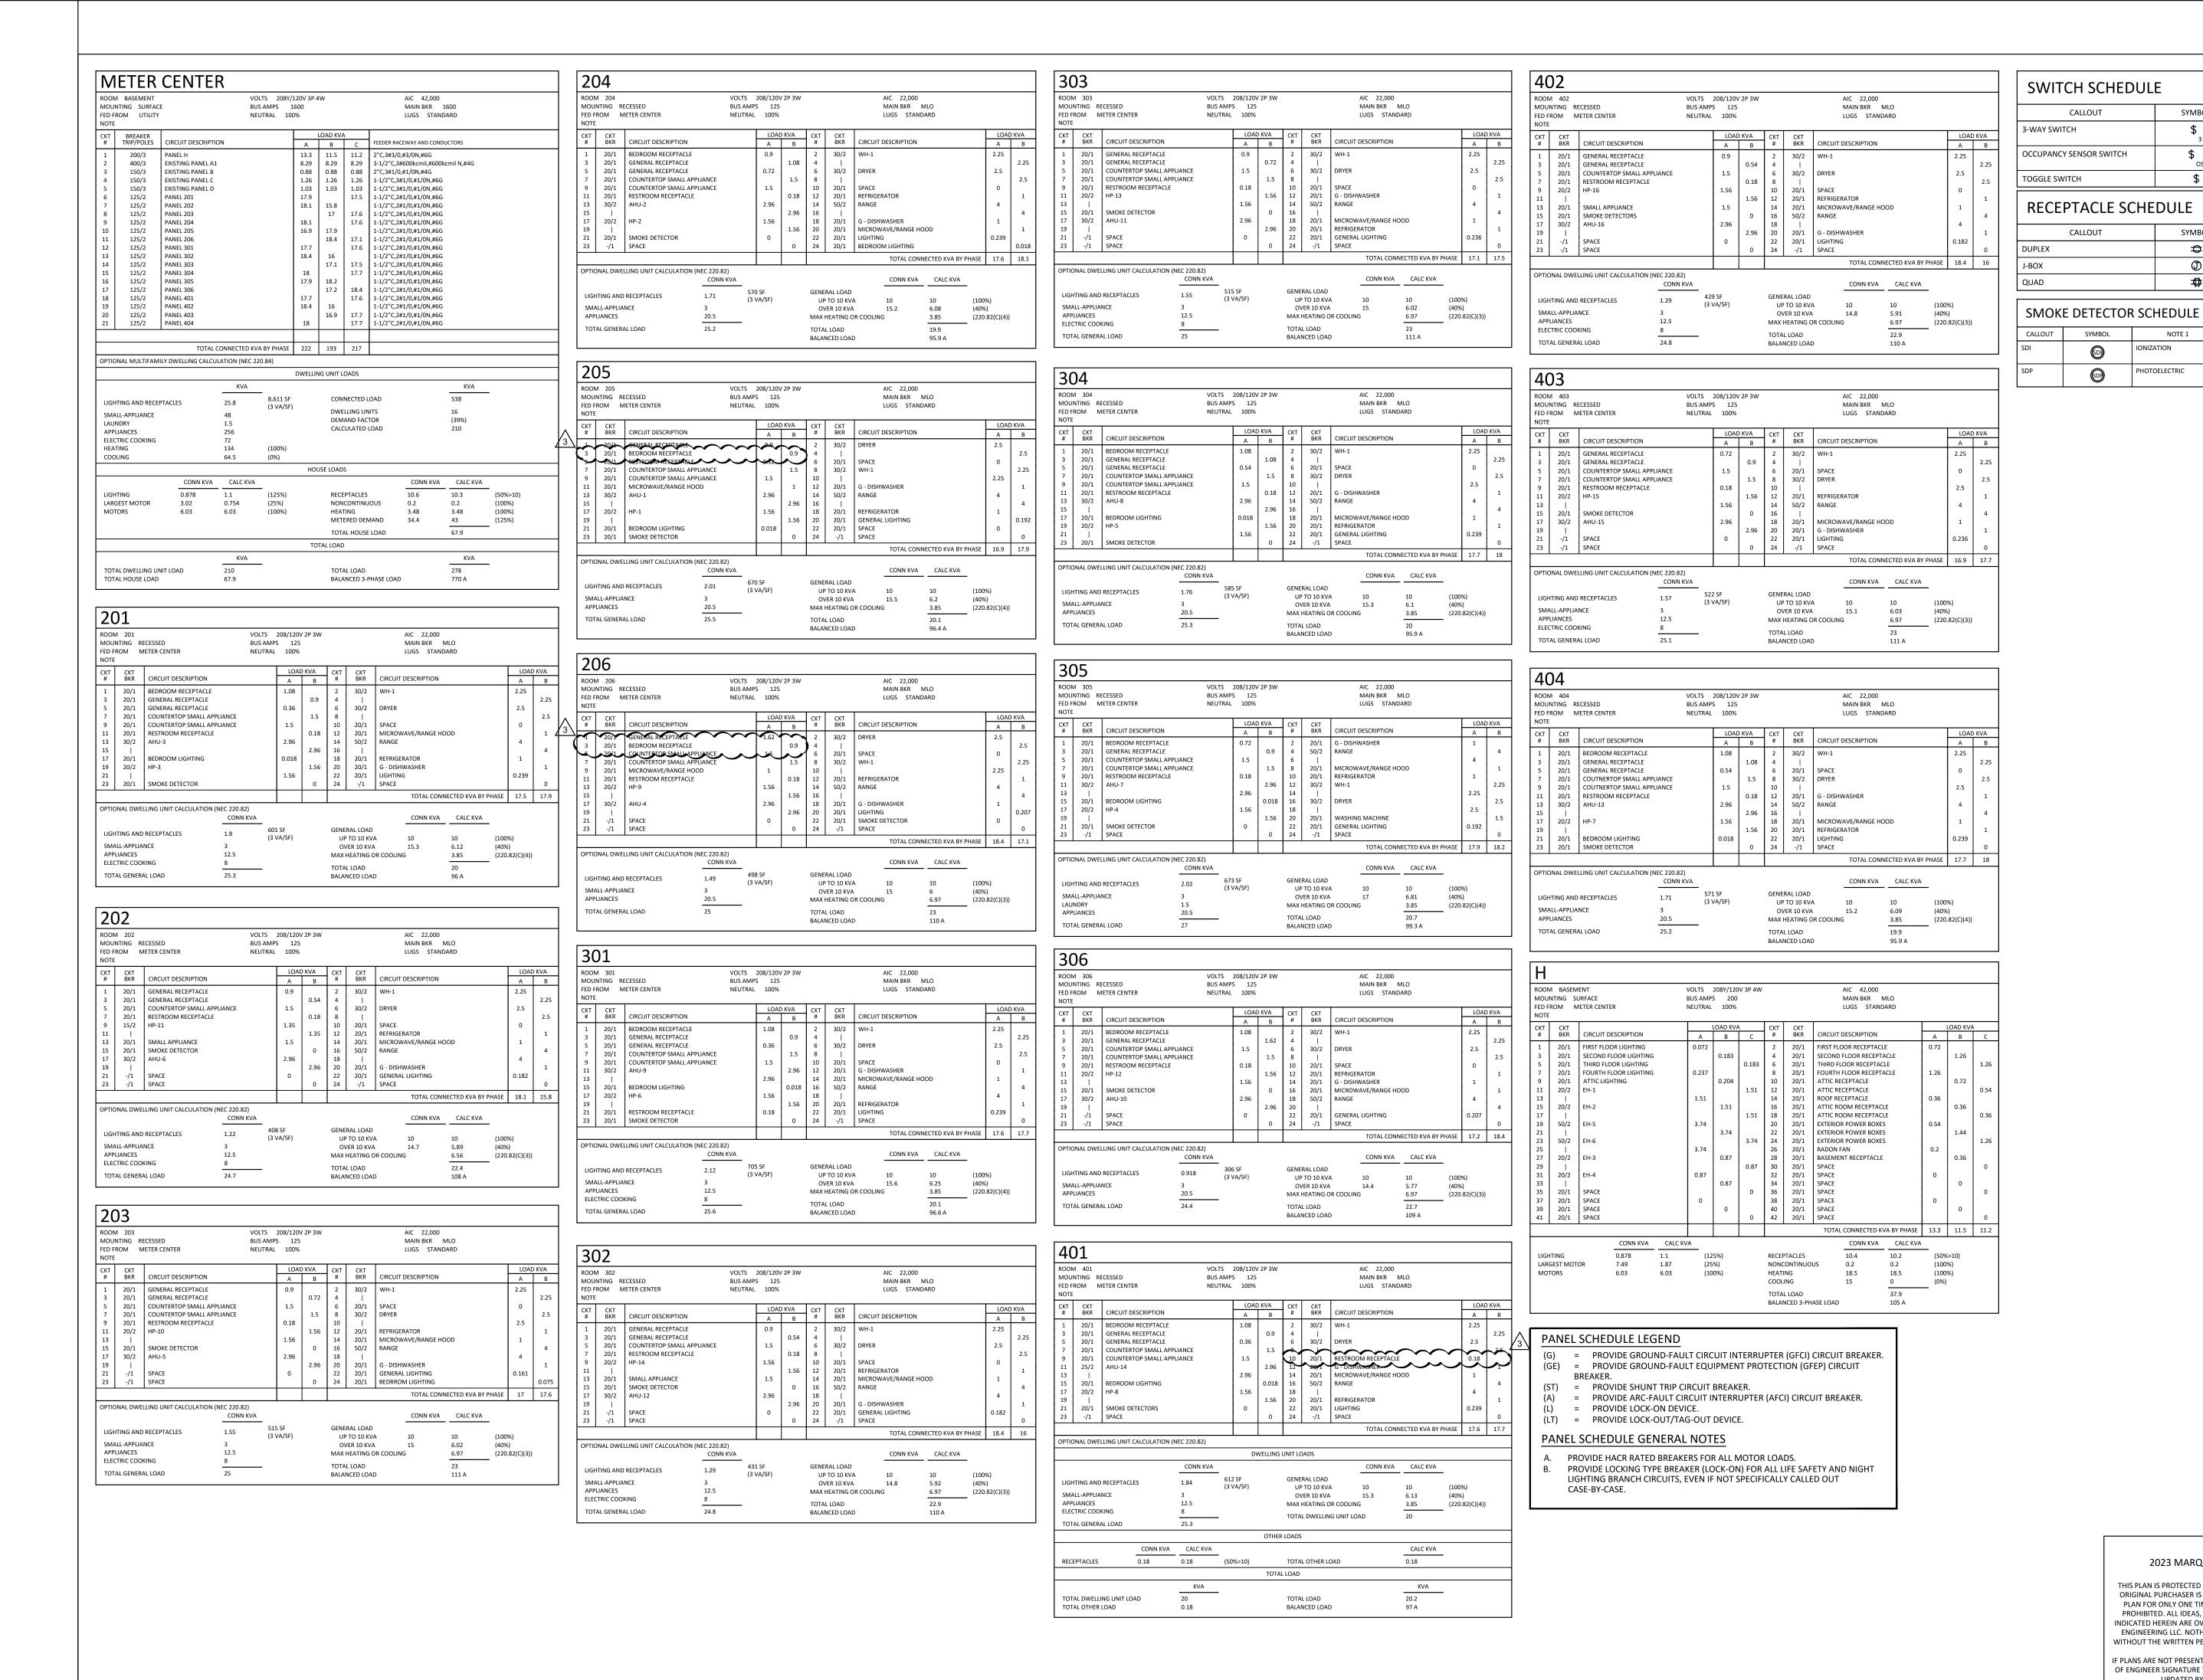
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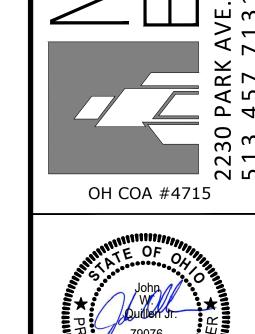
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ALL ELECTRICAL WORK SHALL BE DONE IN STRICT ACCORDANCE WITH THE LATEST EDITION OF NFPA 70 AND ALL REGULATIONS, LAWS, AND ORDINANCES WHICH MAY BE APPLICABLE AND BY TRAINED AND LICENSED ELECTRICIANS

BEFORE SUBMITTING A BID, EXAMINE DOCUMENTS OF ALL OTHER TRADES, VISIT THE SITE AND GET ACQUAINTED WITH ALL CONDITIONS THAT MAY IN ANY WAY AFFECT THE EXECUTION OF THIS CONTRACT. TAKE MEASUREMENTS AND BE RESPONSIBLE FOR EXACT SIZE AND LOCATIONS OF ALL OPENINGS REQUIRED. VERIFY INSTALLATION MAY BE MADE IN COMPLETE ACCORDANCE WITH ALL PERTINENT CODES AND REGULATIONS. IN THE EVENT OF DISCREPANCY, IMMEDIATELY NOTIFY THE PROFESSIONAL ENGINEER OF RECORD. DO NOT PROCEED WITH THE INSTALLATION IN AREAS OF DISCREPANCY UNTIL ALL SUCH DISCREPANCIES HAVE BEEN FULLY RESOLVED

IT IS NOT THE INTENT OF THE DRAWINGS THAT EXISTING CONDITIONS BE ACCURATELY SHOWN. EXISTING ELECTRICAL WORK IS SHOWN TO LIMITED EXTENT ON DRAWINGS AND IS SHOWN FOR GENERAL REFERENCE ONLY, LOCATIONS AND INFORMATION WERE DERIVED FROM CURSORY SITE VISUAL OBSERVATIONS OR FROM DOCUMENTS THAT WERE PREPARED FOR PREVIOUSLY INSTALLED WORK WHEN

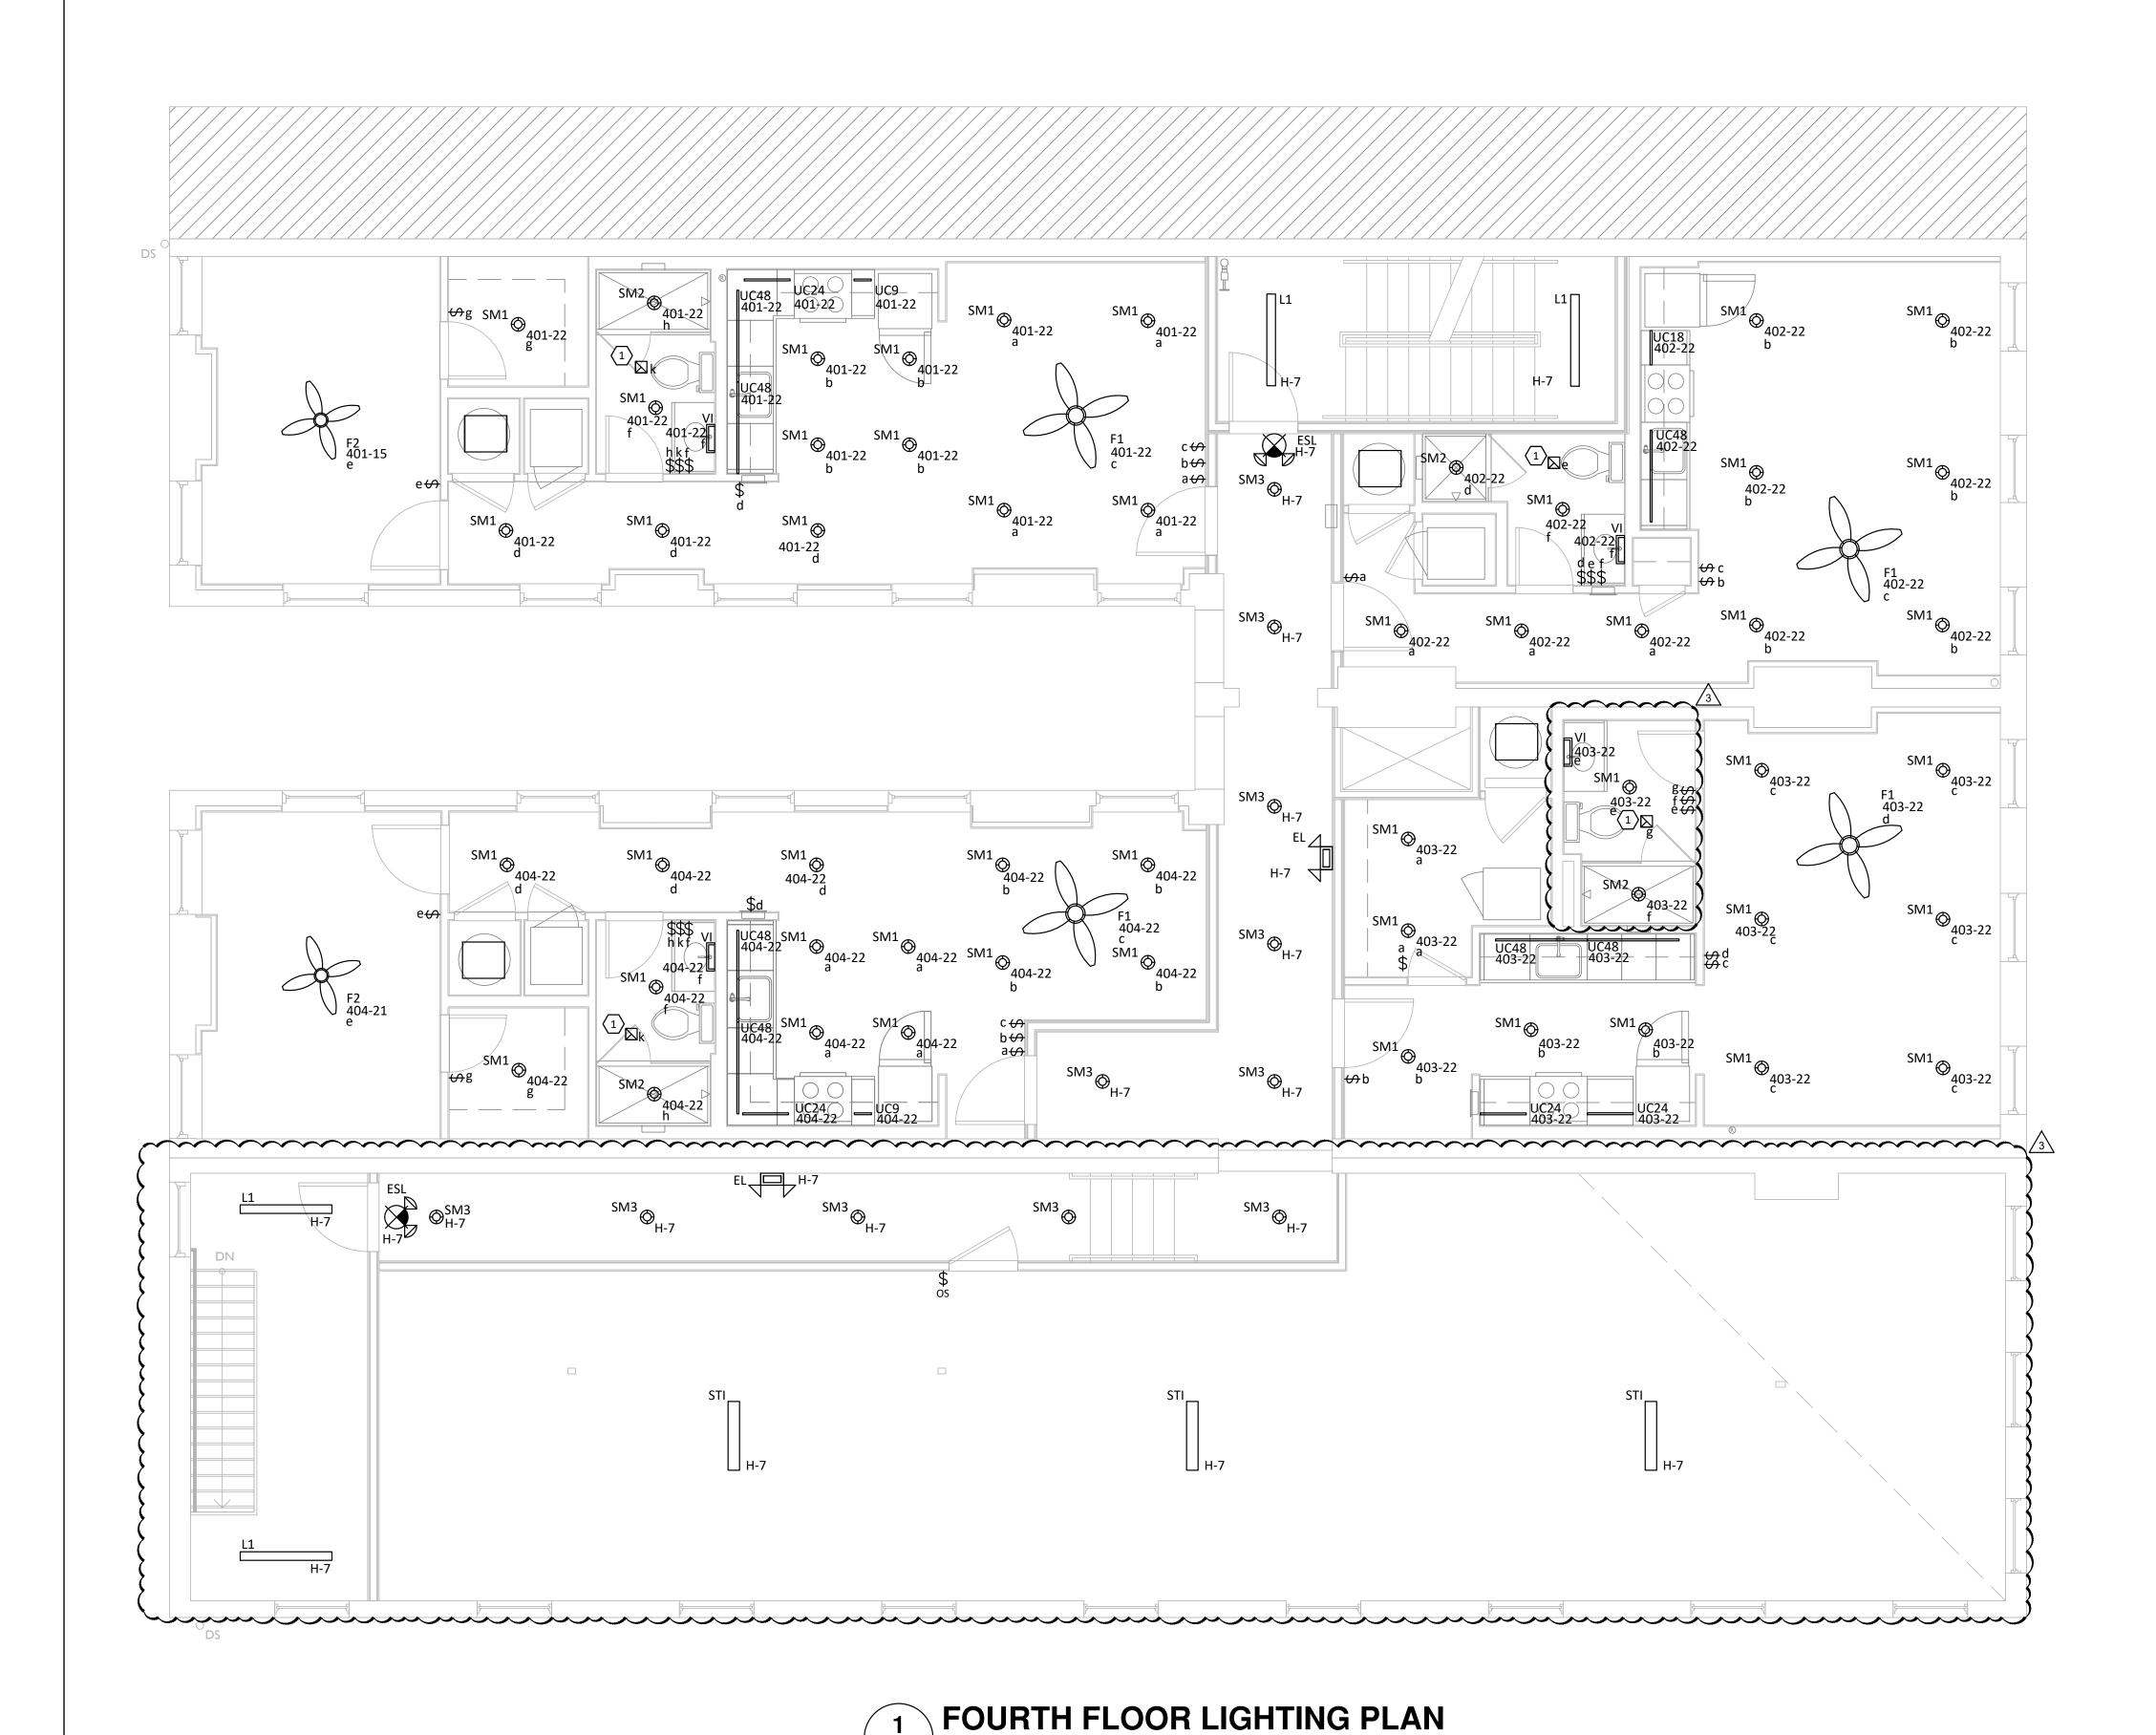LIST OF EQUIPMENT, TABULATIONS OF DATA, SCHEDULES, ETC. APPEARING IN THE SPECIFICATIONS OR ON THE DRAWINGS ARE INCLUDED FOR REFERENCE BY THE CONTRACTOR IN ARRIVING AT A MORE COMPLETE UNDERSTANDING OF THE INTENDED INSTALLATION. THEY ARE NOT INTENDED OR TO BE CONSTRUED AS RELIEVING THE RESPONSIBILITY OF THE CONTRACTOR IN MAKING HIS/HER OWN TAKE-OFF AND

THE WORK COVERED BY THESE SPECIFICATIONS SHALL CONSIST OF PROVIDING ALL NEW MATERIAL, LABOR, EQUIPMENT, AND SERVICES NECESSARY FOR A COMPLETE ELECTRICAL INSTALLATION AS SPECIFIED HEREIN. WORK IN THIS SECTION INCLUDES, BUT IS NOT LIMITED TO

- TELEPHONE CONDUIT SYSTEM
- DATA COMMUNICATIONS CONDUIT SYSTEM WIRING DEVICES

THE FOLLOWING ITEMS:

- BRANCH CIRCUITING GROUNDING
- CONNECTION OF HVAC EQUIPMENT TEMPORARY ELECTRICAL WIRING LIGHTING

WHENEVER THE WORDS "CONTRACTOR" APPEAR ON ELECTRICAL DRAWINGS OR IN THESE SPECIFICATIONS, IT SHALL REFER TO THE ELECTRICAL SUB-CONTRACTOR. WHENEVER THE WORD "PROVIDE" APPEARS IN THESE DOCUMENTS, IT SHALL BE INTERPRETED TO MEAN

MUST BE APPROVED BY THE OWNER PRIOR TO THE BEGINNING OF ANY WORK. PRIOR TO ALL WORK, CARFELLLY INSPECT THE INSTALLED WORK OF ALL OTHER TRADES AND VERIEY THAT ALL SLICH WORK IS COMPLETE TO THE POINT WHERE THIS INSTALLATION MAY PROPERLY COMMENCE. COORDINATE THE INSTALLATION OF ELECTRICAL ITEMS WITH THE

COORDINATE ALL WORK WITH THE OWNER TO MINIMIZE INTERRUPTION OF BUILDING OPERATION. SCHEDULE OF ALL POWER OUTAGES

SCHEDULES FOR WORK OF ALL OTHER TRADES TO PREVENT UNNECESSARY DELAYS IN THE TOTAL WORK. COORDINATE EXACT ELECTRICAL REQUIREMENTS (VOLTAGE, PHASE, AMPS, WIRING, CONNECTIONS, AND ETC.) OF EQUIPMENT FURNISHED

BY OTHERS PRIOR TO PERFORMING WORK. COORDINATE MANUFACTURER'S ELECTRICAL WIRING AND CONNECTION REQUIREMENTS WITH PRODUCT DATA AND/OR SUBMITTAL DRAWINGS PRIOR TO ROUGH-IN AND FURNISHING EQUIPMENT'S OVER-CURRENT PROTECTIVE DEVICES. ALL WIRING REQUIREMENTS SHOWN ARE SCHEMATIC IN NATURE. COORDINATE SPECIALITY RECEPTACLE AND/OR OUTLET TYPES WITH FOUIDMENT REQUIREMENTS.

 WHEN LOOSE DISCONNECT SWITCHES ARE FURNISHED UNDER MECHANICAL CONTRACT, RECEIVE AND INSTALL AND PROVIDE ALL FINAL TERMINATIONS NECESSARY

VERIFY ALL EQUIPMENT LOCATIONS, SWITCHES, RECEPTACLES, LIGHTING FIXTURES, ETC., IN FIELD. THE OWNER RESERVES THE RIGHT TO CHANGE LOCATION OF ANY OUTLET OR FIXTURE FOR A DISTANCE OF 15 FT. IN ANY DIRECTION FROM DRAWING LOCATION, BEFORE THE WORK IS ACTUALLY ROUGHED IN, AT NO EXTRA CHARGE

WHERE LIGHT FIXTURE AND OTHER ELECTRICAL ITEMS ARE SHOWN IN CONFLICT WITH LOCATIONS OF STRUCTURAL MEMBERS AND MECHANICAL OR OTHER EQUIPMENT, PROVIDE ALL REQUIRED SUPPORTS AND WIRING TO CLEAR THE ENCROACHMENT

PROVIDE ALL MISCELLANEOUS HARDWARE AND MATERIAL NOT SPECIFIED BUT NECESSARY TO PROVIDE A COMPLETE AND WORKING ELECTRICAL SYSTEM. THIS HARDWARE SHALL INCLUDE, BUT NOT BE LIMITED TO, ALL MISCELLANEOUS CONDUIT FITTINGS AND MOUNTING HARDWARE, LUMINAIRE MOUNTING HARDWARE, BRACKETS, CONNECTORS, CORDS AND PLUGS.

PROVIDE ACCESS DOORS TO PROVIDE ACCESS TO ALL J-BOXES, PULL BOXES, AND OTHER EQUIPMENT AS REQUIRED. ACCESS DOORS FOR INSTALLATION IN FIRE RATED CONSTRUCTION SHALL HAVE APPROPRIATE FIRE RATING.

DURING PROGRESS OF THE WORK, MAINTAIN ON DRAWINGS AT THE SITE, AN ACCURATE RECORD OF THE INSTALLATION OF THE ELECTRICAL SYSTEM, INDICATING ALL ITEMS WHICH HAVE BEEN CHANGED OR ADDED.

APPLY FOR AND PAY FOR ALL PERMITS AND INSPECTIONS REQUIRED BY LOCAL AUTHORITY, FOR THE APPROVAL OF WORK.

A CERTIFICATE OF FINAL INSPECTION AND APPROVAL SHALL BE SUBMITTED WITH THE CONTRACTOR'S REQUEST FOR FINAL PAYMENT. NO FINAL PAYMENT WILL BE APPROVED WITHOUT THIS CERTIFICATE.

GUARANTEE ALL WORKMANSHIP, MATERIAL, AND EQUIPMENT AND REPLACE ANY FOUND DEFECTIVE WORK WITHOUT COST TO THE OWNER, FOR A PERIOD OF ONE YEAR AFTER FINAL ACCEPTANCE.

ALL MATERIALS, APPARATUS AND EQUIPMENT SHALL BEAR THE SEAL OF UNDERWRITERS LABORATORIES INC. (UL) OR A SIMILAR CREDIBLE TESTING AGENCY DESIGN BASIS MANUFACTURERS OF MATERIAL AND FOLUPMENT ARE SPECIFIED AND PLANS ARE DETAILED ACCORDING TO THIS MATERIAL. CONTRACTOR SHALL BASE HIS BID ON FURNISHING AND INSTALLING THIS MAKE OF MATERIAL AND EQUIPMENT.

AN ACCEPTABLE MANUFACTURER'S NAME AND MODEL NUMBER OF A PRODUCT MAY BE PROVIDED IN THESE DOCUMENTS. THIS IS THE EQUIPMENT INCLUDED DURING THE DESIGN PROCESS AND FORMS THE BASIS OF A STANDARD OF QUALITY. WHERE MORE THAN ONE MAKE OF MATERIAL OR EQUIPMENT IS SPECIFIED, THE CONTRACTOR SHALL STATE IN HIS BID WHICH MAKE HE PROPOSES TO FURNISH AND INSTALL. SHOP DRAWING APPROVAL SHALL BE OBTAINED PRIOR TO SHIPMENT OF EQUIPMENT

VERIFY THE MODEL NUMBER OR PRODUCT IS STILL ACCURATE AND MEETS ALL REQUIREMENTS SHOWN ON THE DRAWINGS. IF THERE IS A DISCREPANCY BETWEEN THE REQUIREMENTS AND THE PRODUCT OR MODEL NUMBER, THE STRICTER OF THE TWO SHALL GOVER

26 05 03 SUBMITTALS FOR ELECTRICAL SYSTEMS

SUBMIT SHOP DRAWINGS AND/OR PRODUCT DATA (ELECTRONIC COPIES) ON THE FOLLOWING ITEMS FOR REVIEW BEFORE FABRICATION

- LOW VOLTAGE TRANSFORMERS PANEL BOARDS AND CIRCUIT BREAKERS
- DISCONNECT SWITCHES WIRING DEVICES
- LIGHTING LIGHTING CONTROLS (SWITCHES - TOGGLE, DIMMER, OCCUPANT SENSORS, ETC.)
- DISTRIBUTION PANELS
- METER CENTERS

MAINTENANCE MANUALS: THE MANUALS SHALL INCLUDE WIRING DIAGRAMS, MAINTENANCE AND OPERATING INSTRUCTIONS, PARTS LISTINGS, AND COPIES OF OTHER SUBMITTALS INDICATED FOR INCLUSION.

REVIEW AND CORRECTIONS OR COMMENTS MADE ON SHOP DRAWINGS, PRODUCT DATA: CATALOGS, CUT SHEETS, CHARTS, AND OTHER ITEMS DURING CONSTRUCTION PHASE SUBMITTAL REVIEW DO NOT RELIEVE CONTRACTOR FROM COMPLIANCE WITH REQUIREMENTS OF THE CONTRACT DOCUMENTS. FOR PROVIDING A COMPLETE AND FUNCTIONING PROJECT, NOR SHALL THEY RELIEVE CONTRACTOR FROM RESPONSIBILITY FOR DEVIATIONS OR ERRORS OF ANY SORT. THIS REVIEW IS FOR THE LIMITED PURPOSE OF CHECKING FOR

CONFORMANCE WITH INFORMATION GIVEN AND THE DESIGN CONCEPT EXPRESSED IN THE CONTRACT

DOCUMENTS. CONTRACTOR REMAINS RESPONSIBLE FOR DETERMINING THE ACCURACY AND COMPLETENESS OF OTHER DETAILS SUCH AS DIMENSIONS AND QUANTITIES. FOR SUBSTANTIATING INSTRUCTIONS FOR INSTALLATIONS, VERIFYING MATERIALS REQUIRED, OBTAINING FIELD MEASUREMENTS AND RELATED CRITERIA, COORDINATING WORK WITH OTHER DISCIPLINES AND PERFORMING WORK IN COMPLIANCE WITH THE CONTRACT DOCUMENTS.

ANY CHANGES TO ITEMS SPECIFIED MUST BE SUBMITTED IN WRITING AS A SUBSTITUTION, WITH COMPLETE DOCUMENTATION OF PRICE DIFFERENTIAL AND EQUIPMENT DETAILS. SUBSTITUTIONS PROVIDED SHALL BE REVIEWED AT MARQUE ENGINEERING'S HOURLY RATES. REVIEW SHALL BE PAID FOR BY THE CONTRACTOR TO MARQUE ENGINEERING AT NO COST TO THE OWNER. BY USING PRE-APPROVED SUBSTITUTIONS, THE CONTRACTOR ACCEPTS ALL RESPONSIBILITY AND ASSOCIATED COSTS FOR ALL REQUIRED MODIFICATIONS TO THE CONTRACT DOCUMENTS TO INCLUDE BUT NOT LIMITED TO MATERIAL OR EQUIPMENT COSTS FOR THEIR OR OTHER TRADES, AND ENSURING THAT SUBSTITUTED MATERIALS AND EQUIPMENT TO BE FURNISHED FIT INTO SPACE AVAILABLE.

EXTENSIVE REVISIONS NECESSITATED TO THE CONTRACT DOCUMENTS, OR SUBSTITUTION ACTIONS RELATED TO ANY SPECIFIED PRODUCT NOT ABLE TO BE PROVIDED DUE TO A FAILURE TO COMMENCE WORK, PROCURE PRODUCT OR COORDINATE CONSTRUCTION ACTIVITIES SHALL BE PROVIDED AT MARQUE ENGINEERING'S HOURLY RATES. COSTS SHALL BE BORNE BY THE CONTRACTOR AT NO COST TO THE

26 05 05 - EXISTING CONDITIONS & DEMOLITION

DO NOT REUSE REMOVED ELECTRICAL MATERIALS UNLESS SPECIFICALLY INDICATED ON DRAWINGS. EXISTING WIRING SYSTEMS MAY BE UTILIZED ONLY TO THE EXTENT INDICATED ON DRAWINGS.

IF REQUIRED TO ACCOMMODATE CONSTRUCTION RELATED ACTIVITIES TEMPORARILY REMOVE, STORE IN PROTECTED LOCATION ON SITE, AND REINSTALL CONFLICTING ELECTRICAL EQUIPMENT, LUMINAIRES, OR DEVICES THAT ARE TO REMAIN OR TO BE RELOCATED. WHERE THE TERM "DEMOLITION" IS USED HEREIN, INTERPRET IT TO MEAN "DEMOLITION" OR "SELECTIVE DEMOLITION" WHERE

PROVIDE ELECTRICAL DEMOLITION WORK AS REQUIRED TO ACCOMMODATE PROJECT DEMOLITION AND AS REQUIRED TO ACCOMMODATE NEW CONSTRUCTION. DISCONNECT AND REMOVE WORK TO BE ABANDONED, AND AS REQUIRED TO ACCOMMODATE WORK OF OTHER TRADES, IN AREAS AFFECTED BY THIS PROJECT.

INDICATED, OR WHEN AUTHORIZED OTHERWISE IN WRITING BY OWNER'S REPRESENTATIVE. PROVIDE TEMPORARY SERVICE DURING INTERRUPTIONS TO EXISTING FACILITIES. SCHEDULE MOMENTARY OUTAGES WHEN NECESSARY FOR REPLACING EXISTING WIRING SYSTEMS WITH NEW WIRING SYSTEMS. WHEN THAT "CUTTING-OVER" HAS BEEN SUCCESSFULLY ACCOMPLISHED, REMOVE RELATED WIRING THAT

MAINTAIN EXISTING ELECTRICAL SERVICE AND FEEDERS TO OCCUPIED AREAS AND OPERATIONAL FACILITIES, UNLESS OTHERWISE

CAREFULLY COORDINATE WORK AND SYSTEM SHUTDOWNS IN ADVANCE WITH OWNER'S REPRESENTATIVE, AND WITH AFFECTED TRADES SO THAT NORMAL BUILDING ACTIVITIES AND OTHER CONSTRUCTION TRADES ARE MINIMALLY AFFECTED. PERFORM ELECTRICALLY RELATED CONSTRUCTION WORK, WHICH WILL AFFECT AN OCCUPIED AREA (INCLUDING THOSE WHICH ARE LOCATED OUTSIDE THE IMMEDIATE AREA OF PROJECT WORK) AT SPECIAL TIMES AS DIRECTED BY OWNER'S REPRESENTATIVE IN FIELD.

PROVIDE WORK IN A MANNER THAT ENSURES EXISTING SYSTEMS AND COMPONENTS REMAIN FULLY OPERATIONAL IN OCCUPIED SPACES

PROVIDE AND MAINTAIN TEMPORARY PARTITIONS AND DUST BARRIERS ADEQUATE TO PREVENT THE SPREAD OF DUST AND DIRT TO ADIACENT FINISHED AREAS AND OTHER SYSTEM COMPONENTS, PROTECT ADIACENT INSTALLATIONS DURING CUTTING AND PATCHING OPERATIONS. REMOVE PROTECTION AND BARRIERS AFTER DEMOLITION OPERATIONS ARE COMPLETE.

INSPECT EXISTING ELECTRICAL WORK IN AREAS ACCESSED UNDER THIS PROJECT AND BRING INTO COMPLIANCE WITH CURRENT NFPA 70. THIS APPLIES ONLY TO THE EXTENT THAT SUCH WORK IS UNCOVERED IN THE IMMEDIATE PROJECT AREAS AFFECTED BY CONSTRUCTION ACTIVITIES, AND ONLY TO THE LIMITED EXTENT THAT IT APPLIES TO PRE-EXISTING GENERAL INSTALLATION METHODS SUCH AS MISSING JUNCTION BOX PLATE, OPEN JUNCTION BOX KNOCKOUT, MINOR CONDUIT RE-ANCHORING AND MINOR EXPOSED WIRING/CONNECTIONS. IE MORE EXTENSIVE CODE OR SAFETY VIOLATIONS ARE DISCOVERED. IMMEDIATELY BRING THEM TO THE ATTENTION OF THE OWNER'S REPRESENTATIVE (DETAILED IN WRITING) ALONG WITH PROPOSED COST FOR CORRECTIONS AND IMPACT (IF ANY) ON THE CONSTRUCTION THE FOLLOWING APPLIES TO ELECTRICAL MATERIALS THAT WILL REMAIN OR BE REUSED UNDER THIS PROJECT: PROTECT DURING

- DETERMINE WHICH EXISTING BRANCH CIRCUITS MUST REMAIN ACTIVE. RECONNECT (OR MAINTAIN IN OPERATION WHERE
- APPLICABLE) AND SCHEDULE THEM IN THE PANELBOARD(S). EXISTING BRANCH CIRCUIT AND SYSTEMS CONDUIT, NOT CONFLICTING WITH NEW CONSTRUCTION AND NOT CONFLICTING WITH OVERHEAD OR CEILING CAVITY REQUIREMENTS, MAY BE RE-USED AT THE DISCRETION OF THE ELECTRICAL INSTALLER (AFTER ALL ABANDONED CONDUCTORS AND CABLES HAVE BEEN REMOVED FROM THEM). DO NOT EXCEED NFPA 70 REQUIRED CONDUIT FILL AND DO NOT INSTALL WIRING FED FROM DIFFERENT SOURCES IN COMMON CONDUIT
- COMPLETELY RE-TYPE PANELBOARD DIRECTORIES FOR PANELBOARD(S) AFFECTED BY THIS PROJECT USING ACCURATE "AS-BUILT"
- INFORMATION. WHERE APPLICABLE ENSURE THAT RECONNECTED SHARED NEUTRALS ARE PROPERLY BALANCED WITH THE CORRECT PHASE
- CONDUCTORS. WHERE APPLICABLE, PROVIDE CORRECT COLOR-CODING FOR INSULATION OF RECONNECTED CONDUCTORS IN A MANNER COMPLIANT FOR ALL EXISTING LUMINAIRES SCHEDULED FOR REUSE, REMOVE FROM EXISTING CEILINGS DURING DEMOLITION: PROTECT DURING CONSTRUCTION; CLEAN, SERVICE (IF REQUIRED), RE-LAMP (WITH LAMPS TO MATCH BUILDING STANDARD OR PER THIS SECTION AS

NOTED) AND REINSTALL AT LOCATIONS INDICATED. RE-LAMP LUMINAIRES IMMEDIATELY PRIOR TO OCCUPANCY OF THE FINISHED

 CLEAN COMPONENTS TO BE REUSED INSIDE AND OUT, AND REINSTALL WHERE INDICATED ON DRAWINGS. MODIFY AND EXTEND RELATED EXISTING BRANCH WIRING AND/OR CONTROL WIRING ACCORDINGLY TO INCLUDE CONDUIT, CABLING, ETC. DEMOLITION

DISCONNECT AND REMOVE WORK TO BE ABANDONED, AND AS REQUIRED TO ACCOMMODATE WORK OF OTHER TRADES, IN AREAS AFFECTED BY THIS PROJECT UNLESS SPECIFICALLY NOTED OTHERWISE ON PLANS OR DETERMINED OTHERWISE DURING PRE-DEMOLITION

REMOVE ACCESSIBLE ABANDONED, INACTIVE AND OBSOLETE RACEWAY SYSTEMS. REMOVE ABANDONED, INACTIVE AND OBSOLETE WIRING AND CONTROLS, REMOVE ABANDONED, INACTIVE AND OBSOLETE FOUIPMENT, IUMINAIRES AND DEVICES, ABANDONED. RACEWAYS EMBEDDED IN FLOORS, WALLS, AND CEILINGS MAY REMAIN IF SUCH MATERIALS DO NOT INTERFERE WITH NEW INSTALLATIONS. REMOVE ABANDONED ELECTRICAL MATERIALS ABOVE ACCESSIBLE CEILINGS.

REMOVE RELATED ABANDONED UNUSED RACEWAY BACK TO THE NEAREST RESPECTIVE "UPSTREAM" JUNCTION BOX THAT REMAINS ACTIVE EVEN IF OUTSIDE OF THE CONFINES OF THE PROJECT AREA.

REMOVE ABANDONED UNUSED WIRING BACK TO ITS SOURCE EVEN IF SOURCES ARE OUTSIDE THE CONFINES OF THE PROJECT AREA. EXTEND RACEWAY AND WIRING AS REQUIRED TO ACCOMMODATE NEW OR RELOCATED ELECTRICAL WORK.

LOCATE. IDENTIFY. AND PROTECT ELECTRICAL SERVICES PASSING THROUGH DEMOLITION AREAS AND SERVING OTHER AREAS OUTSIDE THE DEMOLITION LIMITS. MAINTAIN SERVICES TO AREAS OUTSIDE DEMOLITION LIMITS. WHEN SERVICES MUST BE INTERRUPTED, INSTALL TEMPORARY SERVICES FOR AFFECTED AREAS.

IT IS RECOGNIZED THAT THERE MAY BE SOME CONDUIT SYSTEMS RENDERED INACTIVE BY DEMOLITION, CAUSING DISCONNECTION OF "DOWNSTREAM" OUTLETS, ETC. INVESTIGATE THESE TYPES OF CONDITIONS (FOR ALL SYSTEMS) PRIOR TO DEMOLITION, PROVIDE NECESSARY CORRECTIVE ELECTRICAL WORK PRIOR TO DEMOLITION TO ENSURE THAT SUCH "DOWNSTREAM" DEVICES REMAIN PERMANENTLY ACTIVE THROUGHOUT DEMOLITION, DURING NEW CONSTRUCTION, AND AFTER PROJECT COMPLETION.

PERFORM CUTTING AND PATCHING REQUIRED FOR DEMOLITION.

COORDINATE WORK CAREFULLY WITH OWNER PRIOR TO BEGINNING ELECTRICAL DEMOLITION WORK. MAINTAIN (OR RECONNECT IF APPLICABLE) REMAINING WIRING

REMOVE AND RELOCATE WIRING, DEVICES, CONDUIT, ETC. THAT CONFLICT WITH CONSTRUCTION RELATED WORK OF OTHER TRADES AS

NECESSARY TO ACCOMMODATE NEW WORK OF RESPECTIVE TRADE.

PROVIDE ELECTRICAL DISCONNECTIONS, AND RECONNECTIONS WHERE APPLICABLE, FOR EQUIPMENT TO BE REMOVED (OR RELOCATED) BY REFER TO OWNER'S REPRESENTATIVE FOR DISPOSAL INSTRUCTIONS FOR ABANDONED ELECTRICAL MATERIALS REMOVED DURING

DEMOLITION AND THEREAFTER. NEATLY STORE ELECTRICAL MATERIALS THAT THE OWNER ELECTS TO RETAIN AT THE SITE AS DESIGNATED BY THE OWNER'S REPRESENTATIVE. LEGALLY DISPOSE OF MATERIALS THAT THE OWNER ELECTS NOT TO RETAIN.

DISCONNECT AND REMOVE ELECTRICAL MATERIALS DESIGNATED FOR SALVAGE (REMOVAL AND REUSE, OR FOR TURNING OVER TO OWNER) UNDAMAGED. DISCONNECT AND REMOVE WIRING AND "WHIPS" FROM EQUIPMENT TERMINAL POINTS.

CAREFULLY TRANSPORT SALVAGED ELECTRICAL MATERIALS TO A PROTECTED ON-SITE STORAGE LOCATION AS DIRECTED IN FIELD AND NEATLY STORE THEM GROUPED BY SYSTEM TYPE.

LEGALLY DISPOSE OF MATERIALS TO SALVAGED OR RETAINED.

26 05 08 - ELECTRICAL SITE REQUIREMENTS

EXISTING UTILITIES: THE INFORMATION SHOWN CONCERNING EXISTING UTILITIES IS APPROXIMATE. THE LOCATION, SIZES AND OTHER INFORMATION INDICATED IS ONLY AS ACCURATE AS THAT PROVIDED BY THE OWNERS OF THE UTILITIES. THIS INFORMATION IS NOT WARRANTED OR GUARANTEED TO BE COMPLETE OR ACCURATE. THE ENGINEER DOES NOT INDEPENDENTLY VERIFY NOR FIELD LOCATE UTILITIES. THE CONTRACTOR IS RESPONSIBLE TO PHYSICALLY LOCATE AND VERIFY THE HORIZONTAL AND VERTICAL LOCATIONS OF ALL EXISTING UTILITIES, WHETHER SHOWN ON PLANS OR NOT, PRIOR TO BEGINNING CONSTRUCTION.

THE CONTRACTOR SHALL SUPPORT, PROTECT AND RESTORE ALL EXISTING UTILITIES AND THEIR ASSOCIATED ITEMS. PROTECT EXCAVATED OPENINGS WITH SUBSTANTIAL RAILINGS, SIGNAGE, SHORING, AND STEEL ROADWAY PLATES IN STRICT. COMPLIANCE WITH OSHA/NIOSH, WITH LOCAL DEPARTMENT OF TRANSPORATION (DOT) STANDARDS, WITH AUTHORITY HAVING

- JURISDICTION. AND AS DIRECTED BY OWNER'S REPRESENTATION IN FIELD. PROVIDE TRAFFIC DETOURS PER DOT STANDARDS DURING ACTIVE CONSTRUCTION WORK SHIFT TIME PERIODS. PROTECT STEEL ROADWAY PLATES, PROPERLY INSTALLED AND ANCHORED PER DOT STANDARDS. OVER ROADWAY CUTS DURING
- INACTIVE PERIODS. FINISH WORK AFFECTING THE ROADWAYS. AND RESTORE/PAVE ROADWAY CUTS AS QUICKLY AS POSSIBLE AFTER STARTING THOSE

THE CONTRACTOR SHALL NOTIFY THE REGISTERED UTILITY PROTECTION SERVICE AND ALL UTILITY OWNERS HAVING FACILITIES IN THE CONSTRUCTION AREA WHO ARE NOT MEMBERS OF A REGISTERED UNDERGROUND PROTECTION SERVICE.

THE CONTRACTOR SHALL GIVE NOTIFICATION AS REQUIRED BY CODE. AT LEAST TWO WORKING DAYS PRIOR TO COMMENCING CONSTRUCTION OPERATIONS, EXCLUDING SATURDAYS, SUNDAYS AND HOLIDAYS. THE CONTRACTOR SHALL COORDINATE THE WORK WITH THE UTILITY OWNERS UNTIL THE WORK IS COMPLETED. THE CONTRACTOR SHALL PROVIDE THE PROJECT OWNER WITH EVIDENCE OF HAVING NOTIFIED THE UTILITIES AND PROVIDED THEM WITH THE WORK SCHEDULE PRIOR TO CONSTRUCTION COMMENCEMENT. DO NOT USE EXPLOSIVES.

PROTECT STRUCTURES, LITHLITIES, SIDEWALKS, PAVEMENTS, AND OTHER FACILITIES FROM DAMAGE CAUSED BY SETTLEMENT, LATERAL MOVEMENT, UNDERMINING, WASHOUT, AND OTHER HAZARDS CREATED BY EXCAVATION OPERATIONS.

BACKFILL AND FILL MATERIALS: IN GENERAL, USE EXCAVATED MATERIAL FOR BACKFILL, PRIOR TO BACKFILLING, REMOVE ROCK AND GRAVEL LARGER THAN 2 INCHES IN ANY DIMENSION, DEBRIS, WASTE, FROZEN MATERIALS, VEGETABLE MATTER, AND OTHER DELETERIOUS MATTER. PROVIDE PRE-MIXED, FACTORY PACKAGED, NON-STAINING, NON-CORROSIVE, NONGASEOUS GROUT, RECOMMENDED FOR INTERIOR AND EXTERIOR APPLICATIONS. PROVIDE SUB-BASE CONSISTING OF GRADED MIXTURE OF CRUSHED GRAVEL, CRUSHED STONE

TRENCHING: EXCAVATE TRENCHES TO THE UNIFORM WIDTH, SUFFICIENTLY WIDE TO PROVIDE AMPLE WORKING ROOM. EXCAVATE TRENCHES TO DEPTH AND WIDTH INDICATED OR OTHERWISE NECESSARY TO FULFILL PROJECT REQUIREMENTS.

COMPACT EACH LAYER OF BACKFILL OR FILL MATERIAL TO 95% STANDARD COMPACTION.

TOPSOIL AND SEEDING: SEPARATELY STOCKPILE EXCAVATED TOPSOIL ADJACENT TO TRENCH AND UTILIZE IN THE FINAL STAGE OF BACKFILLING. GRADE EXPOSED EARTH AND OTHER ERODIBLE AREAS TO A REASONABLY UNIFORM, AND SATISFACTORY, CROSS SECTION AND SLOPE. AS SOON AS PRACTICABLE

CONCRETE ENCASEMENT: PROVIDE AS INDICATED OR OTHERWISE NECESSARY TO FULFILL PROJECT REQUIREMENTS.

IN GENERAL, UNLESS DIRECTED OTHERWISE IN FIELD, USE THE SIDES OF EXCAVATED TRENCHES AS FORMS FOR CONCRETE ENCASEMENT. DO NOTE REMOVE FORMS FOR 24 HOURS AFTER CONCRETE HAS BEEN PLACED. PROVIDE SUFFICIENT QUANTITY OF FORMS TO ALLOW CONTINUOUS PROGRESS OF WORK. IF REQUIRED FOR SPECIAL APPLICATIONS IN FIELD, PROVIDE FORMS MADE OF STEEL, WOOD, OR OTHER SUITABLE MATERIAL OF SIZE AND STRENGTH TO RESIST MOVEMENT DURING CONCRETE PLACEMENT, AND TO RETAIN HORIZONTAL AND VERTICAL ALIGNMENT UNTIL REMOVAL. CLEAN ALL FORMS AFTER EACH USE AND COAT WITH FORM RELEASE AGENT TO ENSURE SEPARATION FROM CONCRETE WITHOUT DAMAGE. FORM AREAS THAT INVOLVE TERMINATION OF SPARE CONDUITS BELOW GRADE, OR THAT INVOLVE CONTINUATION OF CONDUITS BY OTHERS, ACCORDINGLY TO ACCOMMODATE EASY FUTURE ACCESS TO THE ENDS OF CONDUITS FOR FUTURE EXTENSIONS.

PROVIDE REINFORCEMENT TO INCLUDE WELDED WIRE MESH, REINFORCING BARS, AND JOINT DOWEL BARS IF DEEMED NECESSARY.

DESIGN MIX TO PRODUCE NORMAL-WEIGHT CONCRETE CONSISTING OF PORTLAND CEMENT, AGGREGATE, AIR-ENTRAINING ADMIXTURE, AND WATER TO PRODUCE THE FOLLOWING PROPERTIES:

- AGGREGATE: 3/8" COMPRESSIVE STRENGTH: 3000 PSI, MINIMUM AT 28 DAYS SLUMP RANGE: 7" - 8" (PROVIDE ENOUGH SLUMP TO FLOW TO BOTTOM OF THE FORMATION AND YET NOT BE SO WET AS TO CAUSE
- THE DUCTS TO FLOAT AIR CONTENT: 5% - 8%
- PORTLAND CEMENT: ANSI/ASTM C 150, TYPE 1. DYE: PROVIDE BRIGHT RED DYE, CENTRALLY MIXED

OTHERWISE SPECIFIED

EXPANSION JOINTS: PROVIDE PRE-MOLDED JOINT FILLER FOR EXPANSION JOINTS ABUTTING MANHOLES, CABLE PITS, AND SIMILAR STRUCTURES.

CONCRETE FINISHING: PROVIDE SMOOTH BROOM FINISHED CONCRETE SURFACE BY SCREEDING AFTER STRIKING-OFF AND CONSOLIDATING CONCRETE. PROTECT CONCRETE FROM DAMAGE UNTIL ACCEPTANCE OF WORK

26 05 19 LOW VOLTAGE ELECTRICAL POWER CONDUCTORS AND CABLES FURNISH AND INSTALL ALL NECESSARY CABLE OF THE SIZE AND TYPE INDICATED ON THE DRAWINGS. ALL WIRE SHALL BE COPPER UNLESS

NO CONDUCTOR SMALLER THAN NO. 12 AWG SHALL BE USED UNLESS OTHERWISE INDICATED. IN GENERAL, CONDUCTORS SMALLER

THAN NO. 12 WILL BE PERMITTED ONLY FOR COMMUNICATION, SIGNAL, OR CONTROL CIRCUITS.

PROVIDE THE FOLLOWING MINIMUM AWG CONDUCTOR SIZES FOR GENERAL BRANCH CIRCUITING AND GROUNDS THAT ARE NOT INDICATED ON DRAWINGS. ALL WIRING IS BASED ON USING COPPER CONDUCTORS UNLESS OTHERWISE INDICATED. WHERE APPLICABLE INCREASE AS REQUIRED TO ACCOMMODATE VOLTAGE DROP AND TO ACCOMMODATE SPECIAL CONDITIONS. DO NOT DERATE ANY ICTORS TEMPERATURE RATINGS LISTED BELOW PERTAIN TO BOTH WIRE AND TERMINATIONS.

GROUNDED (NEUTRAL) CONDUCTORS. TEMPERATURE RATINGS LISTED BELOW PERT							
	60 DEG. C RATING	EQUIPMENT GROUNDING					
SOURCE BREAKER/FUSE	AWG WIRE SIZE	AWG WIRE SIZE					
15 AMPERE	#12	#12					
20 AMPERE	#12	#12					
25 AMPERE	#10	#10					
30 AMPERE	#10	#10					
35 AMPERE	# 8	#10					
40 AMPERE	# 8	#10					
45 AMPERE	# 6	#10					
50 AMPERE	# 6	#10					
60 AMPERE	# 4	#10					
70 AMPERE	# 4	#8					
80 AMPERE	# 3	#8					
90 AMPERE	# 2	#8					
100 AMPERE	# 1	#8					

CONDUCTORS SHALL BE CONTINUOUS FROM OUTLET TO OUTLET, NO SPLICES SHALL BE PERMITTED EXCEPT AT OUTLETS. ALL ELECTRICAL CONNECTIONS SHALL BE MADE IN ACCORDANCE WITH NEC.

COLOR CODING IS REQUIRED FOR ALL SERVICE, FEEDER, BRANCH, CONTROL, AND SIGNALING CIRCUIT CONDUCTORS. INSULATION COLOR FOR NEUTRALS SHALL BE WHITE FOR 120 VOLT CIRCUITS. EQUIPMENT GROUNDING CONDUCTORS SHALL BE GREEN. THE COLOR OF THE INSULATION OF THE UNGROUNDED CONDUCTORS SHALL BE AS FOLLOWS:

208Y/120V SYSTEM: BLACK, RED. BLUE AND WHITE (NEUTRAL) 480Y/277V SYSTEM: BROWN, ORANGE, YELLOW AND GRAY (NEUTRAL)

EQUIPMENT GROUNDING: GREEN ALL UNGROUNDED CONDUCTORS OF THE SAME COLOR SHALL BE CONNECTED TO THE SAME UNGROUNDED FEEDER CONDUCTOR.

USE NO WIRE SMALLER THAN NO. 12 AWG, RATED AT 600 VOLTS, FOR POWER AND LIGHTING CIRCUITS AND NO SMALLER THAN NO. 14 FOR CONTROL WIRING. BRANCH CIRCUIT CONDUCTORS FOR 20 AMPERE, 120 VOLT CIRCUITS SHALL BE NO. 12 AWG, WITH CONDUCTOR FROM PANEL BOARD TO THE FIRST OUTLET AS FOLLOWS:

0 - 75 FFFT------#12 AWG 75 -150 FFFT-----#10 AWG 150-250 FFFT----------# 8 AWG 250-350 FEET---------# 6 AWG

ALL JOINTS AND SPLICES SHALL BE MADE MECHANICALLY AND ELECTRICALLY SECURE. ALL SPLICES AND JOINTS SHALL BE MADE WITH APPROVED SOLDERLESS CONNECTORS, PROPERLY INSTALLED

TYPE MC CABLE MAY MAY BE USED FOR SHORT (LESS THAN 6 FEET) FINAL CONNECTIONS ONLY.

26 05 26 GROUNDING AND BONDING FOR ELECTRICAL SYSTEMS

ALL WIRE FOR GROUNDING PURPOSE SHALL BE STRANDED COPPER, OR COPPER CLAD STEEL AS REQUIRED FOR TYPE AND SIZES INDICATED

BUILDING ELECTRODE GROUND RODS SHALL BE 10'-0" LONG X 3/4" DIAMETER (MINIMUM DIMENSIONS). GROUND RODS SHALL BE STEEL WITH A MOLECULARLY BONDED OUTER LAYER OF ELECTROLYTICALLY APPLIED COPPER JACKET OF GALVANIZED STEEL AS REQUIRED. ALL GROUND RODS SHALL BE TESTED WITH PROPER TEST EQUIPMENT FOR ROD TO EARTH RESISTANCE BEFORE CONNECTING GROUND WIRE.

METAL RACEWAYS MAY NOT BE USED FOR EQUIPMENT GROUNDING CONDUCTOR.

PROVIDE A SEPARATE DRIVEN GROUND FOR THE NEUTRAL BUSS ON THE ELECTRICAL DISTRIBUTION SYSTEM.

PROVIDE A SEPARATE DRIVEN GROUND FOR USE AS EQUIPMENT GROUND. TIE DRIVEN GROUND TO INCOMING CITY WATER LINE THROUGH A #4/0 BAR STRANDED COPPER CONDUCTOR. USE APPROVED GROUND CLAMPS.

PROPERLY GROUND ALL MOTORS, TRANSFORMERS, EQUIPMENT, CONDUITS, SWITCH GEAR, ETC.

GROUND ALL LUMINAIRES BY INSTALLING A SEPARATE GREEN GROUND WIRE IN ANY FLEXIBLE CONDUIT BETWEEN OUTLET BOX AND

26 05 29 HANGERS AND SUPPORTS FOR ELECTRICAL SYSTEMS

CONDUIT SHALL BE SUPPORTED BY APPROVED STRAPS. FASTENERS AND HANGERS, HANGERS SHALL BE SUSPENDED FROM RODS. PERFORATED STRAPS WILL NOT BE ACCEPTABLE. FASTENERS SHALL BE LEAD EXPANSION SHIELDS IN BLOCK OR CONCRETE, TOGGLE BOLTS IN HOLLOW WALLS, MACHINE SCREWS ON METAL SURFACES AND WOOD SCREWS ON WOOD CONSTRUCTION.

ALL CONDUIT SHALL RE SUPPORTED INDEPENDENTLY FROM ALL OTHER RUIL DING SYSTEMS AND SHALL RE SUPPORTED DIRECTLY FROM STRUCTURAL COMPONENTS. AT BUILDING EXPANSION JOINTS AND WHERE DEFLECTION IS EXPECTED. CONDUITS SHALL BE PROVIDED WITH EXPANSION FITTINGS WITH BONDING JUMPERS, CONDUITS PASSING THROUGH STRUCTURAL MEMBERS SHALL BE PROVIDED WITH STUB AND COUPLING OR SLEEVE IN THE MEMBER. WHERE MOISTURE CONDITIONS ARE ENCOUNTERED, A HOLE SHALL BE DRILLED AT THE LOWEST POINT IN THE CONDUIT RUN.

26 05 33 RACEWAYS AND BOXES FOR ELECTRICAL SYSTEMS

CONCEAL CONDUIT AND EMT WITHIN FURNISHED WALLS, CEILINGS, AND FLOORS UNLESS OTHERWISE INDICATED. INSTALL CONDUITS PARALLEL OR PERPENDICULAR TO BUILDING LINES.

INTERIOR CONDUIT SHALL BE OF SUFFICIENT SIZE AND INSTALLED SO THE REQUIRED NUMBER OR CONDUCTORS CAN BE INSERTED OR REMOVED WITHOUT INJURY TO, OR EXCESSIVE STRAIN UPON, THE INSULATION. THE MINIMUM CONDUIT SIZE SHALL BE 3/4" UNLESS

CONDUITS SHALL BE RUN CONTINUOUS FROM OUTLET TO OUTLET AND SHALL BE FASTENED TO ALL BOXES AND CABINETS WITH DOUBLE LOCKOUTS. TO PROVIDE CONTINUITY OF GROUND, AND A BUSHING. THE FULL NUMBER OF THREADS MUST PROJECT BEYOND LOCKOUT IN BOXES AND CABINETS TO ALLOW THE BUSHING TO BUTT UP TIGHT AGAINST THE END OF THE CONDUIT.

CONDUIT RUN EXPOSED SHALL RUN PARALLEL, OR PERPENDICULAR TO WALLS, CEILINGS, OR PRINCIPAL FRAMING MEMBERS. IT IS REQUIRED THAT ALL CONDUIT BE INSTALLED TO REFLECT NEAT, CAREFUL WORKMANSHIP THROUGHOUT THE JOB. CONDUIT WHICH HAS BEEN CRUSHED, DAMAGED, OR DEFORMED IN ANY WAY SHALL NOT BE INSTALLED IN THE JOB. CONDUIT SHALL BE INSTALLED IN SUCH A MANNER AS TO INSURE AGAINST TROUBLE FROM COLLECTION OF TRAPPED CONDENSATE, AND ALL RUNS OF CONDUIT SHALL BE FREE OF

ALL CONDUIT HANGERS AND SUPPORTS SHALL BE RIGIDLY FASTENED TO THE BUILDING STRUCTURE. NO CONDUIT SHALL BE SUPPORTED FROM DUCTWORK, PIPING, OR CEILING GRID SYSTEMS.

PROVIDE FIRE SEALS WHEREVER CONDUIT PENETRATES FIRE WALLS, CEILING OR RATED FLOOR SLABS.

RIGID STEEL CONDUIT SHALL BE USED FOR ALL CONDUIT RUNS INSTALLED IN CONCRETE SLARS. IN ALL POLIRED CONCRETE CONSTRUCTION AND ALL APPLICATIONS INSIDE BUILDING REQUIRING 2" OR LARGER IN SIZE. CONDUIT SHALL BE SUPPORTED AT INTERVALS NOT-TO-EXCEED 7 FEET FOR 3/4" CONDUIT, 8 FEET INTERVALS FOR CONDUIT ON 1" TO AND INCLUDING 2", AND 10 FEET FOR CONDUITS 2-1/2" OR LARGER.

AND BRANCH CIRCUITS IN PARTITIONS. ABOVE CEILING. AND WHERE CONDUIT RUN IS EXPOSED. CONDUIT SHALL BE SUPPORTED AT INTERVALS NOT-TO-EXCEED 7 FEET FOR 3/4" CONDUIT. 8 FEET INTERVALS FOR CONDUIT 1" TO AND INCLUDING 2". ELECTRICAL METALLIC TUBING (THIN WALL) MAY BE USED FOR SWITCH LEGS (EXCEPT IN POURED CONCRETE WALLS) AND BRANCH CIRCUITS IN PARTITIONS, ABOVE CEILINGS, AND WHERE CONDUIT RUN IS EXPOSED. CONDUIT SHALL BE SUPPORTED AT INTERVALS

NOT-TO-EXCEED 7 FEET FOR 3/4" CONDUIT, 8 FEET INTERVALS FOR CONDUIT 1" TO AND INCLUDING 1-1/2". EMT LARGER THAN 1-1/2"

RIGID CONDUIT (ALUMINUM) SHALL NOT BE INSTALLED IN POURED CONCRETE. ALUMINUM CONDUIT MAY BE USED FOR SWITCH LEGS

WILL NOT BE PERMITTED PLASTIC CONDUIT (PVC): PLASTIC CONDUIT MAY BE USED FOR UNDERGROUND CONDUIT RUNS OUTSIDE BUILDING AND BELOW FLOOR SLAB. UNDERGROUND CONDUIT RUNS OUTSIDE BUILDING SHALL BE A MINIMUM OF 2'-6" BELOW GRADE. CONDUIT RUN BELOW FLOOR

FLEXIBLE CONDUIT SHALL BE USED BETWEEN OUTLET BOXES IN HUNG OR FURRED CEILINGS AND RECESSED LIGHTING FIXTURES. FLEXIBLE CONDUIT SHALL NOT EXCEED 6 FEET IN LENGTH.

USED FOR FINAL CONNECTIONS TO ALL MOTORS OR DEVICES WHICH DO OR MAY VIBRATE. LIQUID TIGHT FLEXIBLE CONDUIT SHALL NOT PROVIDE SEALING BUSHINGS IN ALL UNDERGROUND CONDUITS AS REQUIRED TO PREVENT THE ENTRY OF MOISTURE INTO ELECTRICAL

LIQUID TIGHT FLEXIBLE CONDUIT SHALL BE USED FOR FINAL CONNECTIONS TO ALL MOTORS. LIQUID TIGHT FLEXIBLE CONDUIT SHALL BE

PROVIDE CONDUIT EXPANSION FITTINGS WHERE CONDUIT CROSSES A BUILDING EXPANSION JOINT, AND IN ALL STRAIGHT CONDUIT RUNS

ALL OUTLET, SWITCH, JUNCTION AND PULL BOXES SHALL BE MADE OF CODE GALVANIZED STEEL COMPLETE WITH RINGS AND SCREW COVER PLATES AND LOCATED WHERE SHOWN AND NOTED ON DRAWINGS. WHERE CONDUIT IS CONCEALED, BOXES SHALL NOT BE LESS THAN 4" SOUARE X 1-1/2" DEEP. ALL BOXES SHALL BE EQUIPPED WITH PROPER COVERS TO BRING FLUSH WITH FINISHED WALL SURFACE.

ALL BOXES FOR CONCRETE WORK SHALL BE OF TYPE ESPECIALLY DESIGNED FOR INSTALLATION IN CONCRETE.

USE GANG BOXES WHERE MORE THAN ONE DEVICE IS TO BE INSTALLED AT THE SAME LOCATION.

PROVIDE OUTLET BOX ACCESSORIES AS REQUIRED FOR EACH INSTALLATION, INCLUDING MOUNTING BRACKETS, WALLBOARD HANGERS, EXTENSION RINGS, FIXTURE STUDS, CABLE CLAMPS, AND METAL STRAPS FOR SUPPORTING OUTLET BOXES, COMPATIBLE WITH OUTLET BOXES BEING USED AND MEETING REQUIREMENTS OF INDIVIDUAL WIRING SITUATIONS.

LONG RUNS. PULL BOXES LOCATED IN FLOORS SHALL BE FLUSH WITH FINISHED FLOOR, AND OF CAST WROUGHT IRON, ALUMINUM, OR BRONZE WITH SEALED WATERPROOF COVER. CONDUIT ENTRANCES SHALL BE THREADED PROVIDE CORROSION RESISTANT CAST METAL WEATHERPROOF OUTLET WIRING BOXES. OF THE TYPE, SHAPE, AND SIZE REQUIRED FOR

PULL BOXES (NOT SHOWN ON THE CONTRACT DRAWINGS) SHALL BE INSTALLED AS REQUIRED TO FACILITATE PULLING OF CONDUCTORS ON

CONFIGURED FOR EACH APPLICATION, INCLUDING FACE PLATE GASKET AND CORROSION PROOF FASTENERS. PROVIDE WATERPROOF OUTLETS FOR INTERIOR AND EXTERIOR LOCATIONS EXPOSED TO WEATHER OR SUBJECT TO FREQUENT WASHING.

EACH APPLICATION, WITH THREADED CONDUIT ENDS, CAST METAL FACE PLATE WITH SPRING-HINGE WATERPROOF CAP, SUITABLE

SECURE BOXES RIGIDLY TO THE SUBSTRATE UPON WHICH THEY ARE BEING MOUNTED, OR SOLIDLY EMBED BOXES IN CONCRETE OR

SLAB SHALL BE A MINIMUM OF 12" BELOW FLOOR SLAB.

26 05 53 IDENTIFICATION FOR ELECTRICAL SYSTEMS PROVIDE MANUFACTURERS STANDARD SELF-ADHESIVE VINYL TAPE NOT LESS THAN 3 MILS THICK BY 1-1/2" WIDE. INSTALL ON ALL CONCEALED RACEWAYS AT CONNECTION TO ALL JUNCTION BOXES, PULL BOXES, EQUIPMENT, WALL/FLOOR/ROOF PENETRATIONS, ETC.

PROVIDE CIRCUIT IDENTIFICATION BANDS FOR ALL CABLES AND CONDUCTORS. PROVIDE ON ALL CONDUCTORS OF ALL SYSTEMS. INSTALL ENGRAVED PLASTIC-LAMINATE SIGN ON ELECTRICAL EQUIPMENT, INCLUDING PANELBOARDS, DISCONNECTS, STARTERS, CONTROL PANELS, ETC. PROVIDE SINGLE LINE OF TEXT, 1/2" HIGH LETTERING, ON 1-1/2" HIGH SIGN (2" HIGH WHERE 2 LINES ARE REQUIRED), WHITE

PROVIDE ALL NECESSARY ELECTRICALLY RELATED WORK AS REQUIRED TO RENDER ALL MECHANICAL EQUIPMENT (INCLUDING PLUMBING, HEATING, VENTILATING AND AIR CONDITIONING EQUIPMENT) FULLY OPERATIONAL AND FULLY COMPLIANT WITH ALL LOCAL AND NATIONAL CODES. THIS INCLUDES, PRIOR TO ORDERING MATERIALS OR COMMENCING WITH ROUGH-IN, REVIEWING EQUIPMENT SUBMITTAL DATA AND COORDINATING WITH INSTALLING CONTRACTORS TO ENSURE THE CORRECT SIZE, RATING AND QUANTITY OF CONDUCTORS ARE PROVIDED.

26 24 16 PANELBOARDS

PROVIDE PANEL BOARDS AS SHOWN ON THE DRAWINGS. PANEL BOARDS SHALL BE DEAD FRONT EQUIPPED WITH THERMAL MAGNETIC MOLDED CASE CIRCUIT BREAKERS, OF FRAME AND TRIP RATINGS AS SHOWN ON THE PANEL BOARDS SCHEDULE. PANEL BOARDS SHALL BE MANUFACTURED IN ACCORDANCE WITH THE LATEST NEMA STANDARDS AND SHALL BE LISTED. BY UL AND BEAR UL LABEL. ALL PANEL BOARDS SHALL BE OF ONE MANUFACTURER.

PANELBOARDS, MAIN BUSS, MAIN LUGS, AND/OR MAIN BREAKER SHALL BE RATED AS NOTED ON PANEL BOARD SCHEDULES. CURRENT DENSITY SHALL BE IN ACCORDANCE WITH UL REQUIREMENTS. BUSS MOUNTING FOR CIRCUIT BREAKERS SHALL BE BOLTED CONNECTIONS AND ACCOMMODATE ANY COMBINATION OF CIRCUIT BREAKER UNITS WITHOUT FURTHER MODIFICATIONS. THE COMPLETE PANEL BOARD, INCLUDING MAIN CIRCUIT BREAKER, BUSS AND LUGS, BRANCH CIRCUIT BREAKERS, AND CONNECTION SHALL BE PROPERLY DESIGNED AND UL LISTED TO WITHSTAND THE EFFECT OF THE AVAILABLE REQUIRED SHORT CIRCUIT CURRENT.

MATERIALS: ALL PANEL BOARDS SHALL BE MOUNTED IN CODE GAUGE GALVANIZED STEEL CABINETS, HAVING HINGED DOOR. EACH DOOR SHALL BE EQUIPPED WITH A LATCH AND LOCK. ALL LOCKS ON ALL PANEL BOARD CABINET DOORS ON THIS PROJECT SHALL ACCEPT A COMMON KEY FURNISH TWO KEYS WITH FACH LOCK

FOR DETAILS CONCERNING THE NUMBER AND SIZE OF CIRCUIT BREAKERS, SIZE OF MAINS, SIZE AND LOCATION OF LUGS, AND WHETHER SURFACE OR FLUSH MOUNTED. REFER TO PROJECT PANEL BOARD SCHEDULES ON THE CONTRACT DRAWINGS.

CABINET SHALL BE SIZED TO PROVIDE WIRING GUTTERS AT SIDES, TOP AND BOTTOM TO ACCOMMODATE THE NECESSARY CONDUCTORS PROVIDE ON THE INSIDE OF THE DOOR FACE OF EACH PANEL BOARD CABINET, AN ACCURATE TYPEWRITTEN CIRCUIT DIRECTORY

PROTECTED BY GLASS OR CLEAR PLASTIC. HANDWRITTEN OR HAND PRINTED DIRECTORIES WILL NOT BE ACCEPTED. THE CONTRACTOR IS INSTRUCTED THAT THE FINAL TYPED DIRECTORY SHALL BE MADE AFTER THE PERMANENT ROOM NUMBERS ARE INSTALLED ON THE DOORS, AND THE DIRECTORIES SHALL LIST THESE NUMBERS RATHER THAN THE ROOM NUMBERS USED ON THE CONSTRUCTION DRAWINGS.

ALL PANEL BOARDS SHALL HAVE ENGRAVED NAME TAGS ATTACHED TO COVER INDICATING PANEL NUMBER AND VOLTAGE. ANCHOR ENCLOSURES FIRMLY TO WALLS AND STRUCTURAL SURFACES, ENSURING THAT THEY ARE PERMANENTLY AND MECHANICALLY

INSTALL ALL PANEL BOARDS WITH THE TOP 6'-6" ABOVE FINISHED FLOOR.

SCHNEIDER ELECTRIC. EATON, GE BY ABB, OR SIEMENS.

DISTRIBUTION PANEL BRANCH BREAKERS SHALL BE SELECTED TO PROVIDE SERIES RATING AS NECESSARY FOR AVAILABLE FAULT CURRENT. ACCEPTABLE MANUFACTURERS: SUBJECT TO COMPLIANCE WITH REQUIREMENTS, PROVIDE PRODUCTS BY ONE OF THE FOLLOWING:

26 27 26 WIRING DEVICES

SIEMENS, OR EATON.

ALL WIRING DEVICES SHALL BE UL LISTED, COMMERCIAL SPECIFICATION GRADE.

SWITCHES IN THE SAME LOCATION SHALL BE GANGED BEHIND A SINGLE PLATE.

DUPLEX RECEPTACLES SHALL BE 20 AMP., 125 VOLT, 3 WIRE GROUNDING TYPE. PROVIDE SMOOTH THERMOPLASTIC COVER PLATE AND MATCHING SCREWS. DEVICES AND COVER PLATES SHALL MATCH ADJACENT ARCHITECTURAL FINISHES UNLESS SPECIFICALLY NOTED OTHERWISE, APPROVED PRODUCTS: HUBBELL, LEVITON, BRYANT OR EQUAL.

WEATHERPROOF RECEPTACLES SHALL BE DUPLEX, 20 AMP., 125 VOLT, GROUND FAULT 3 WIRE GROUNDING TYPE WITH WEATHERPROOF COVER. APPROVED PRODUCTS: HUBBELL, LEVITON, BRYANT OR EQUAL.

USB RECEPTACLES SHALL BE DUPLEX. 20 AMP., 125 VOLT, GROUND FAULT 3 WIRE GROUNDING TYPE WITH TWO VERTICAL USB PORTS WITH A MINIMUM OF 3 6A CHARGING CAPACITY AND TWO 20A RATED OUTLETS. APPROVED PRODUCTS: HUBBELL LEVITON, BRYANT OR FOLIAL

ARE HUBBELL, LEVITON, BRYANT OR EQUAL. THREE-WAY SWITCHES - APPROVED PRODUCTS HUBBELL, LEVITON, BRYANT OR EQUAL. DIMMER SWITCHES SHALL BE COMPATIBLE WITH LIGHTING TO BE CONTROLLED (I.E. - 120V LINE OR 0-10V LOW VOLTAGE) AND SHALL BE RATED FOR THE LIGHTING LOAD INDICATED. APPROVED PRODUCTS ARE LEVITON, LUTRON, HUBBELL, OR EQUAL.

WALL SWITCHES SHALL BE 20 AMP., 120-277 VOLT, QUIET, HIGH CAPACITY, TOGGLE TYPE. SINGLE POLE SWITCHES - APPROVED PRODUCTS

WALL PLATES FOR SWITCHES, TELEPHONE OUTLETS AND OTHER SPECIAL OUTLETS SHALL MATCH THE WALL PLATES PREVIOUSLY SPECIFIED WITH THE RECEPTACLES. ALL PLATES IN EACH ROOM SHALL MATCH. APPROVED PRODUCTS: HUBBELL, LEVITON, BRYANT OR EQUAL. DISCONNECT SWITCHES SHALL BE HEAVY DUTY, SINGLE THROW DISCONNECT SWITCHES. ENCLOSURE SHALL BE NEMA 1 INDOOR AND NEMA 3R (RAIN TIGHT) ON EXTERIOR OF BUILDING UNLESS SPECIFICALLY NOTED ELSEWHERE IN THE CONTRACT DRAWINGS. DISCONNECT SWITCHES LOCATED ON THE EXTERIOR OF THE BUILDING IN AN AREA ACCESSIBLE TO THE PUBLIC OR SUBJECT TO VANDALISM SHALL BE CAPABLE OF BEING LOCKED IN THE CLOSED (ON) POSITION. THE AMPERE RATING, FUSIBLE OR NOT FUSIBLE AND VOLTAGE CHARACTERISTICS SHALL BE AS SHOWN ON THE CONTRACT DRAWINGS. APPROVED PRODUCTS: SQUARE D COMPANY, GE BY ABB,

INSTALLATION OF WIRING DEVICES: OUTLET HEIGHTS GIVEN BELOW, OR AS SHOWN ON DRAWINGS, ARE TO THE CENTER OF THE OUTLET BOX. IN UNPLASTERED MASONRY WALLS WHERE OUTLETS ARE NOT DIMENSIONED, ADJUST HEIGHT TO THE NEXT HIGHER COURSE, AND ADJUST LOCATION TO THE NEAREST CENTER OF THE MASONRY UNIT.

TESTING: TEST WIRING DEVICES TO ENSURE ELECTRICAL CONTINUITY OF GROUNDING CONNECTIONS, AND AFTER ENERGIZING CIRCUITRY, TO DEMONSTRATE COMPLIANCE WITH REQUIREMENTS.

ALL FUSES SHALL BE OF THE SAME MANUFACTURER. SUBJECT TO COMPLIANCE WITH REQUIREMENTS, PROVIDE FUSES OF ONE OF THE

PROVIDE FUSES OF TYPES, SIZES, RATINGS, AND AVERAGE TIME-CURRENT AND PEAK LET-THROUGH CURRENT CHARACTERISTICS

INDICATED. WHICH COMPLY WITH MANUFACTURER'S STANDARD DESIGN. MATERIALS. AND CONSTRUCTED IN ACCORDANCE WITH PUBLISHED PRODUCT INFORMATION. AND WITH INDUSTRY STANDARDS AND CONFIGURATIONS. PROVIDE FACTORY FUSE IDENTIFICATION LABELS, INSTALLED ON THE INSIDE OF THE DOOR OF EACH SWITCH INDICATING TYPE AND SIZE OF

EACH FUSE SHALL BE CLEARLY FACTORY MARKED WITH CLASSIFICATION, CHARACTERISTICS, AMPERE RATINGS, VOLTAGE RATINGS, ETC. FUSES SHALL NOT BE SHIPPED INSTALLED IN SWITCHES NOR SHALL THEY BE INSTALLED IN THE EQUIPMENT UNTIL THE EQUIPMENT UNTIL THE EQUIPMENT IS READY TO BE ENERGIZED.

PRIOR TO INSTALLING FUSES FOR PROTECTION OF SPECIFIC EQUIPMENT, MOTORS, ETC., VERIFY RECOMMENDED FUSE SIZE/TYPE IN FIELD

FROM RESPECTIVE EQUIPMENT MANUFACTURER. IF A CONFLICT IN FUSE SIZE/TYPE RESULTS BETWEEN MANUFACTURER'S RECOMMENDATIONS AND ABOVE SPECIFICATIONS, CONTACT ENGINEER.

FUSES INSTALLED. FOR TYPES AND RATINGS REQUIRED.

FOLLOWING: BUSSMAN, LITTELFUSE, SHAWMUT

DIVISION 27 COMMUNICATIONS

27 13 01 COMMUNICATION INFORMATION TECHNOLOGY SYSTEMS

THE OWNER SHALL MAKE ARRANGEMENTS WITH THE DATA COMMUNICATIONS AND/OR TELEPHONE COMPANY FOR INSTALLATION OF THE DATA COMMUNICATION AND/OR TELEPHONE EQUIPMENT AND WIRING. INSTALL A FISH WIRE IN ALL EMPTY CONDUITS TO FACILITATE PULLING OF WIRE BY UTILITY COMPANY.

PROVIDE STANDARD DEVICE BOXES AND COVER PLATES INSTALLED IN WALLS, FLOOR AND CEILINGS.

TO THE DATA/TELEPHONE OUTLET LOCATION. PROVIDE CONDUIT WITH SWEEP BENDS AND PULL-STRING.

PROVIDE J-HOOK SYSTEMS COMPLETE WITH NECESSARY FITTINGS. AND ACCESSORIES AS REQUIRED TO MAKE COMPLETE AND CONTINUOUS SYSTEMS. PROVIDE J-HOOK SYSTEM COMPONENTS THAT ARE PLENUM-RATED (REGARDLESS OF WHETHER OR NOT AIR PLENUM CEILINGS EXIST ON THE PROJECT). PROVIDE J-HOOK SUPPORT AT FOUR FOOT INTERVALS AND AT OFFSETS. ROUTE J-HOOKS ABOVE CEILINGS THROUGH CORRIDORS AND SIMILAR OPEN AREAS WHEREVER POSSIBLE TO MINIMIZE ABOVE-CEILING WALL PENETRATIONS. SECURELY ANCHOR (MECHANICAL, NOT ADHESIVE) J-HOOKS DIRECTLY TO STRUCTURAL COMPONENTS OF THE BUILDING. DO NOT ANCHOR TO DUCTWORK, CONDUIT, PIPING, FIXTURES, EQUIPMENT, CEILING SUPPORTS (RODS, WIRES, T-BARS), ETC. STRICTLY ADHERE TO FACTORY LOAD CAPACITIES.

PROVIDE (1) 3/4" NON-METALLIC CONDUIT IN ALL WALLS WHERE THE CABLING DROPS DOWN RACEWAY PATH FROM THE CEILING ABOVE

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