


CERTIFICATION

Construction Documents

COhatch - Leader Building

132 Elder St, Cincinnati,  
Ohio, 45202

Project No.: 2120  
Drawn By: BML  
Checked By: BLE  
Scale: See Drawing  
Issue Date: November 18, 2022

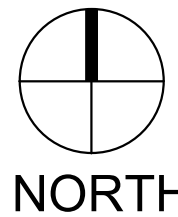

**PLAN NOTES** (X)


- A REMOVE & REPLACE EXISTING, HEADERED, NOTCHED OR BOWED ROOF JOISTS W/ 2x6 JOISTS @ 16" O.C. (MIN WOOD GRADE IS #1 SPR-PINE-FIR). ROOF DECK SHALL BE 3/4" PLYWOOD.
- B REMOVE & REPLACE EXISTING, HEADERED, NOTCHED OR BOWED ROOF JOISTS W/ DOUBLE 2x6 JOISTS @ 16" O.C. (MIN WOOD GRADE IS #1 SPR-PINE-FIR). ROOF DECK SHALL BE 3/4" PLYWOOD.
- C REMOVE & REPLACE EXISTING, HEADERED, NOTCHED OR BOWED ROOF JOISTS W/ DOUBLE 1 3/4"x5 1/2" LVLs @ 16" O.C. ROOF DECK SHALL BE 3/4" PLYWOOD.
- D NOT USED
- E SISTER 1 3/4"x5 1/2" LVL TO NEAREST EXIST ROOF JOIST @ NEW RTU LOCATIONS.
- F SISTER 1 3/4"x5 1/2" LVL TO SIDE OF ALL EXIST JOISTS (APPROX 16" O.C.)
- G SISTER NEW 2x6 JOIST TO EXIST FIRE DAMAGED JOIST. REMOVE & REPLACE FIRE DAMAGED DECK W/ 3/4" PLYWOOD.

**ROOF FRAMING PLAN**

1/4" = 1'-0"

**NOTES:**

1. BEAMS & JOIST TO BE EQUALLY SPACED UNO
2. \* VERIFY DIMENSION W/ ARCH
3. SEE 5/55.03 FOR LINTELS MARKED LX.
4. PROVIDE STEEL LINTEL FOR MEP PENETRATION. SEE MEP DWG'S FOR SIZE & LOCATION OF DUCT. SEE 5/55.03 FOR LINTEL SCHEDULE.

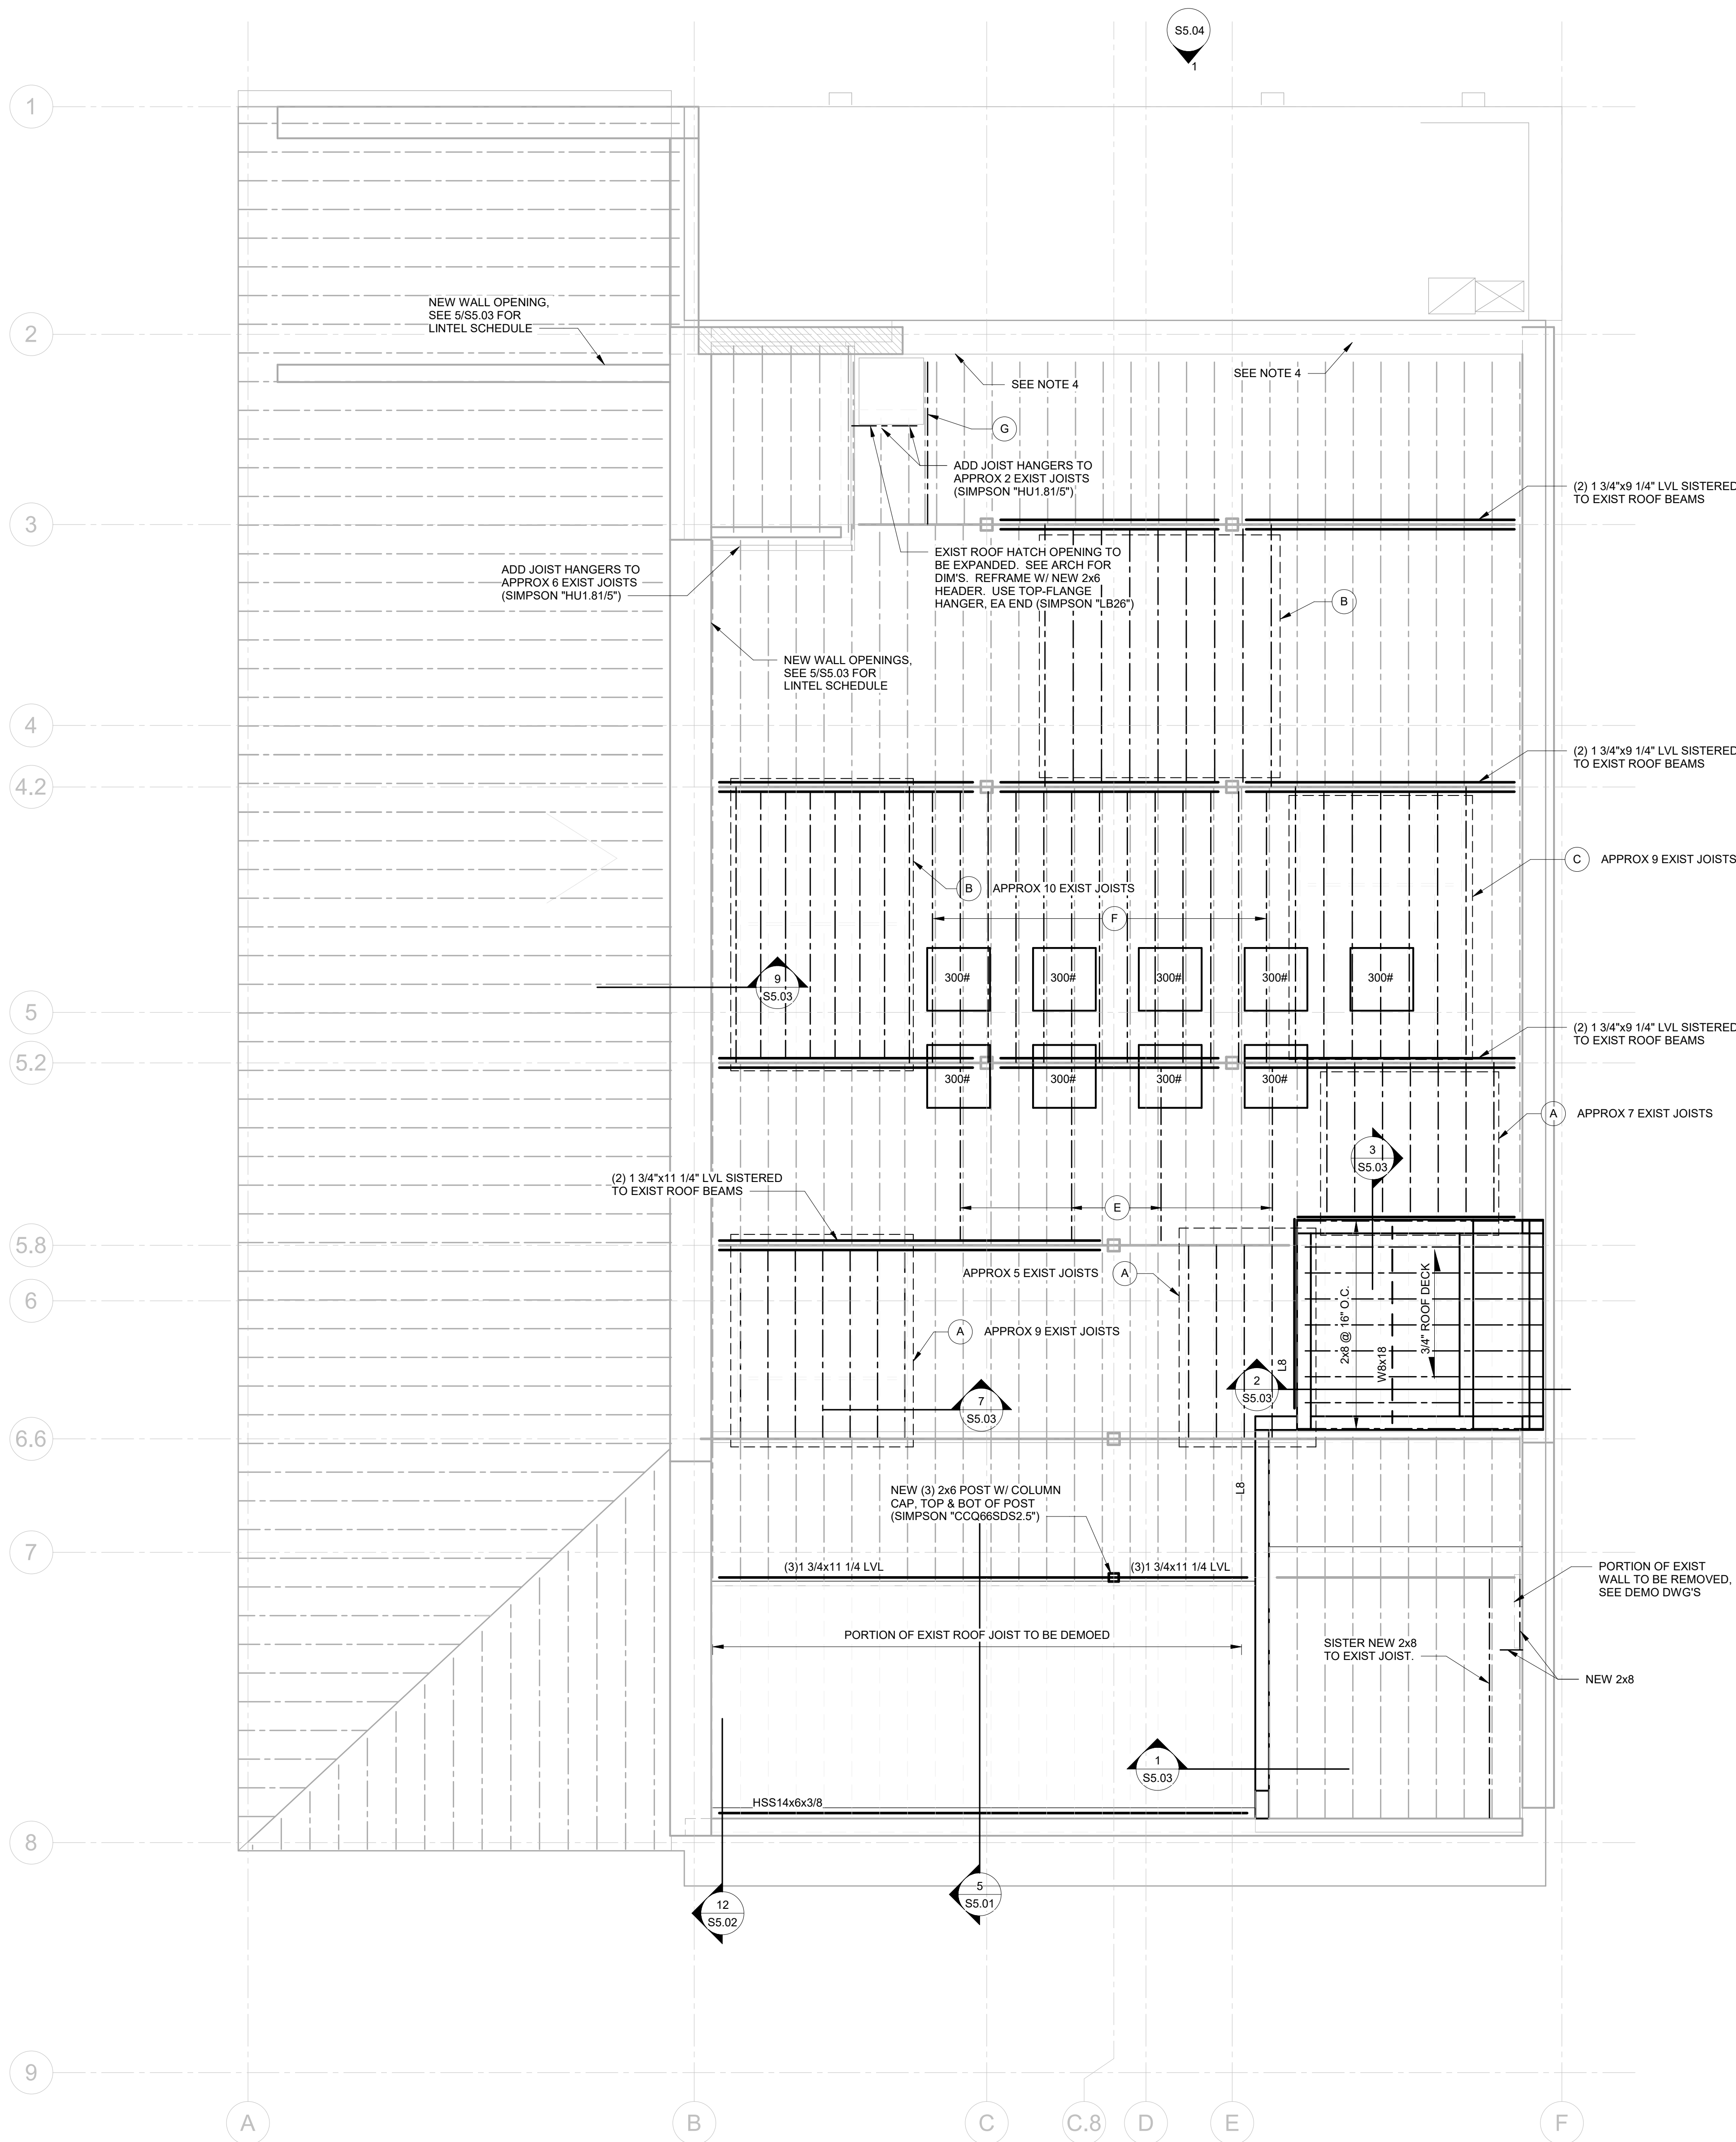

ROOF FRAMING PLAN

**S4.01**